

October 31, 2023

## BID MEMO 02

## Saints - Cafeteria & Viewing Area

## 23.10.09 CD Set

Pleas acknowledge receipt of all Bid Memos and/or Addenda on your bid.

Bid Due: Friday, November 3, 2023 at 2:00 p.m.

## SUPPLEMENTAL INFORMATION & ATTACHMENTS

- 1. Revised Drawings Sheets (31 ea)
- 2. Specification Section 05 7000 Decorative Metal
- 3. Saints Cafeteria and Viewing RFI Log 23.10.31
- 4. Revised Bid Form: Saints Cafeteria and Viewing Bid Form 23.10.31 BM02



October 31, 2023

## WOODWARD PROPOSAL FORM

Saints - Cafeteria & Viewing Area

<u>CD Set</u>

| Company Name          |   |                      |             |      |
|-----------------------|---|----------------------|-------------|------|
| Contact Name          |   |                      |             |      |
| Contact Email         |   |                      |             |      |
| Date Submitted        |   |                      |             |      |
| F                     | Please submit this bid form in addition to your sta | ndard company form o | f proposal. |      |
| Acknowledge receipt   | t of the following bid memos / addenda              | listed below:        | Yes         | 🗌 No |
| Bid Memo / Rev 01 - 2 | 23.10.25  |                      |             |      |
| Bid Memo / Rev 02 - 2 | 23.10.31  |                      |             |      |
|                       |   |                      |             |      |
|                       |   |                      |             |      |
|                       |   |                      |             |      |
| Base Bid              |   |                      |             |      |
|                       |   |                      |             |      |
| Alternate 01 (Mecha   | nical Equipment Screen on Roof)                     |                      |             |      |
|                       |   |                      |             |      |
| Anticipated Construc  | ction Duration                                      |                      |             |      |
|                       |   |                      |             |      |
| Long Lead Material 7  | Times   |                      |             |      |
|                       |   |                      |             |      |
| Anticipated Required  | I Lay Down Area Size                                |                      |             |      |

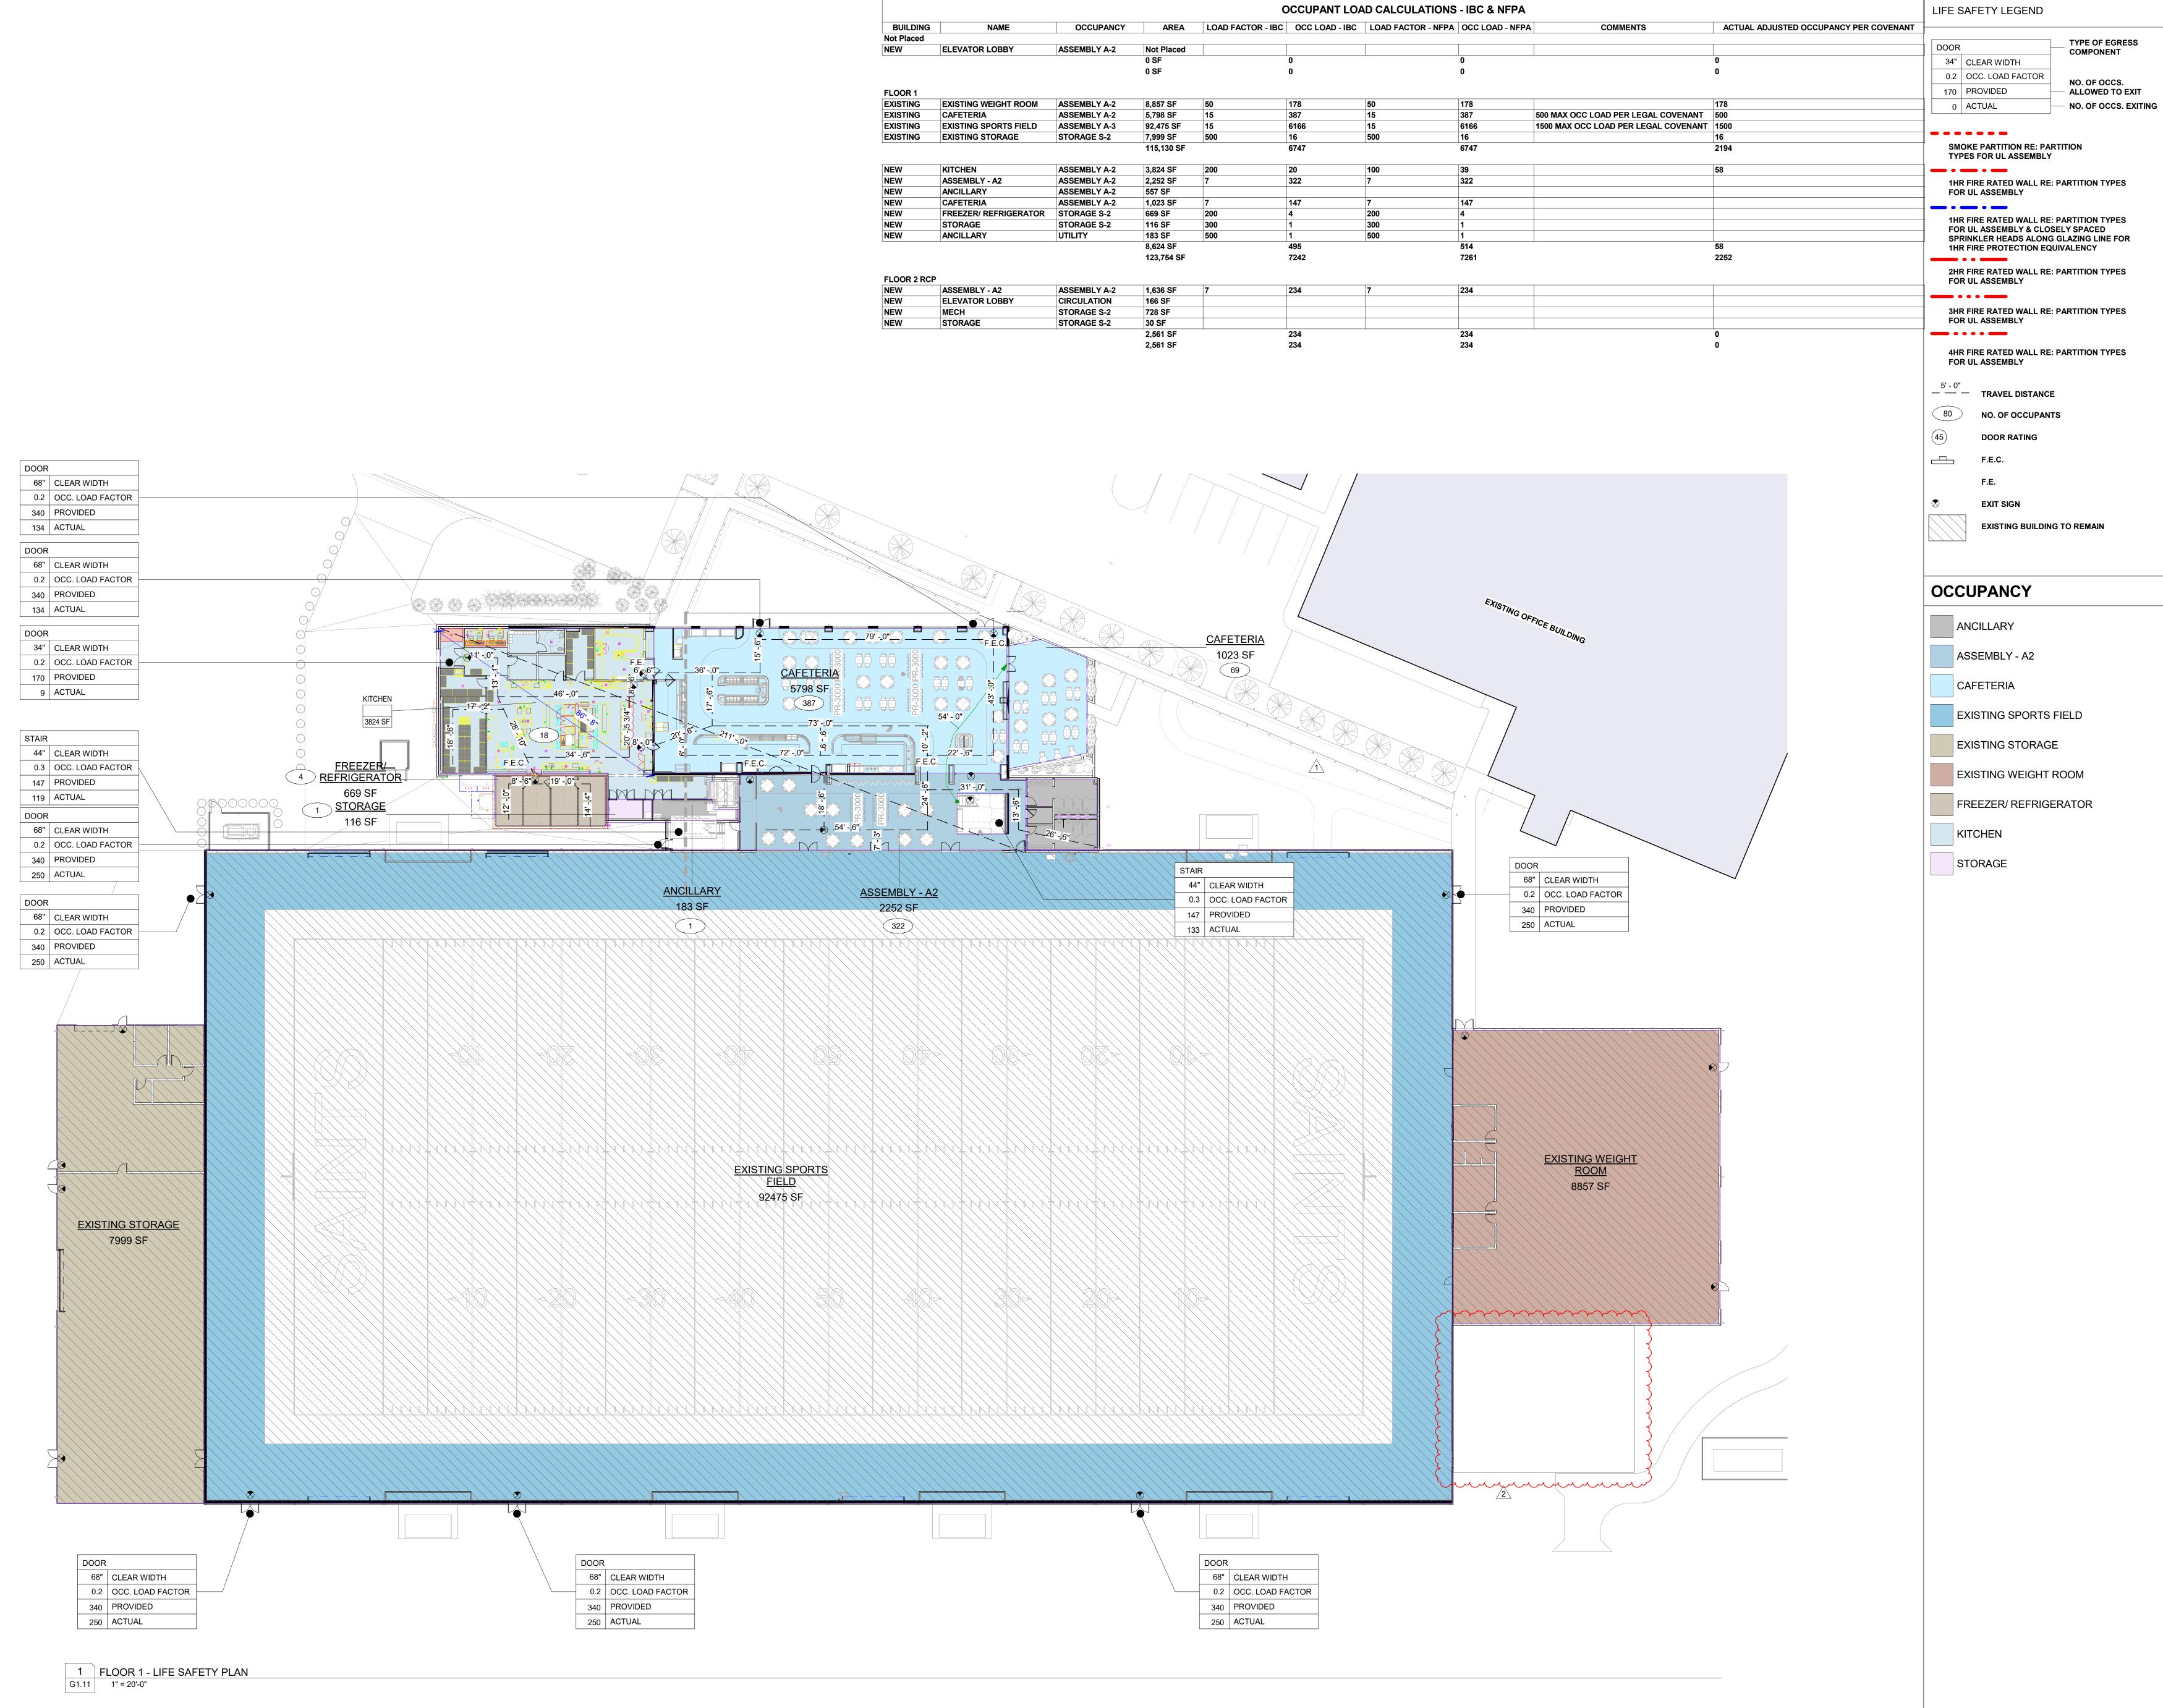
### woodward

RFI LOG

| No. | Spec / Detail<br>Reference | Item   | Originator | Status | Date Sent | Date Returned | Days | Response  |
|-----|----------------------------|--|------------|--------|-----------|---------------|------|---|
| 1   |                            | Please provide floor finishes for rooms 101,102,103, 117,118,119 & 121   |            |        |           |               |      | Refer to revised room finish schedule on sheet A6.50 issued in REV 2.   |
| 2   |                            | Please confirm make of shiplack ceilings on the first floor<br>cafeteria. Is this to be a millwork item or an armstrong type<br>product?   |            |        |           |               |      | Millwork item, not an Armstrong product   |
| 3   |                            | Please confirm wood species of the coffered ceiling on the<br>2nd floor viewing area. Is this feature to be painted (to not<br>show the wood grains) or a finish that will show the grain of<br>this wood. |            | -      |           |               |      | Painted Poplar  |
| 4   |                            | Please provide information for seating pads at monumental<br>stairs shown on detail 1/A4.03 and also for exterior<br>concrete benches  |            |        |           |               |      | Refer to additional specification section 125219 Upholstered Seating and<br>material selection distributed via email. The material is Authentec Performance<br>by Architex, McQueen, Color: Cinder  |
| 5   |                            | Please provide a specification for tile backer board at the<br>food serving stations.  |            |        |           |               |      | Refer to Part 2.4 in Section 092900 Gypsum Board  |
| 6   |                            | Please comfirm difusers in coffered ceilings will not affect<br>the wood coffered ceilings.  |            |        |           |               |      | Diffusers will be relocated in gyp bd ceiling located at the perimater of the<br>coffered ceiling   |
| 7   |                            | Please confirm if the coffered ceilings on 2nd floor viewing area are to be built with true 2x6's  |            |        |           |               |      | Theses wood members will be custom milled from larger cut wood dimensions.<br>The finished size is 2-1/2" x 6"  |
| 8   |                            | Should we figure TL-11 or TL-12 at bar on left above viewing<br>area on 1st floor? The finish plan says TL-12, but elevations<br>show TL-11.   |            | _      |           |               |      | The deli/coffee station and the grill station receive TL-11 blue tiles on the front<br>face of die walls. And the rotisserie/pizza servery receives TL-12 black tiles on<br>the front face of die wall.   |
| 9   |                            | A1.11 Floor Plan has 8' high S.S. panels at the south and<br>west walls of the Dining Hall, but elevations show wall tile<br>installed at these locations. Which is correct                                |            |        |           |               |      | Wall tile is correct  |
| 10  |                            | Please explain the numerical door types shown on the door schedule.Specifically, type 81,91,63, and 84.  |            | _      |           |               |      | Disregard these door types. A revised door schedule will be issued in REV 2   |
| 11  |                            | Door 100D is shown on the 1st floor plan to connect the<br>pizza/deli to the viewing area, but this door is not shown on<br>the door schedule. Please advise.  |            |        |           |               |      | A revised door schedule will be issued in REV 2 that will include Door 100D   |
| 12  |                            | Will the monumental stair landing be column supported or<br>wall supported?  |            |        |           |               |      | Wall supported  |
| 13  |                            | Please provide a specification for the Wilsonart metal base to be used at toe kicks for serving stations.  |            | -      |           |               |      | Refer to REV 1 Sheet A6.50 for updated finish schedule.<br>https://www.wilsonart.com/satin-brushed-gold-aluminum-6258<br>Specification Secton 057000 Decorative Metal is located in the SharePoint link<br>below. https://woodwarddesignbuild.sharepoint.com/:f:/s/Saints-<br>CafeteriaandViewingP24264/EgcnEAdpe2tCrQHja1FpfKQBNjU990I06qAgFxq9e<br>0iOHw?e=aV8QDb |
| 14  |                            | Viewing area 200 cabinets between white oak wall<br>surround – is that plain slice white oak with a dark stain or<br>Plastic Laminate to match the cabinets in the dining room<br>with is a dark grey?     | WMG        | _      |           |               |      |   |
| 15  |                            | The pass through from dining to viewing area 100 – is that<br>tile or plain slice white oak panels to be stained or surface<br>solutions 455??   | WMG        | _      |           |               |      | The vertical surface at this area is ceramic tile TL-06. The ceiling material for this area is Flat Tambour T734, stained to match the TL-06 tile.  |
| 16  |                            | The wainscot in the viewing area 200 on either side of the<br>cabinets and wood surround. What material is that and is<br>it millwork?   | WMG        | _      |           |               |      | RE: Sheet A6.52. These walls are called out to receive WC-01 which is a vertical shiplap wainscot with wallcovering above.  |
| 17  |                            | Flooring type QTL-1 & QLT-2 are shown on the room<br>schedule, but are not shown on the matetrial legend. Please<br>provide information for these finishes.  |            | _      |           |               |      | QTL-1 is quarry tile and QTL-2 is quarry tile base.   |
| 18  |                            | Please provide door material information for door types 100c-103 & 115- 212, as no information is shown on the door schedule.  |            |        |           |               |      | Refer to revised door schedule issued in REV 2.   |
| 19  |                            | Please provide information for door type "N" & "FL"  |            |        |           |               |      |   |
| 20  |                            |  |            |        |           |               |      |   |

| 1             | Please confirm that the elevator control room will be<br>removed and that the controls will be within the shaft.   | - | Confirmed. The elevator control room will be removed and the controls will be within the shaft.                               |
|---------------|--|---|---|
| 22            | Please provide tags on the elevation drawings for the ACM<br>Panels.   |   | Tags identifying the ACM panels have been added. Revised exterior elevation<br>drawings will be issued in REV 2.              |
| 23 Civil      | Please provide a base sone or sand for the concrete paving<br>and it's thickness.  |   |   |
| 24 Structura  | Please confirm door hardware sets for each door on the   |   |   |
| 25            | door schedule.   | - | Refer to REV 2  |
| 26            | Please provide sheet A2.02 shown on sheet A1.11 to be an elevation behind the deli/coffee bar.   |   | Disregard this tag. It has been removed. Refer to interior elevation 3/A8.63.   |
| 27            | Please provide details for new gutter system in lieu of PVC<br>pipe from exsisting practice facility building.   |   | Refer to REV 2  |
| 28            | Please provide floor finishes for rooms 101,102,103,<br>117,118, & 121. The revised REV 1 room finish schedule<br>does not show Floor/base in these rooms.   | - | Refer to REV 2  |
| 29            | Keynotes are pointed out on sheet A1.00, but the key note schedule does not have any notes listed. Please advise.  | _ | Notes have been added. Refer to REV 2.  |
| 30 Food Servi | vice Please provide the model number for Item #24 (Fryer Unit)   | _ | Pitco No. SSH75-1FD with standard solid-state controls and s/s frypot cover.  |
| 31            | Sheet A6.51 shows "Floor Finish 1/2" wood look" for the<br>outdoor seating areas. Please provide this wood flooring on<br>the finish schedule.   | - | Disregard this note. The flooring for the outdoor seating area is concrete.   |
| 32            | Enlarged restroom plan (sheet A8.50, detail 1) calls out<br>A8.51 to be a sheet showing elevations, but this sheet is not<br>included in the set. Please advise wall tile type, and height of<br>assumed wainscot.   |   |   |
| 33            | ACT-1 & ACT-2 are shown on the room finish schedule, but<br>there is no product information for these ceiling types on the<br>finish schedule. Please advise.  | - |   |
| 34            | CPT1,CPT2 & CPT3 are shown on the Level 2 room finish<br>schdeule, but the only carpet information on the finish<br>schedule is for "CT-01". Please advise.<br>Floor plan A6.51 shows interior storefront between collumn  |   | Disregard CPT2 and CPT3. CPT1 will be renamed as CT-01.   |
| 35 A6.51      | lines 9 & 10, on line C', south of the grab & go bar. Is this an existing storefront system or is this intended to be new? It is   | _ | This is a new storefront system. And the storefront located to left of this this area behind the deli/coffee bar is also new. |
| 36            | Please provide an updated detail showing how the<br>monumental stair will be wall supported.   |   | Refer to REV 2  |
| 37            | Please confirm how steel supports for roof top mechanical<br>screens will be mounted. Will this steel penatrate the roof or<br>connect to the inside face of the parapet?  | - | Refer to REV 2  |
| 38            | Please confirm base finish in Dining Hall 100.   |   | Ceramic tile base - specific product TBD  |
| 39            | Please provide information/product sheet on the owner<br>provided facial recognition door hardware, as this will be<br>needed to price the doors to receive this hardware, as well<br>as to inform the electrical aspect of this scope.  | - | Refer to email response dated 10/30/23.   |
| 40            | How is the low roof draining at column lines 10&11 A&C'?   | - | With scupper and downspout. Refer to A1.30 REV 2.   |
| 41            | Will the (CL-01) Ship Lap ceiling material attach directly to<br>the metal framing as indicated on details 3-6/A7.06 ? Or do<br>we need to provide a plywood substrate?  | - | Provide a 1/2" substrate.   |
| 42            | As per Section 09 5133 and Room Finish Legend (A6.50),<br>the CL-3 ceiling is indicated as a drop in 24x24 American<br>Tin, Pattern #15 Rustic Copper Translucent, Color: Brass<br>panel. The suspension system refers back to Section 09<br>5123 which does not indicate grid color. What grid color is<br>to be included with the CL-3 ?<br>The finish schedule lists " Concrete " as a floor finish. Please | _ | Paint grid to match brass-colored tile.   |
| 43            | The finish schedule lists "Concrete " as a floor finish. Please<br>confirm this is to be exposed concrete and not sealed<br>concrete.  | - |   |

| 45 |  |   |  |  |
|----|--|---|--|--|
| 46 |  |   |  |  |
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| 50 |  |   |  |  |
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| 53 |  |   |  |  |
|    |  | _ |  |  |
|    |  |   |  |  |

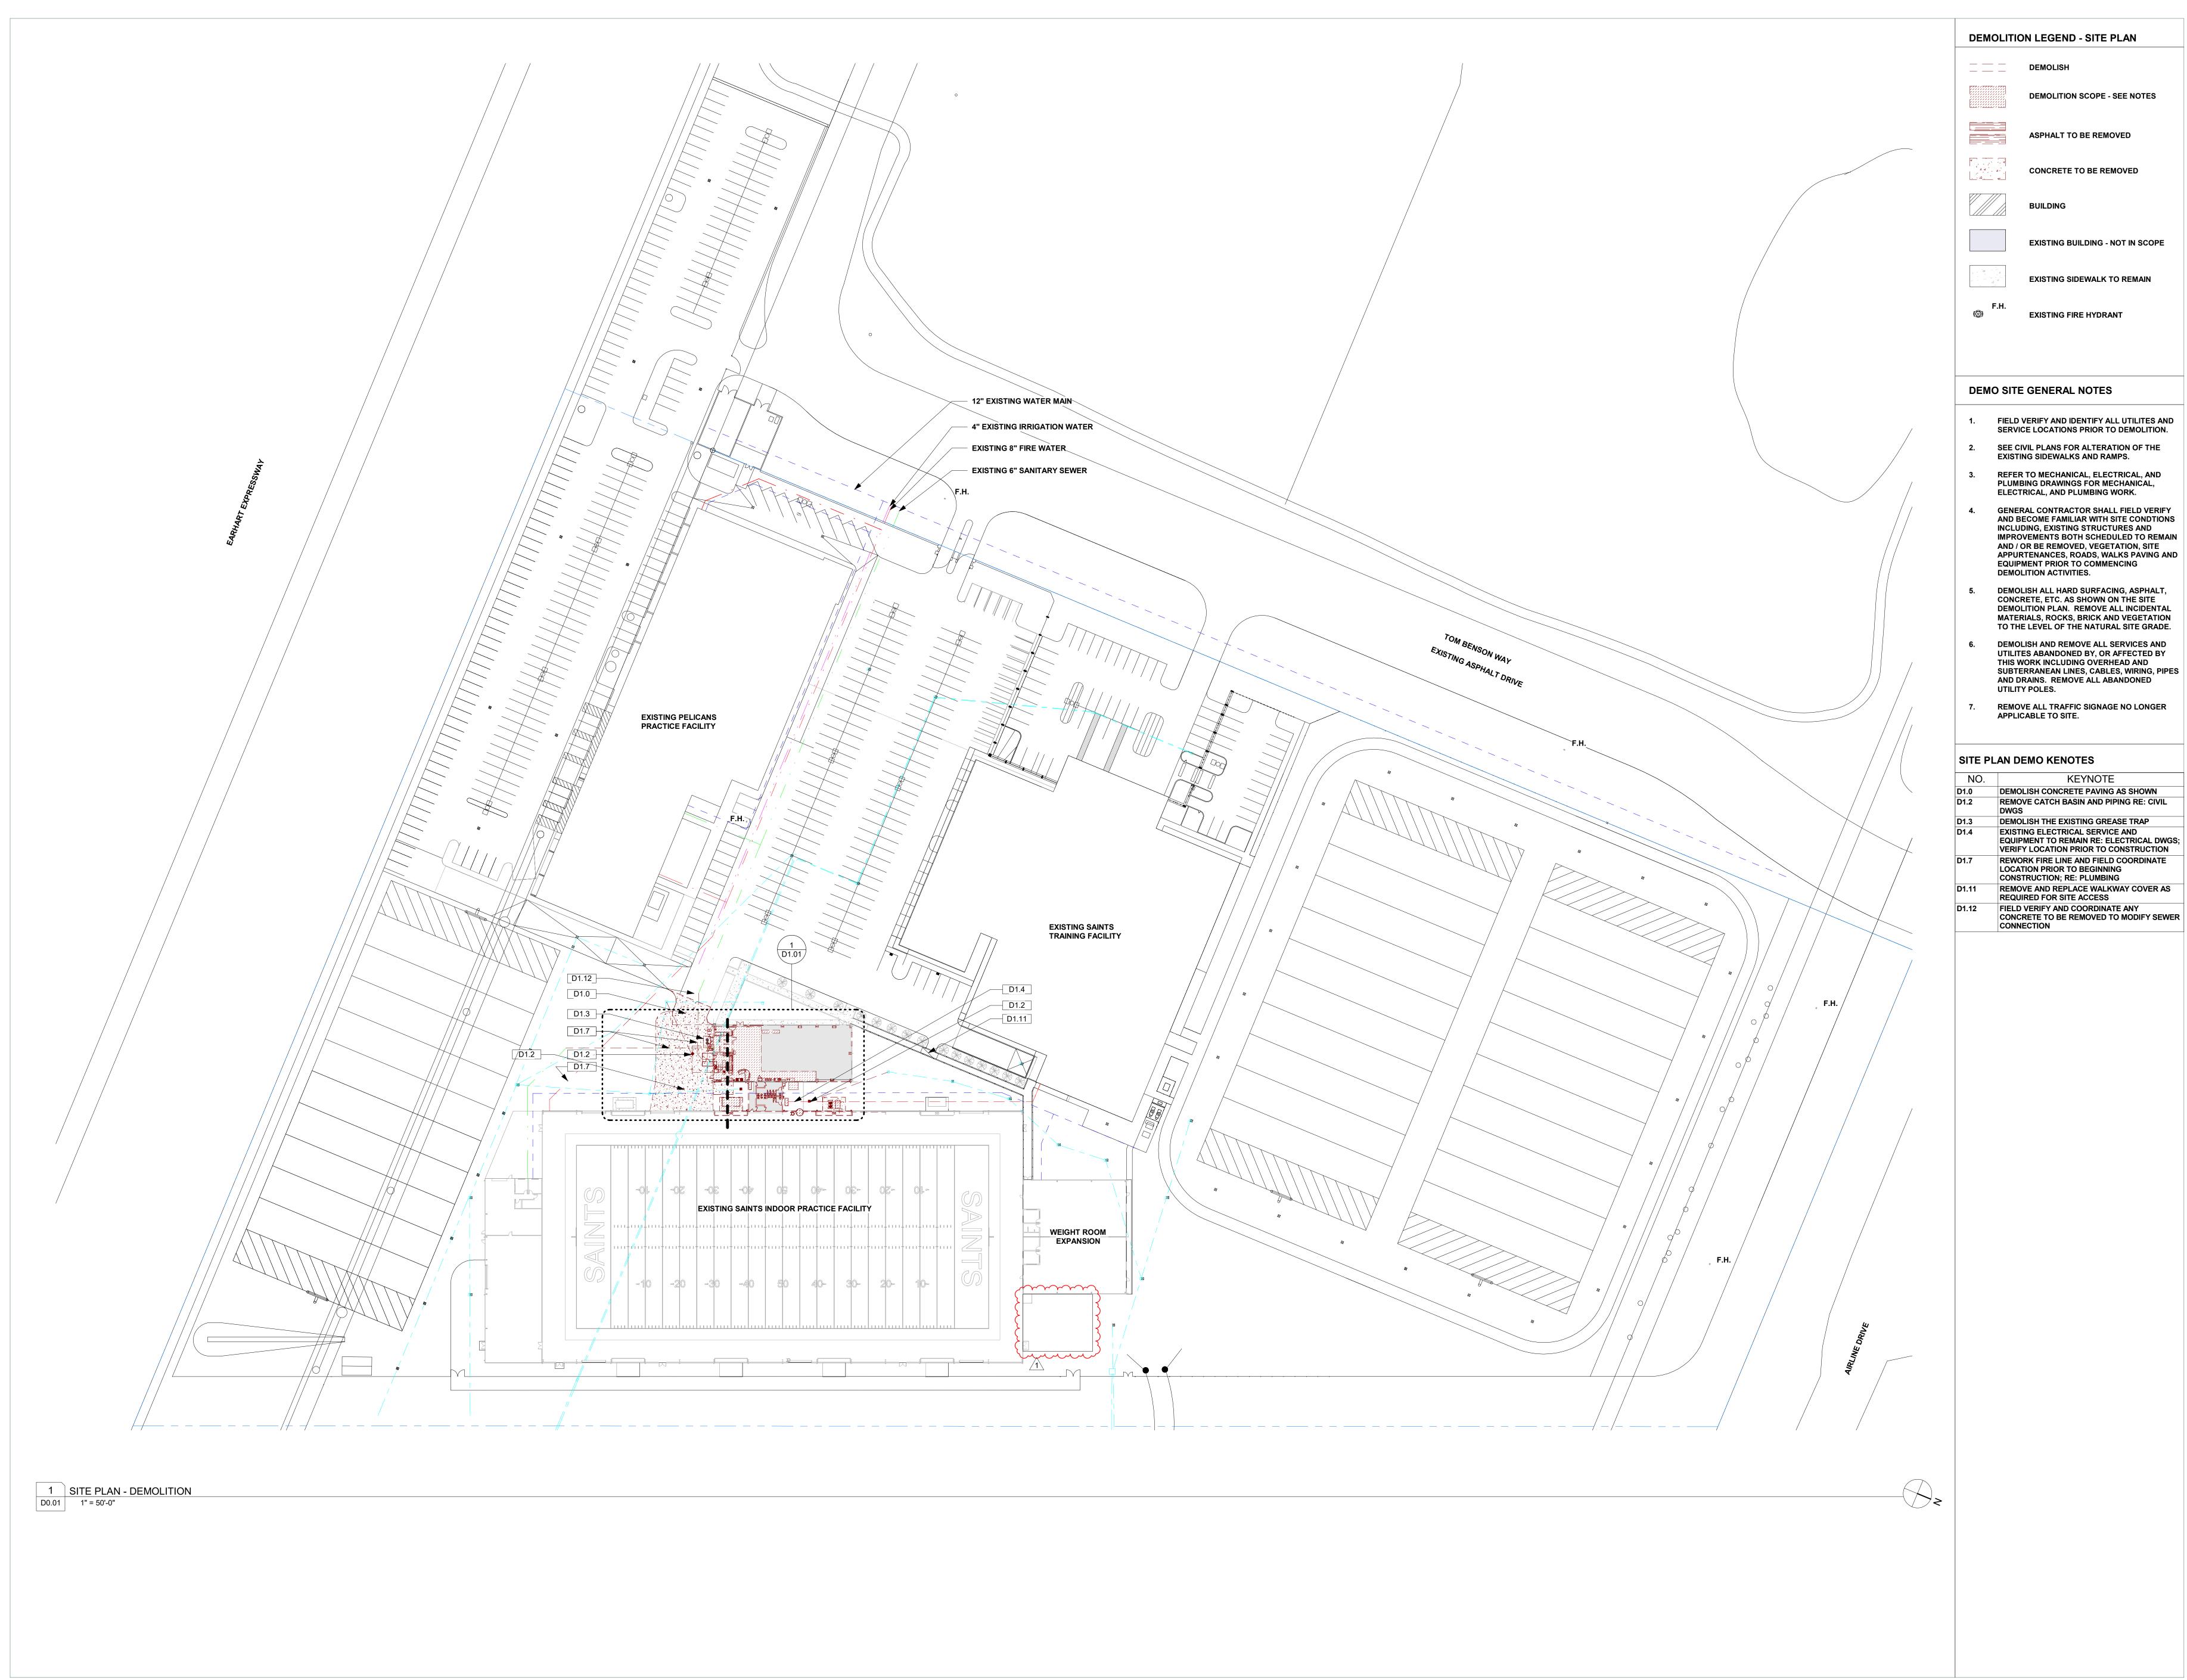


|             |                       |              |            | (                 | OCCUPANT LO    | AD ( |
|-------------|-----------------------|--------------|------------|-------------------|----------------|------|
| BUILDING    | NAME                  | OCCUPANCY    | AREA       | LOAD FACTOR - IBC | OCC LOAD - IBC | LC   |
| Not Placed  | 1                     |              | I          |                   | 1              |      |
| NEW         | ELEVATOR LOBBY        | ASSEMBLY A-2 | Not Placed |                   |                |      |
|             |                       |              | 0 SF       | I                 | 0              |      |
|             |                       |              | 0 SF       |                   | 0              |      |
| FLOOR 1     |                       |              |            |                   |                |      |
| EXISTING    | EXISTING WEIGHT ROOM  | ASSEMBLY A-2 | 8,857 SF   | 50                | 178            | 50   |
| EXISTING    | CAFETERIA             | ASSEMBLY A-2 | 5,798 SF   | 15                | 387            | 15   |
| EXISTING    | EXISTING SPORTS FIELD | ASSEMBLY A-3 | 92,475 SF  | 15                | 6166           | 15   |
| EXISTING    | EXISTING STORAGE      | STORAGE S-2  | 7,999 SF   | 500               | 16             | 500  |
|             |                       |              | 115,130 SF |                   | 6747           |      |
| NEW         | KITCHEN               | ASSEMBLY A-2 | 3,824 SF   | 200               | 20             | 100  |
| NEW         | ASSEMBLY - A2         | ASSEMBLY A-2 | 2,252 SF   | 7                 | 322            | 7    |
| NEW         | ANCILLARY             | ASSEMBLY A-2 | 557 SF     |                   |                |      |
| NEW         | CAFETERIA             | ASSEMBLY A-2 | 1,023 SF   | 7                 | 147            | 7    |
| NEW         | FREEZER/ REFRIGERATOR | STORAGE S-2  | 669 SF     | 200               | 4              | 200  |
| NEW         | STORAGE               | STORAGE S-2  | 116 SF     | 300               | 1              | 300  |
| NEW         | ANCILLARY             | UTILITY      | 183 SF     | 500               | 1              | 500  |
|             |                       | ·            | 8,624 SF   | ł                 | 495            |      |
|             |                       |              | 123,754 SF |                   | 7242           |      |
| FLOOR 2 RCP | )                     |              |            |                   |                |      |
| NEW         | ASSEMBLY - A2         | ASSEMBLY A-2 | 1,636 SF   | 7                 | 234            | 7    |
| NEW         | ELEVATOR LOBBY        | CIRCULATION  | 166 SF     |                   |                | -    |
| NEW         | MECH                  | STORAGE S-2  | 728 SF     |                   |                |      |
| NEW         | STORAGE               | STORAGE S-2  | 30 SF      |                   |                |      |
|             | -                     | -            | 2,561 SF   |                   | 234            |      |
|             |                       |              | 2.561 SF   |                   | 234            |      |

| R WIDTH<br>LOAD FACTOR<br>(IDED<br>AL                                     |             |      |                  |
|---|-------------|------|------------------|
| IOAD FACTOR     0.2     OCC. LOAD FACTOR       /IDED     340     PROVIDED |             | DOOR |                  |
| /IDED 340 PROVIDED  | R WIDTH     | 68"  | CLEAR WIDTH      |
|   | LOAD FACTOR | 0.2  | OCC. LOAD FACTOR |
| AL 250 ACTUAL   | IDED        | 340  | PROVIDED         |
|   | AL          | 250  | ACTUAL           |



N.O. SAINTS CAFETERIA & VIEWING EXPANSION 5800 Airline Drive Metairie, Louisiana WDG PROJECT NO | 6022-498 CONSTRUCTION DOCUMENTS 10/09/2023 REVISIONS descripton FLOOR 1 - LIFE SAFETY PLAN



**EXISTING BUILDING - NOT IN SCOPE** 

EXISTING SIDEWALK TO REMAIN

AND BECOME FAMILIAR WITH SITE CONDTIONS IMPROVEMENTS BOTH SCHEDULED TO REMAIN APPURTENANCES, ROADS, WALKS PAVING AND

SUBTERRANEAN LINES, CABLES, WIRING, PIPES

KEYNOTE



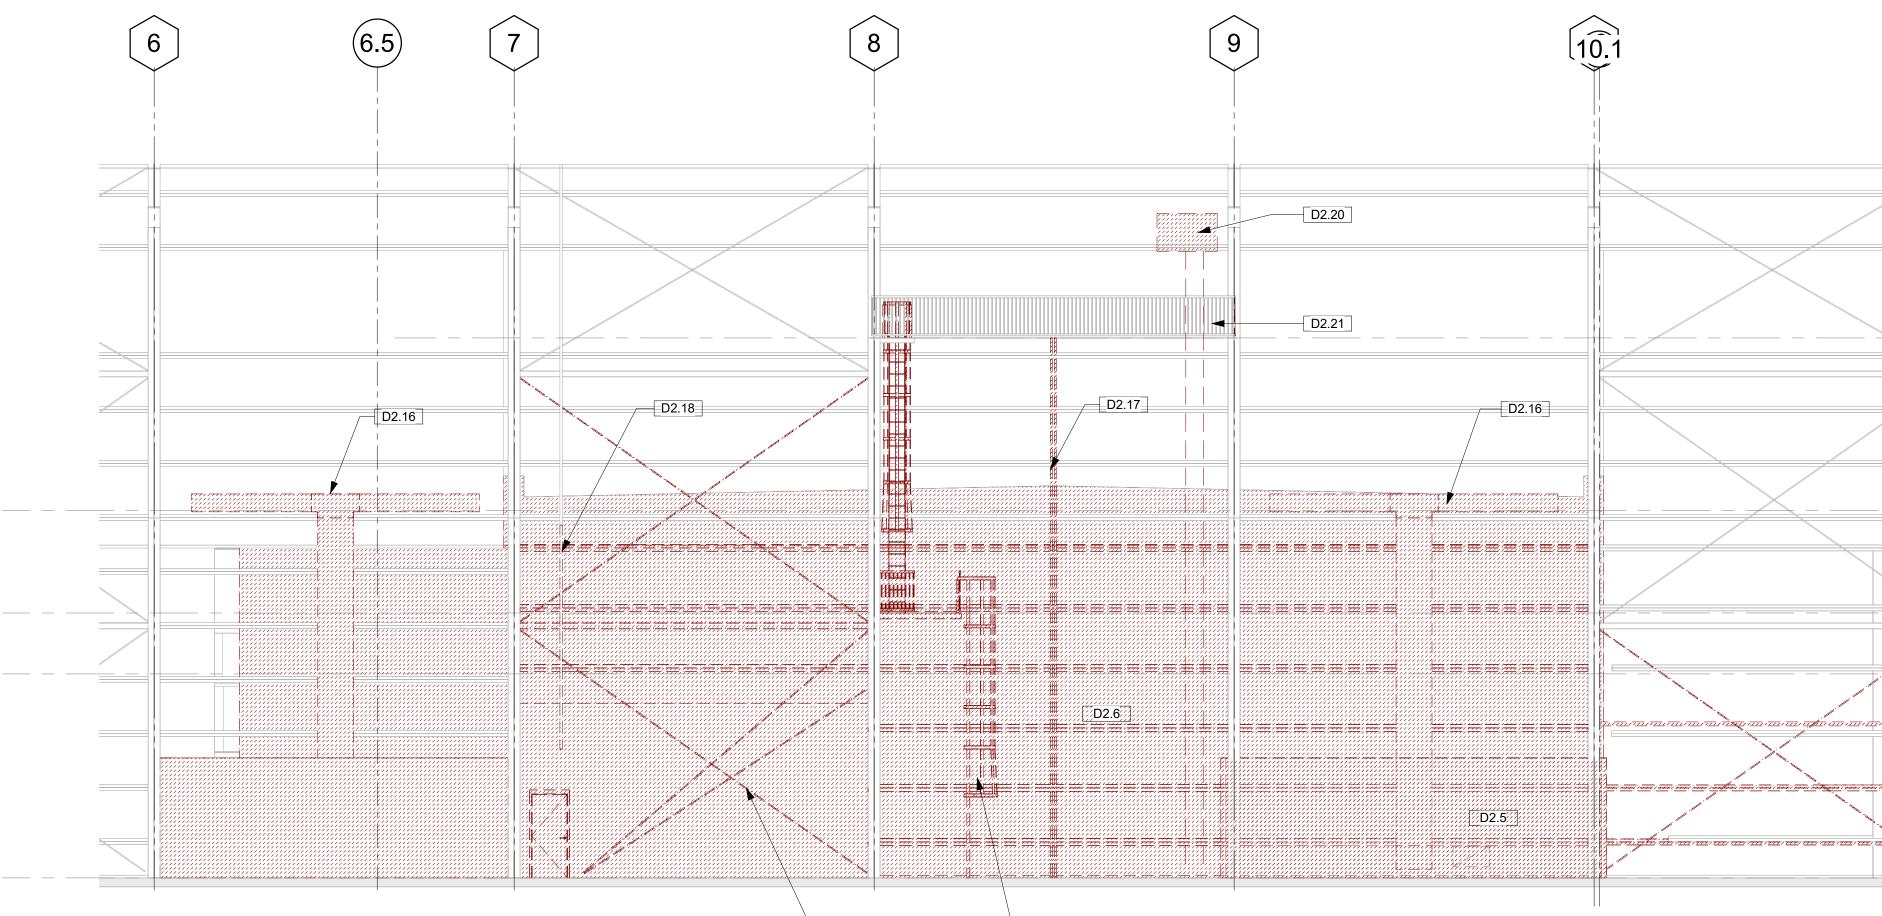
woodward design group 1000 S. NORMAN C. FRANCIS PARKWAY NEW ORLEANS, LA 70125 WOODWARDDESIGNBUILD.COM | 504-822-6443 Erik Wismar, AIA

N.O. SAINTS CAFETERIA & VIEWING EXPANSION 5800 Airline Drive Metairie, Louisiana

WDG PROJECT NO | 6022-498 CONSTRUCTION DOCUMENTS 10/09/2023

REVISIONS descripton date vision 2 10/30/23 SITE PLAN DEMO

DRAWN BY | WDG



1PRACTICE FIELD DEMOLITION ELEVATIOND2.001/8" = 1'-0"

\_\_\_\_D2.7

D2.11

|    |                                | DEI         | MOLITION LEGEND  |
|----|--------------------------------|-------------|--|
|    |                                |             | EXISTING WALL TO BE REMOVED  |
|    |                                |             | EXISTING MASONRY WALL TO BE REMOVED  |
|    |                                |             | EXISTING WALL TO REMAIN  |
|    |                                |             | EXISTING ELEMENT TO BE REMOVED   |
|    |                                |             | EXISTING SLAB TO BE REMOVED  |
|    |                                | ELE         | EVATION GENERAL DEMO NOTES   |
|    |                                | 1.          | THERE ARE TO BE NO ATTACHMENTS MADE,<br>HOLES DRILLED, OR DAMAGES DONE TO THE<br>EXTERIOR FACADE OF THE BUILDING WITHOUT<br>SPECIFIC AND DIRECT AUTHORIZATION FROM   |
|    |                                | 2.          | THE PROJECT ARCHITECT.<br>NO DEMOLITION OF ANY EXTERIOR FACADE<br>MATERIALS IS TO OCCUR WITHOUT EXPLICIT<br>DIRECTION FROM THE PROJECT ARCHITECT.  |
|    |                                | 3.          | ANY DEMOLITION IS TO BE CONDUCTED IN A<br>MANNER AS TO NOT DAMAGE OR FURTHER<br>DESTROY ANY EXTERIOR FACADE BUILDING<br>MATERIALS OR ADJACENT STRUCTURES.  |
|    |                                |             |  |
|    |                                | NO.<br>D2.5 | KEYNOTE<br>DEMO EXISTING METAL WALL PANEL ASSEMBLY<br>AND SALVAGE FOR REUSE  |
|    |                                | D2.7        | REMOVE EXISTING EXTERIOR MTL WALL PANELS,<br>INSULATION AND METAL WALL GIRTS AS SHOWN<br>REMOVE EXISTING X BRACING AND PREP FOR NEW<br>STRUCTURAL BRACING RE: STRUCT<br>REMOVE AND RELOCATE EXISTING VIEWING |
|    |                                |             | PLATFORM ACCESS LADDER AS NOTED ON A1<br>FLOOR PLANS<br>REMOVE DUCTS AND RECONFIGURE TO NEW RTU<br>LOCATION; MOVE DUCTS AND UNITS OVER ONE B.<br>REMOVE AND REROUTE CONDUITS, RE: ELEC AND                   |
|    |                                |             | PLUMB<br>DEMOLISH EXISTING CMU WALL WITHOUT CAUSIN<br>DAMAGE TO ADJACENT STRUCTURE<br>REMOVE AND STORE WINCH AND CONTROLS FOR<br>RELOCATING RE: STRUCT TO SALVAGING  |
|    |                                | D2.21       | SUPPORTS<br>EXISTING 50-YARD LINE VIDEO PLATFORM TO<br>REMAIN  |
| 11 |                                |             |  |
|    |                                |             |  |
|    |                                |             |  |
|    |                                |             |  |
|    |                                |             |  |
|    |                                |             |  |
|    | VIDEO PLATFORM<br>45' - 0"     |             |  |
|    |                                |             |  |
|    |                                |             |  |
|    | HIGH ROOF EAVE<br>30' - 7 1/2" |             |  |
|    |                                |             |  |
|    | 22' - 1"                       |             |  |
|    | FLOOR 2<br>17' - 0"            |             |  |
|    |                                |             |  |
|    |                                |             |  |
|    |                                |             |  |
|    | FLOOR 1 💌<br>0' - 0"           |             |  |
|    |                                |             |  |
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|    |                                | 1           |  |

 $\underline{\land}$ UNASSOCIATED DETAIL TAGS REMOVED 

# REMOVED

## NOTES

HMENTS MADE, S DONE TO THE ILDING WITHOUT **RIZATION FROM** 

ANEL ASSEMBLY L WALL PANELS, **GIRTS AS SHOWN** 

ND PREP FOR NEW G VIEWING NOTED ON A1

URE TO NEW RTU NITS OVER ONE BAY TS, RE: ELEC AND

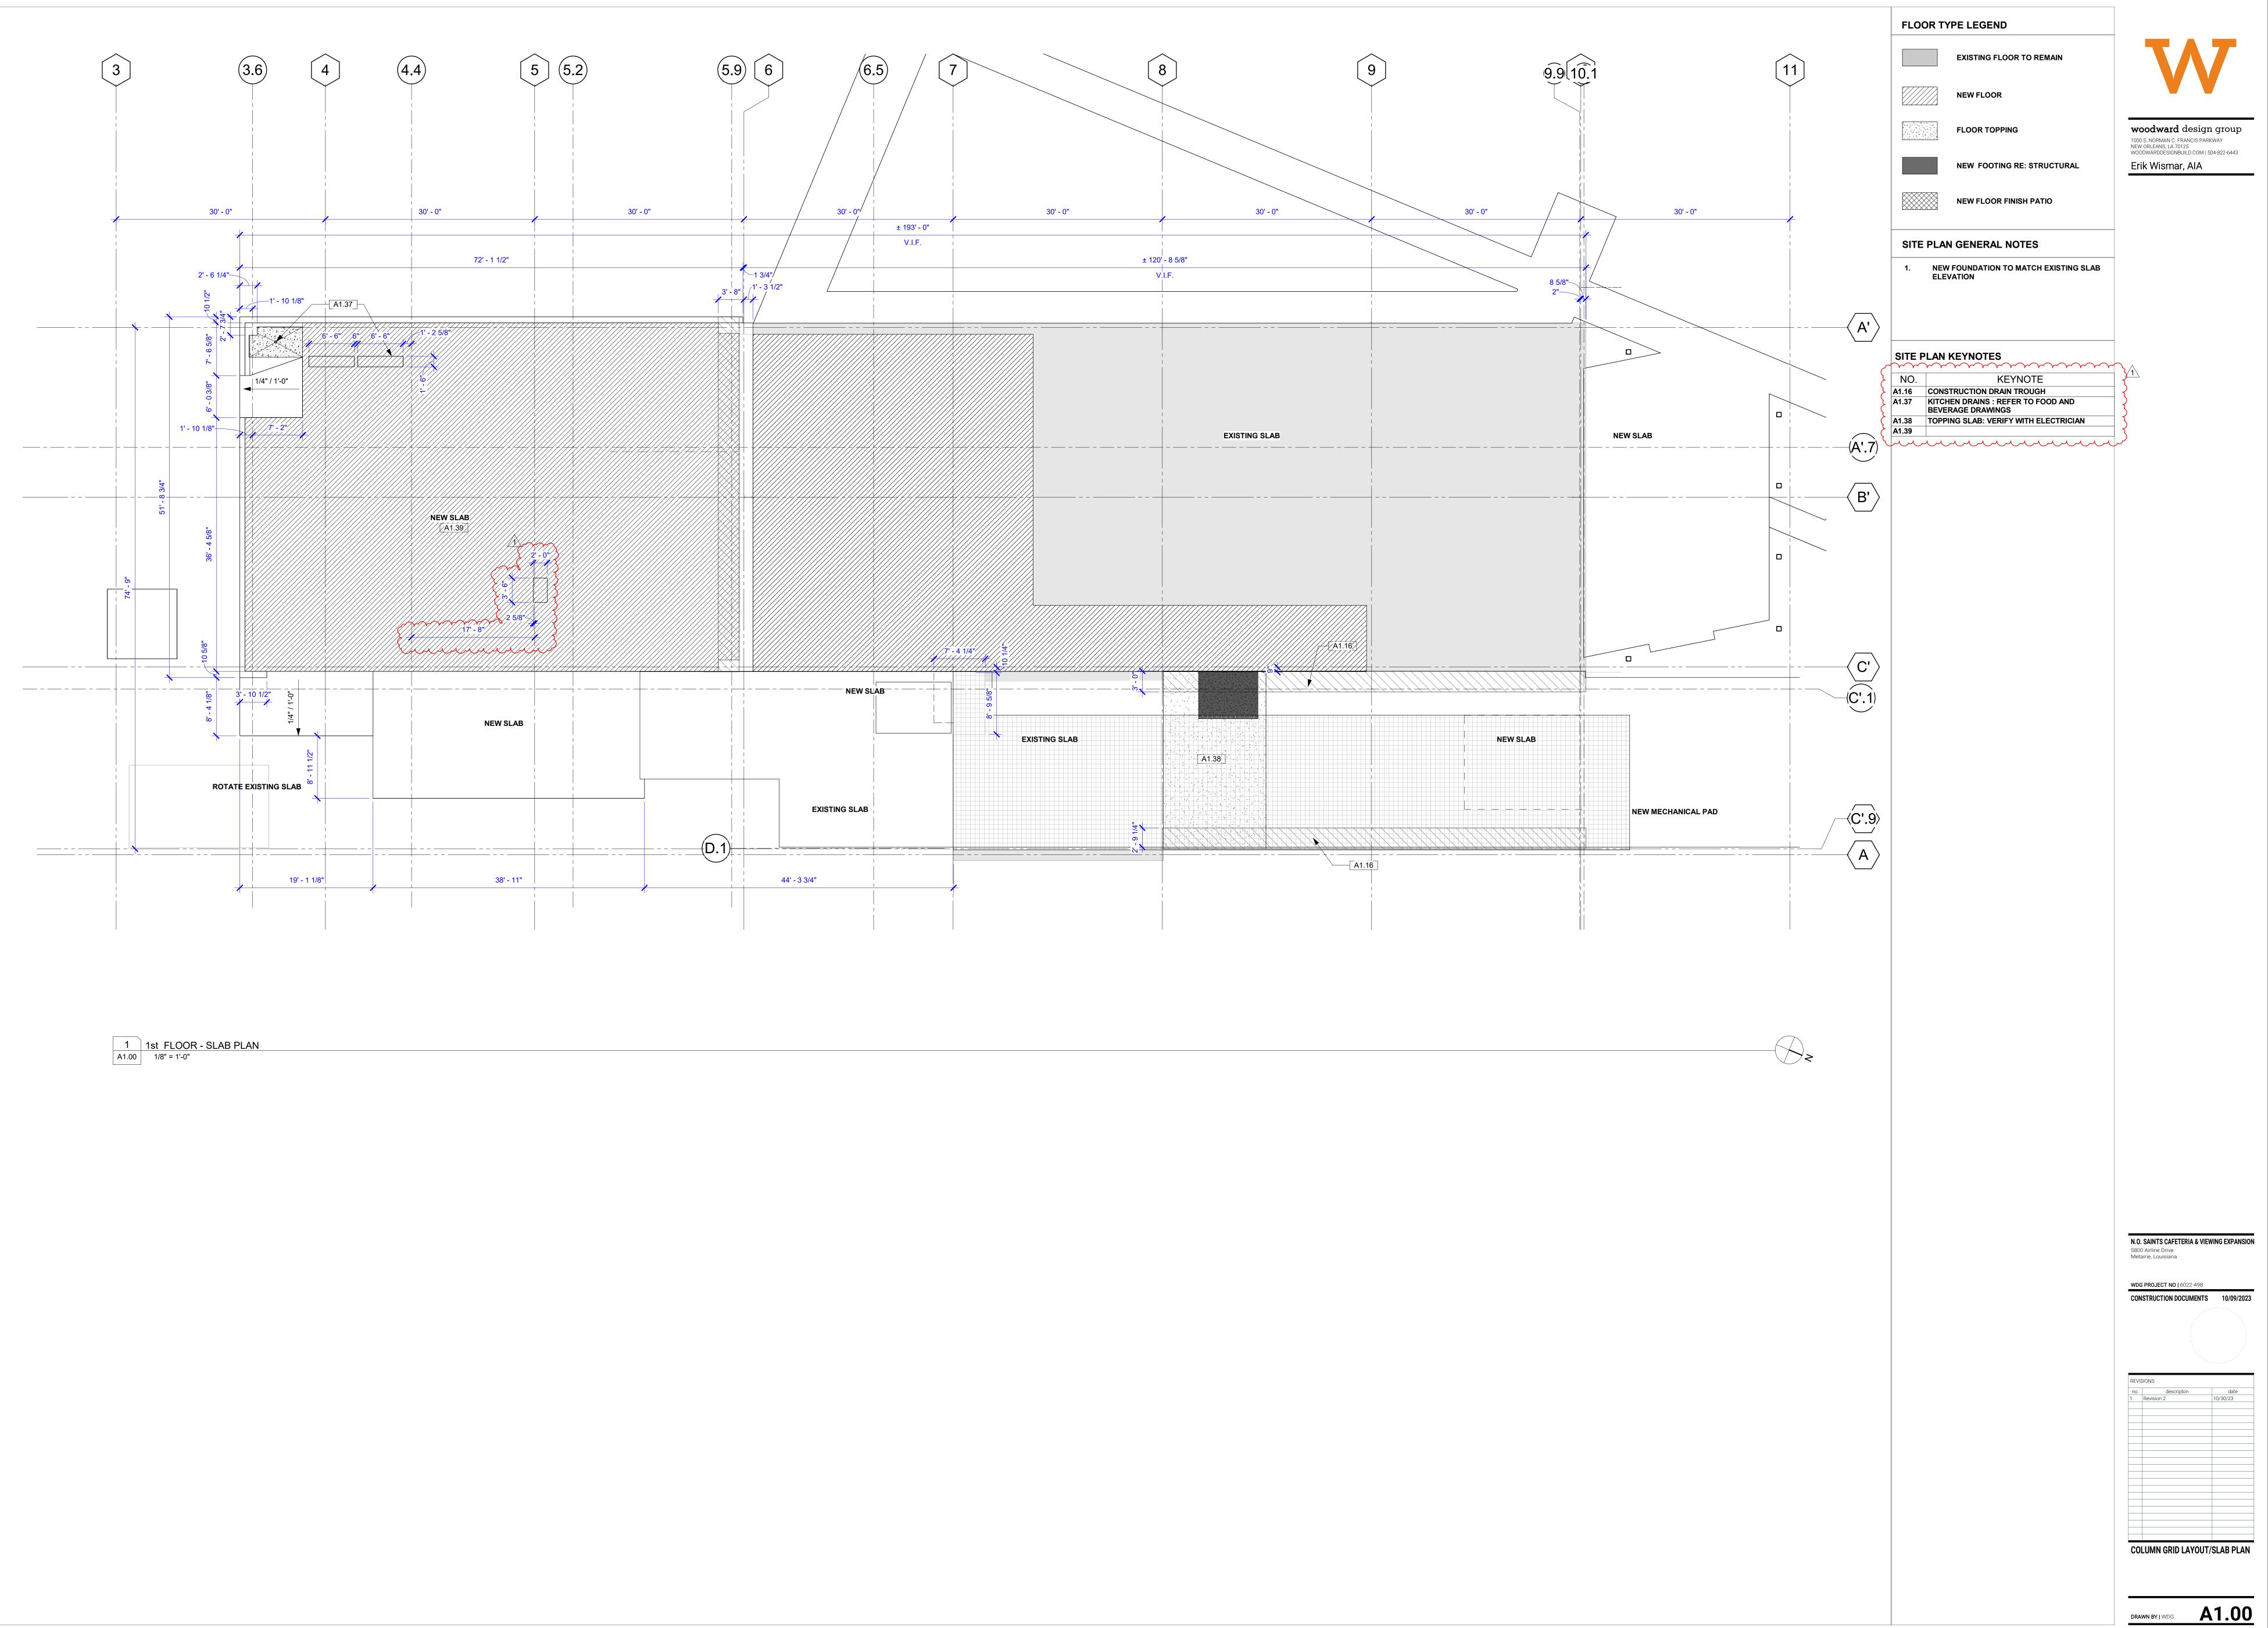
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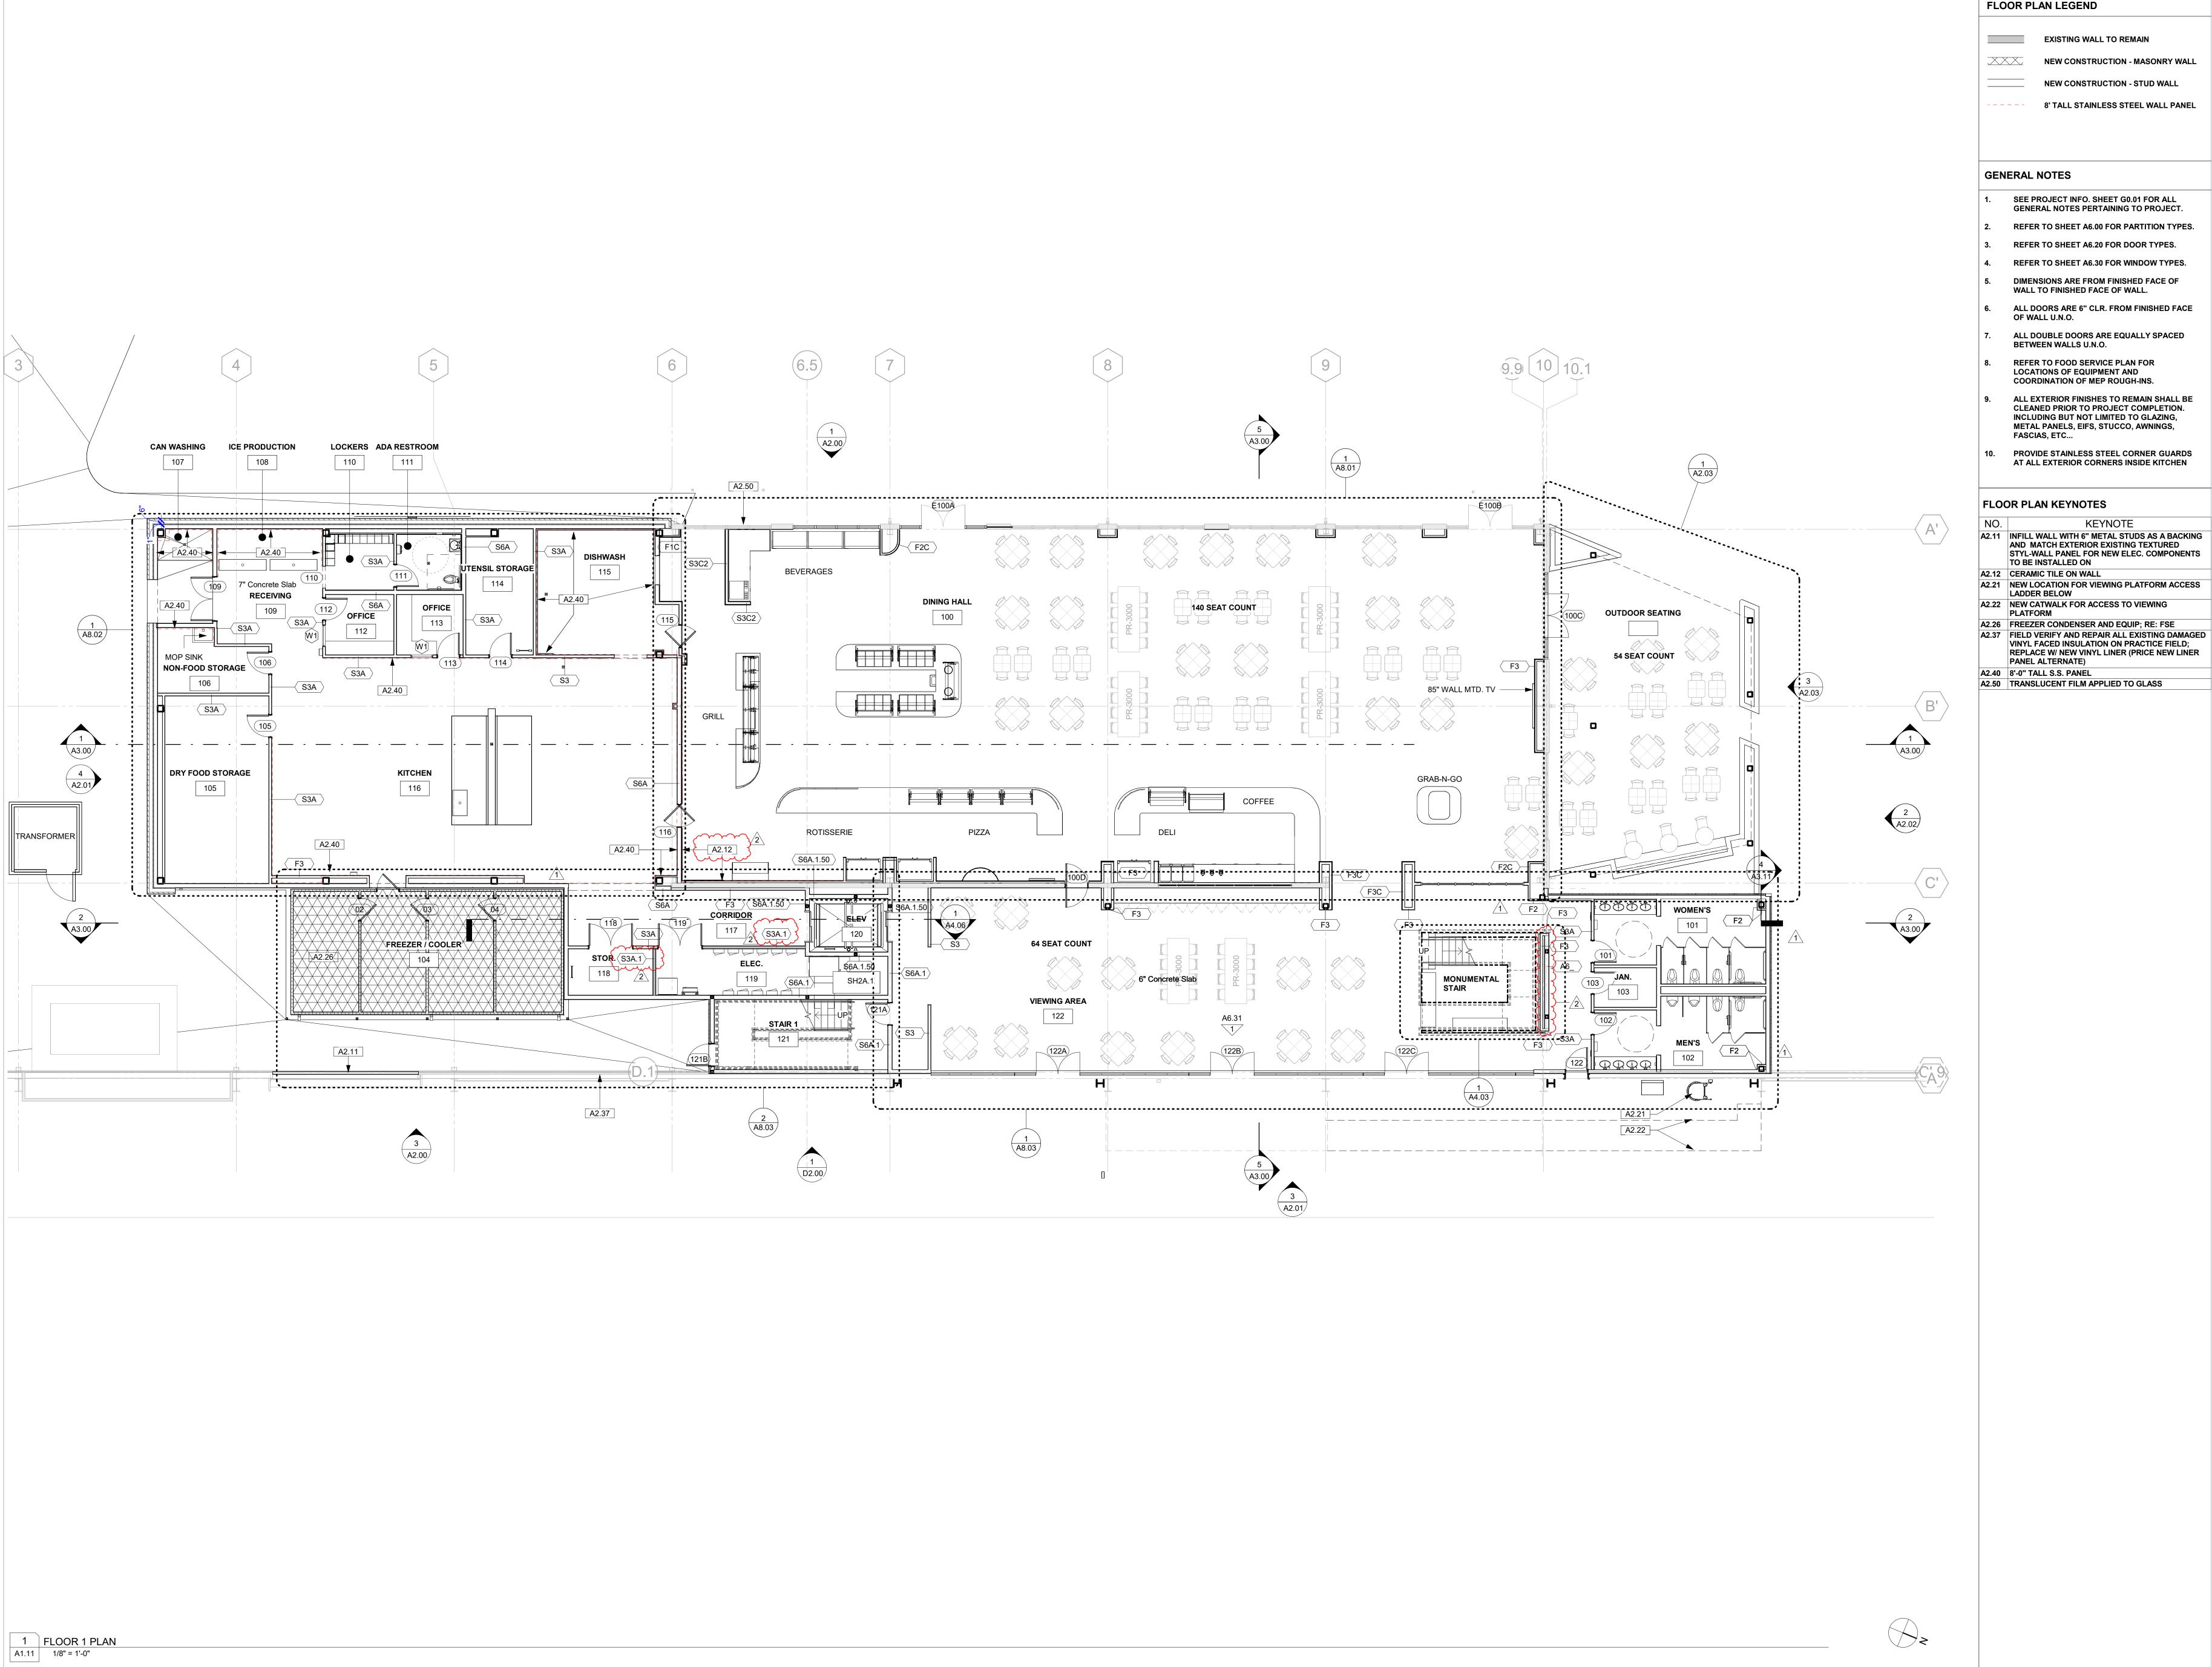
## CONTROLS FOR



woodward design group 1000 S. NORMAN C. FRANCIS PARKWAY NEW ORLEANS, LA 70125 WOODWARDDESIGNBUILD.COM | 504-822-6443 Erik Wismar, AIA

|      | S PROJECT NO   6022-498     | 10/09/2023       |
|------|-----------------------------|------------------|
|      |                             |                  |
|      |                             |                  |
| REVI | SIONS descripton Revision 2 | date<br>10/30/23 |
|      |                             |                  |
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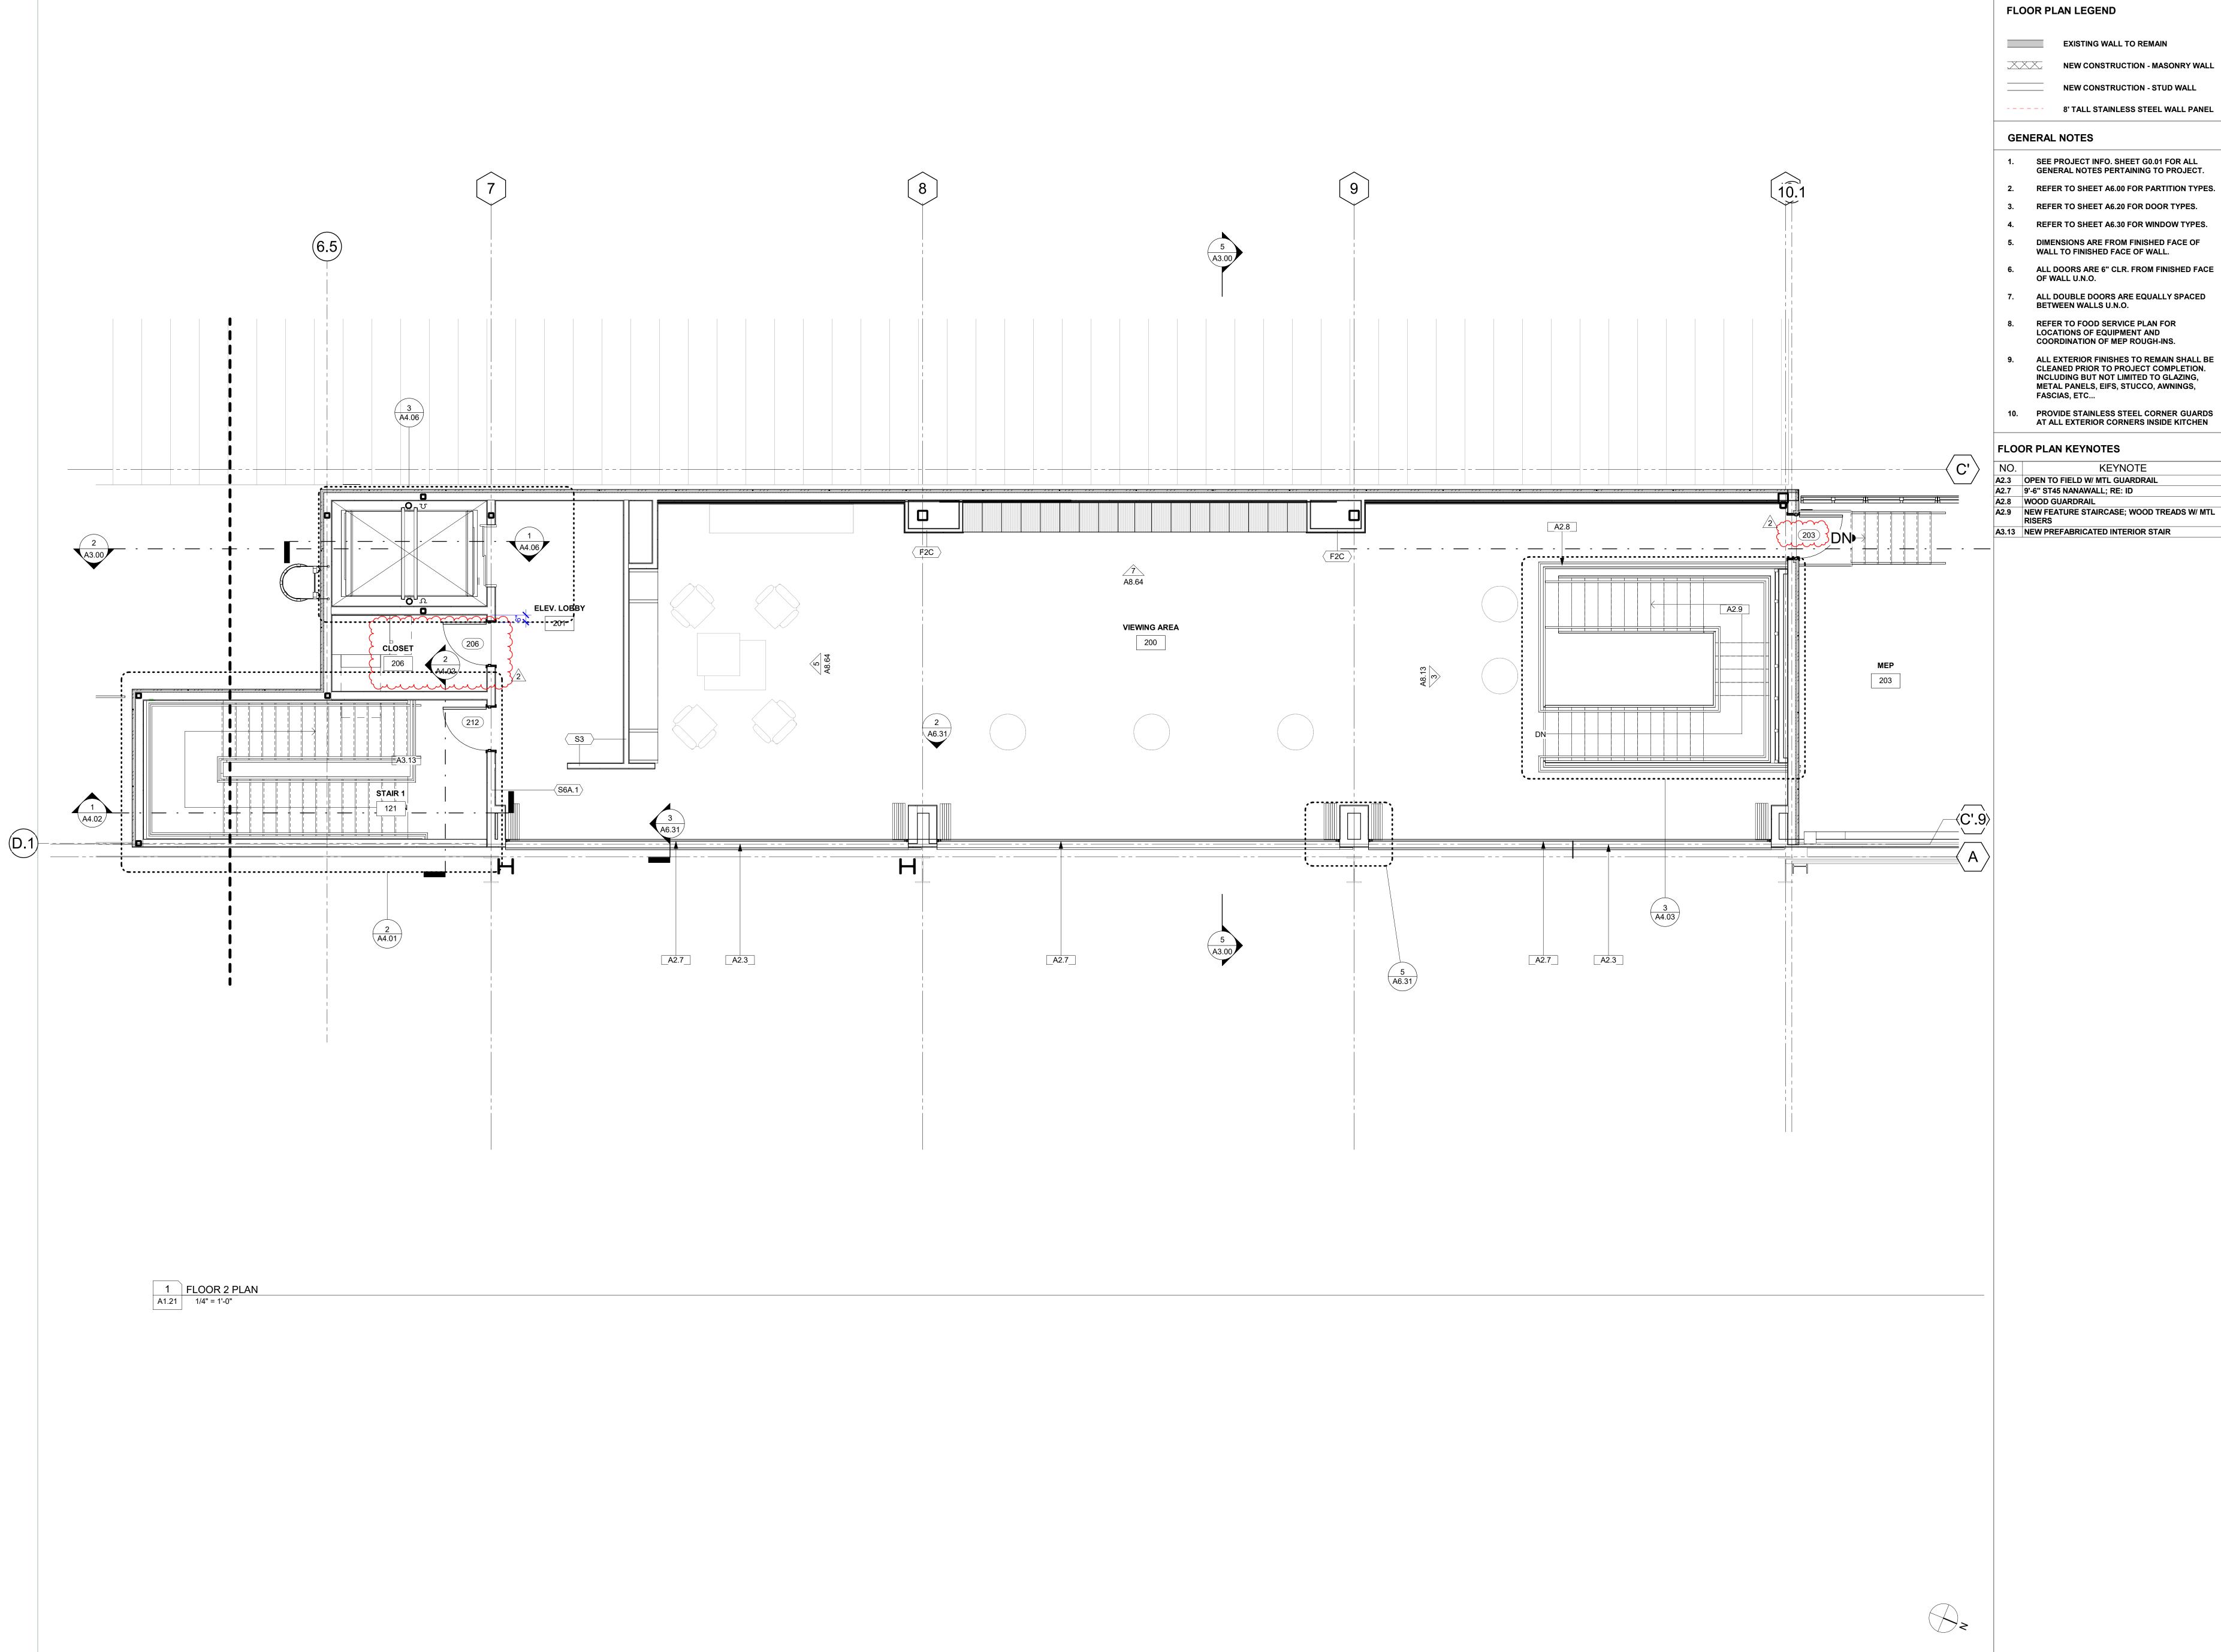






| 5800          | SAINTS CAFETERIA & VIEV<br>) Airline Drive<br>airie, Louisiana | VING EXPANSIC                |
|---------------|--|------------------------------|
|               | S PROJECT NO   6022-498  | 10/09/2023                   |
|               |  |                              |
| REVI          | SIONS  |                              |
| no.<br>1<br>2 | descripton<br>Revision 1<br>Revision 2                         | date<br>10/23/23<br>10/30/23 |
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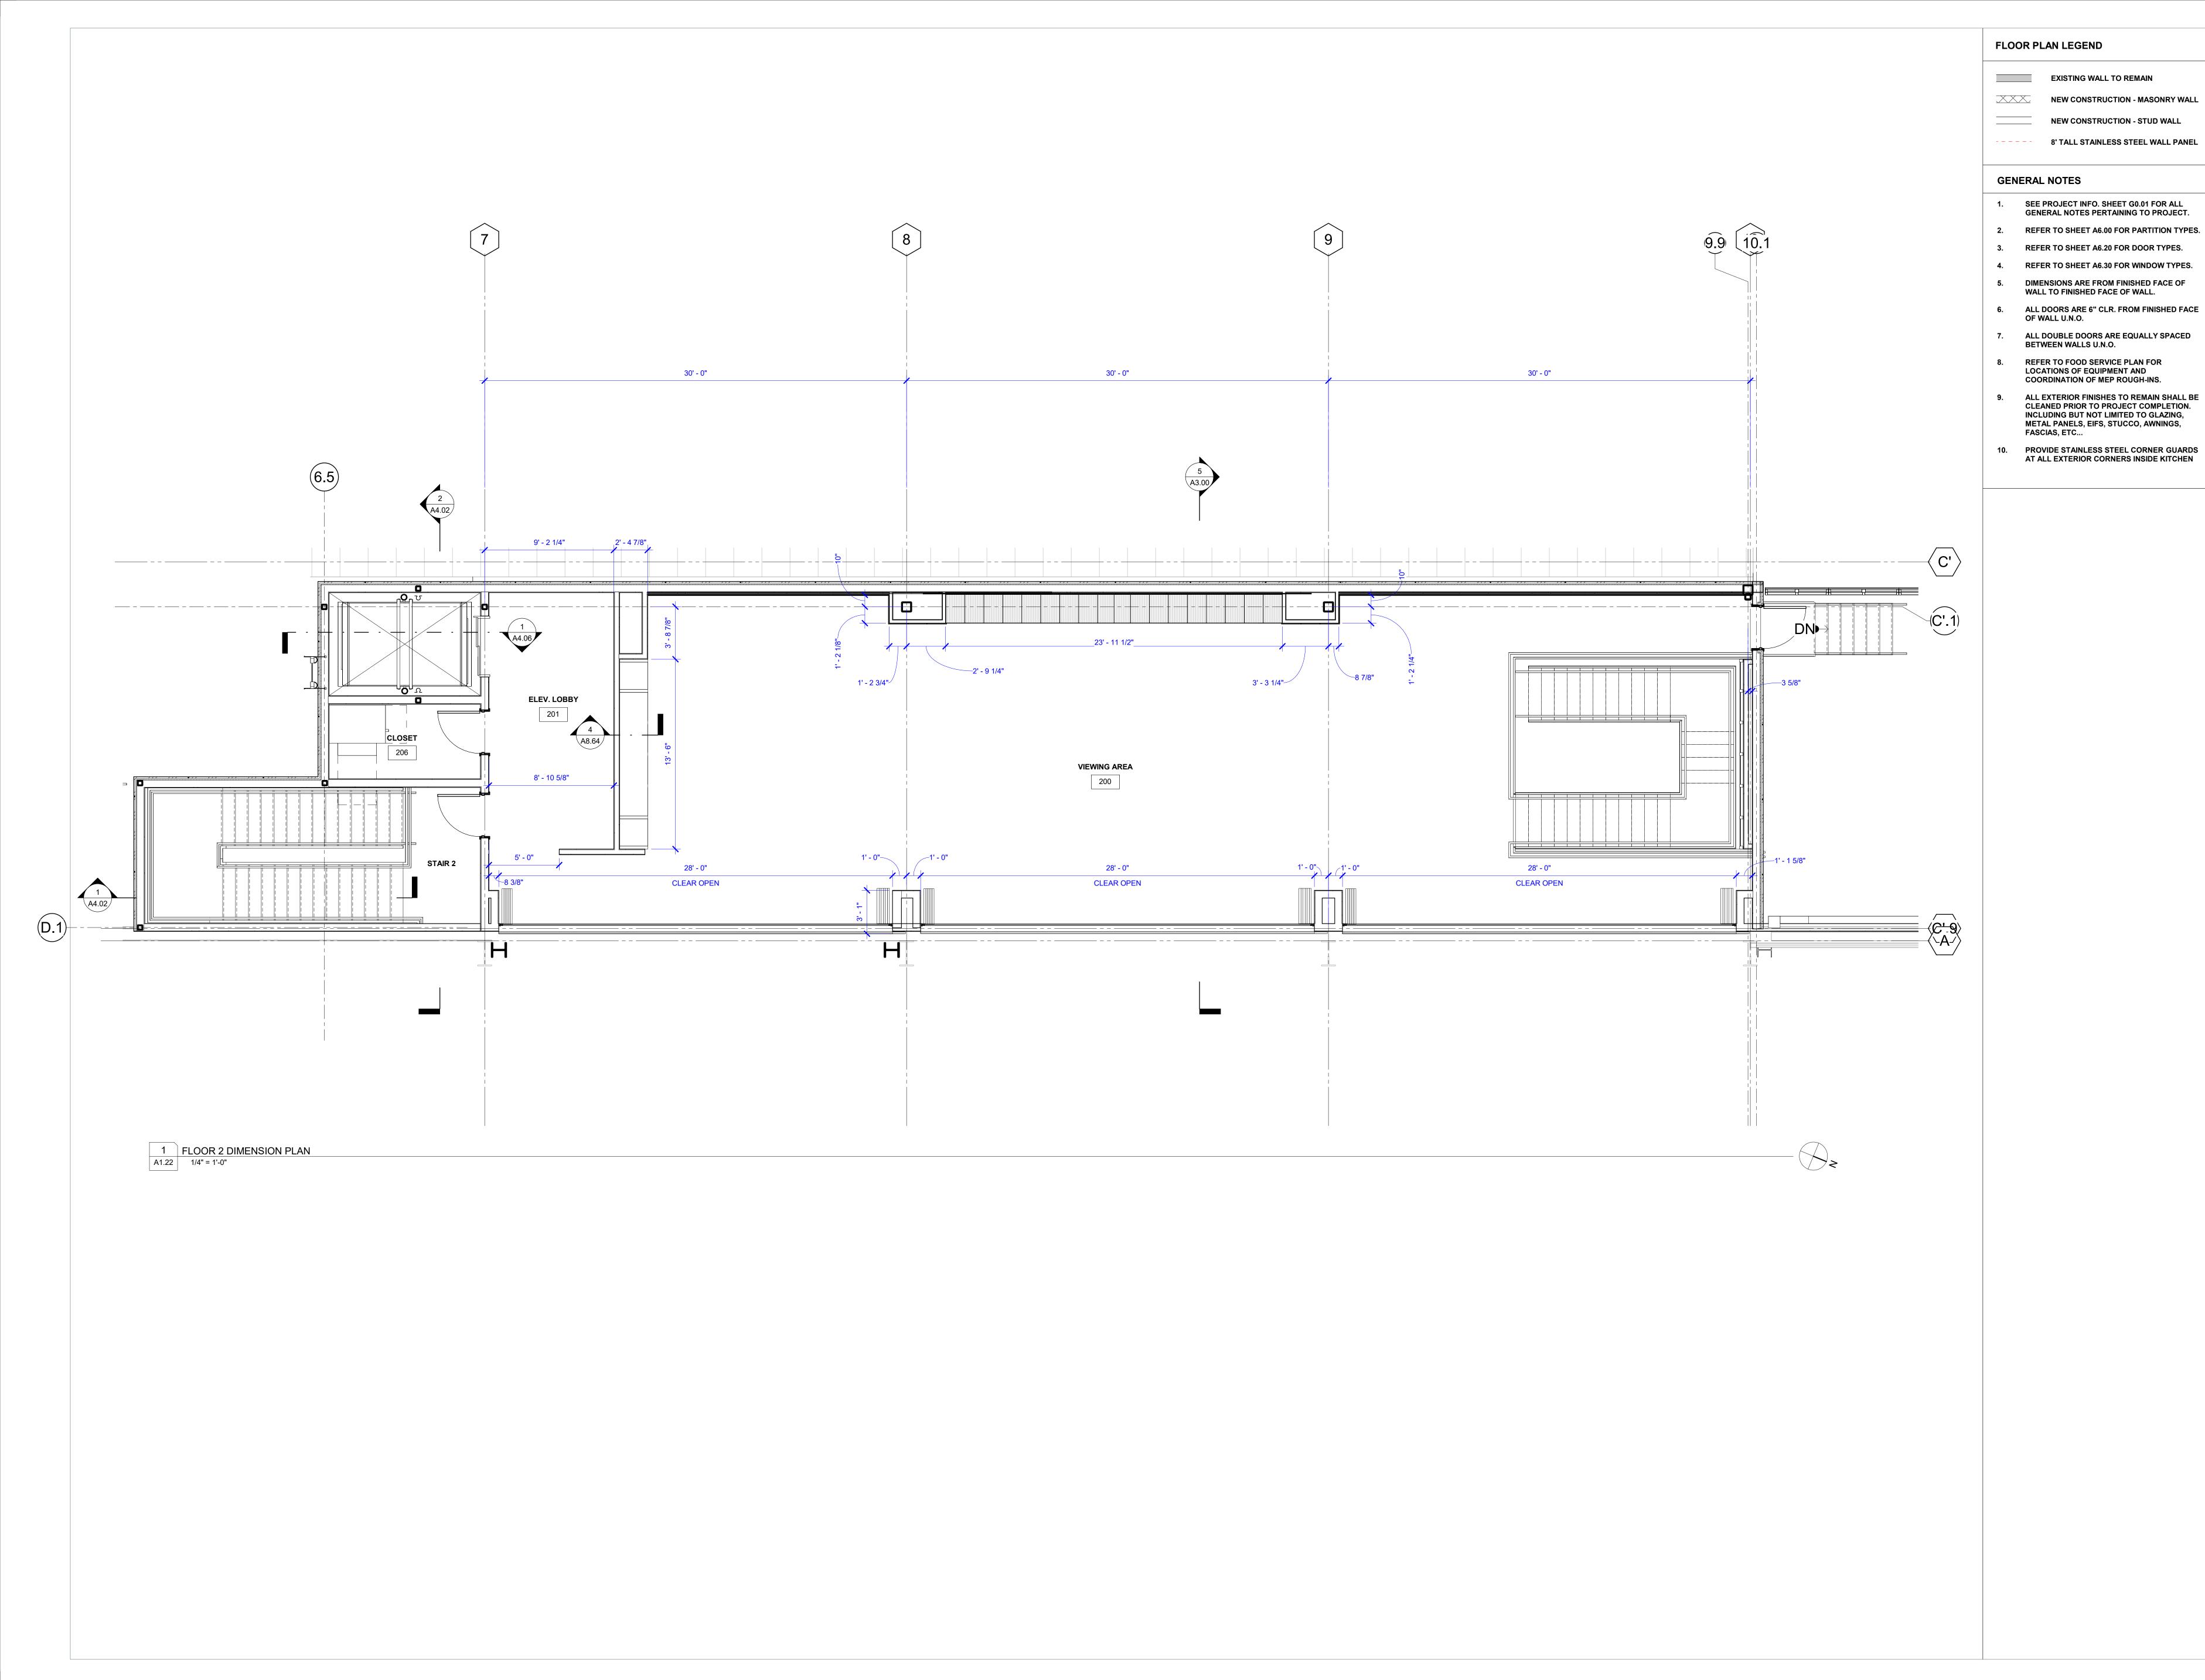
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N.O. SAINTS CAFETERIA & VIEWING EXPANSION 5800 Airline Drive Metairie, Louisiana WDG PROJECT NO | 6022-498 CONSTRUCTION DOCUMENTS 10/09/2023 REVISIONS FLOOR 2 PLAN

DRAWN BY | WDG A1.21

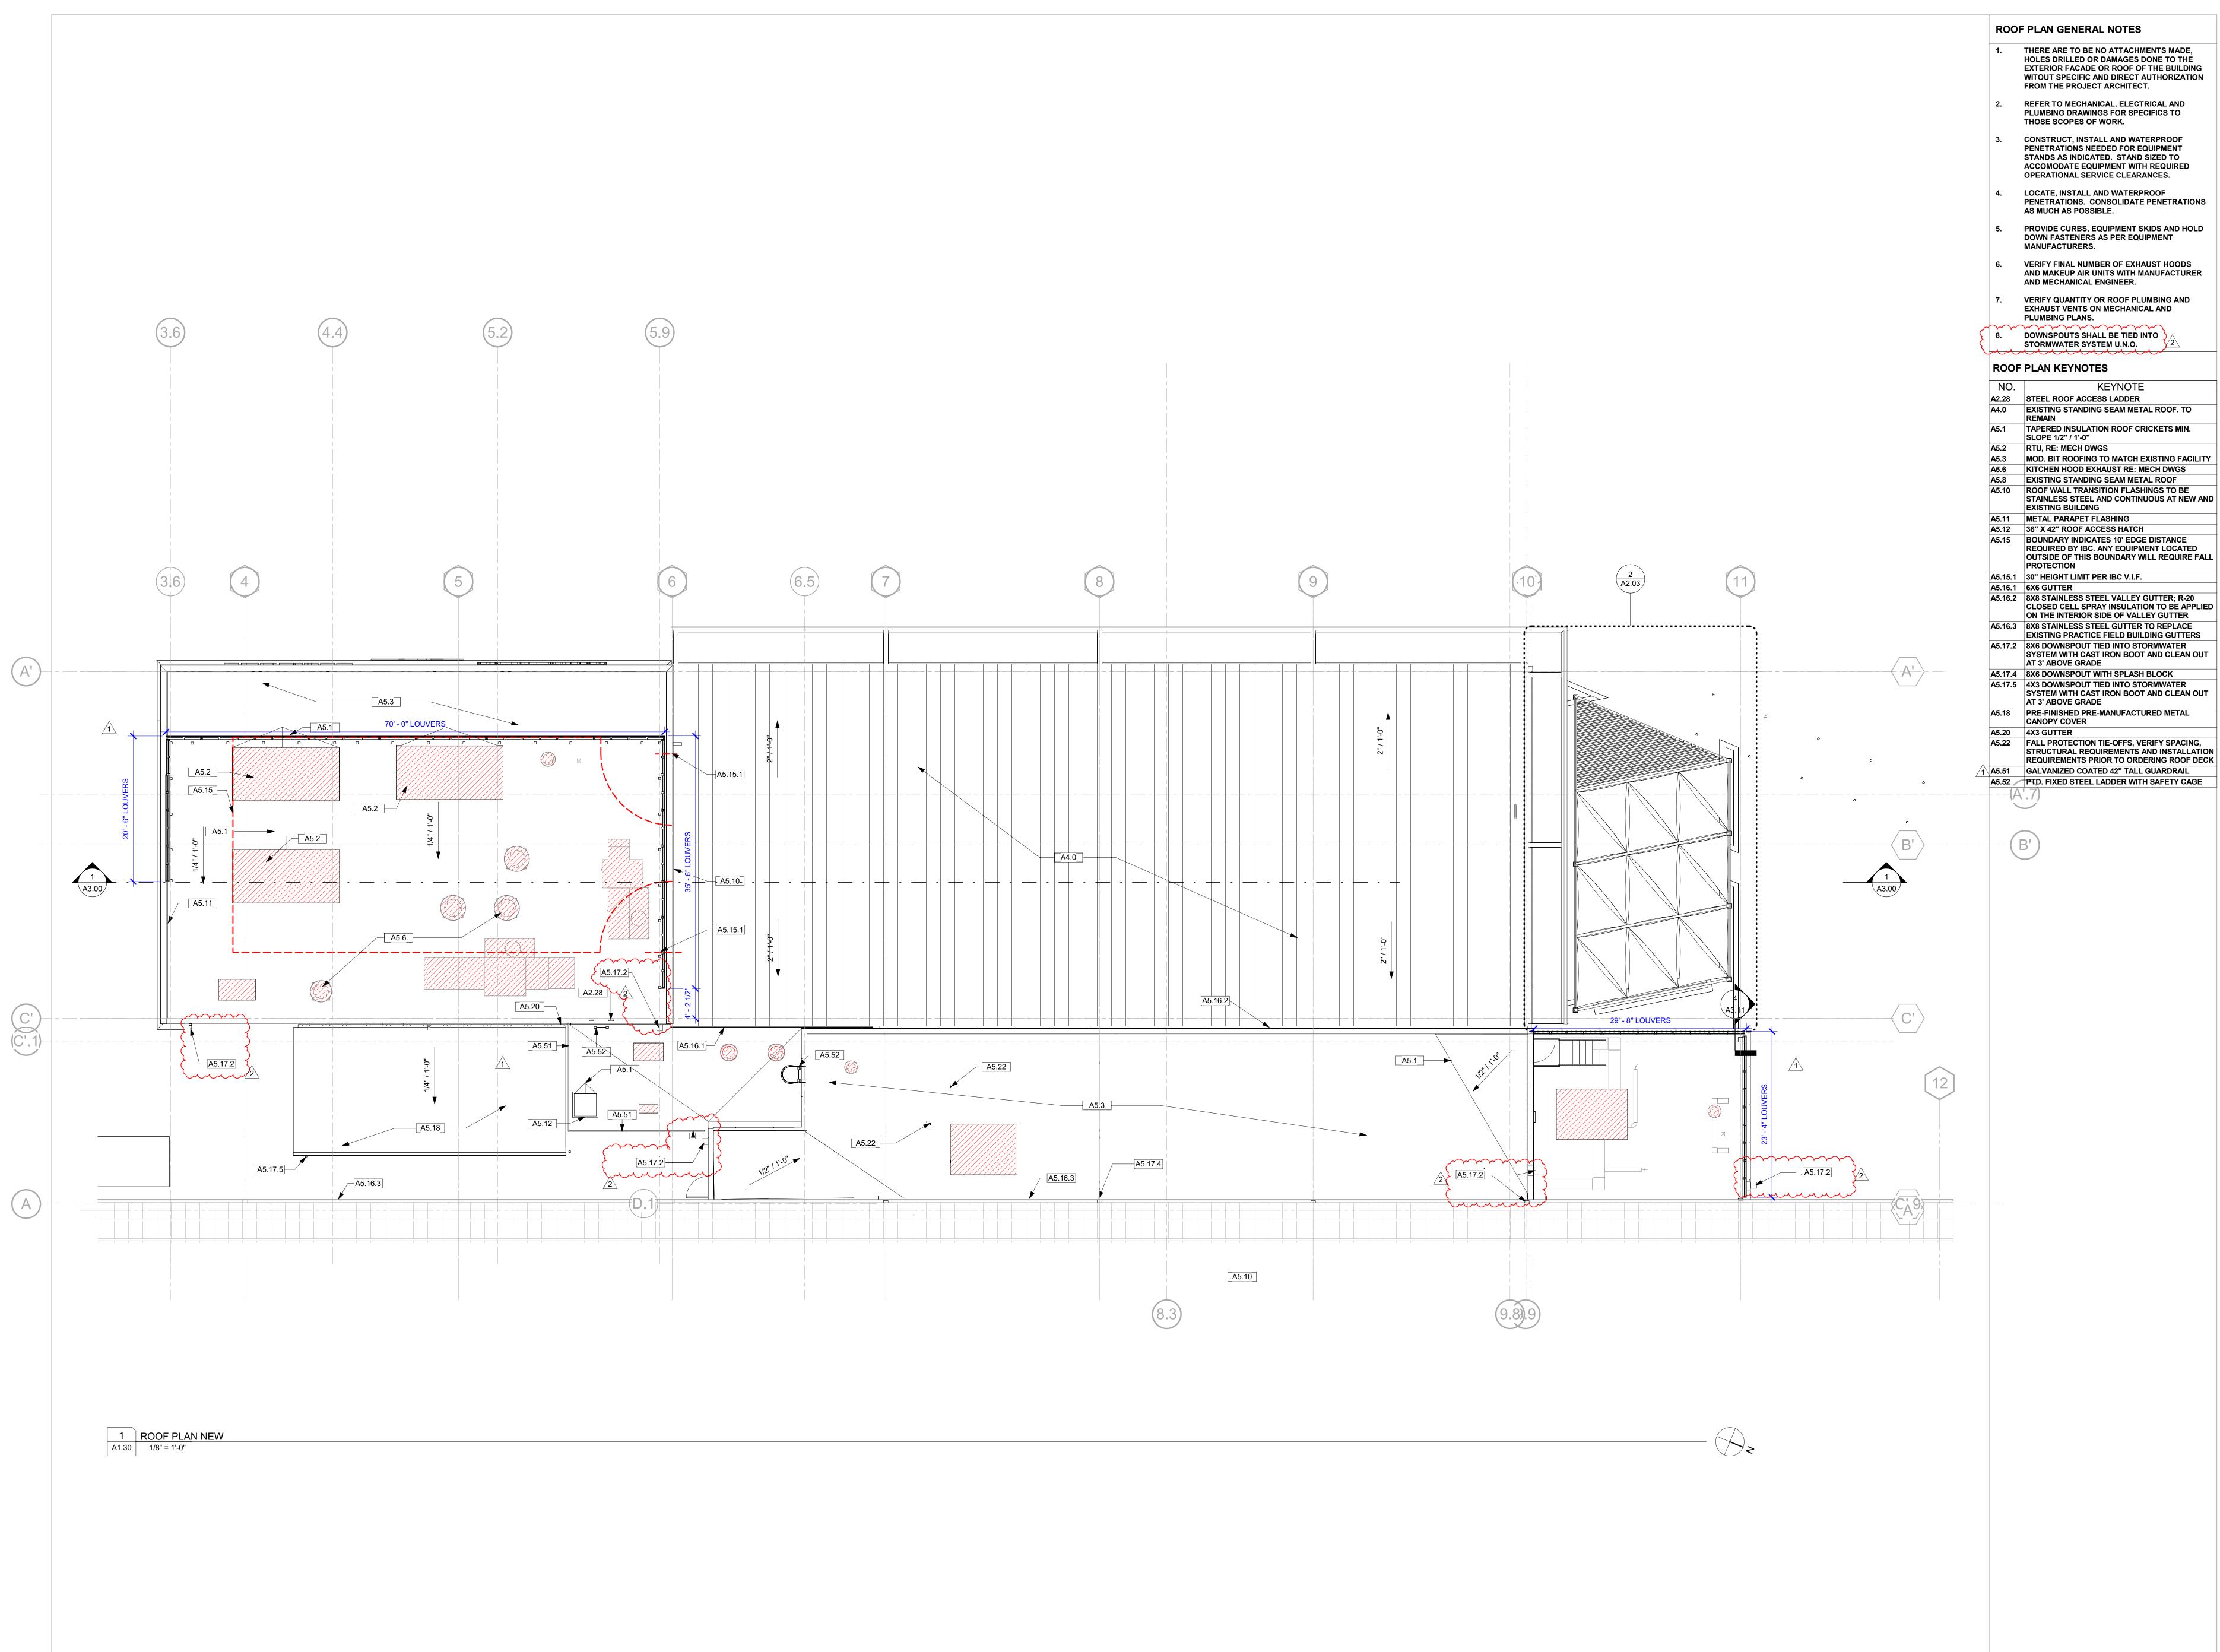




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 REVISIONS

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date \_\_\_\_\_ \_\_\_\_\_ \_\_\_\_\_ \_\_\_\_\_ \_\_\_\_\_ FLOOR 2 DIMENSION PLAN DRAWN BY | WDG A1.22



 $\sqrt{2}$ 

KEYNOTE



woodward design group 1000 S. NORMAN C. FRANCIS PARKWAY NEW ORLEANS, LA 70125 WOODWARDDESIGNBUILD.COM | 504-822-6443 Erik Wismar, AIA

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WDG PROJECT NO | 6022-498 CONSTRUCTION DOCUMENTS 10/09/2023

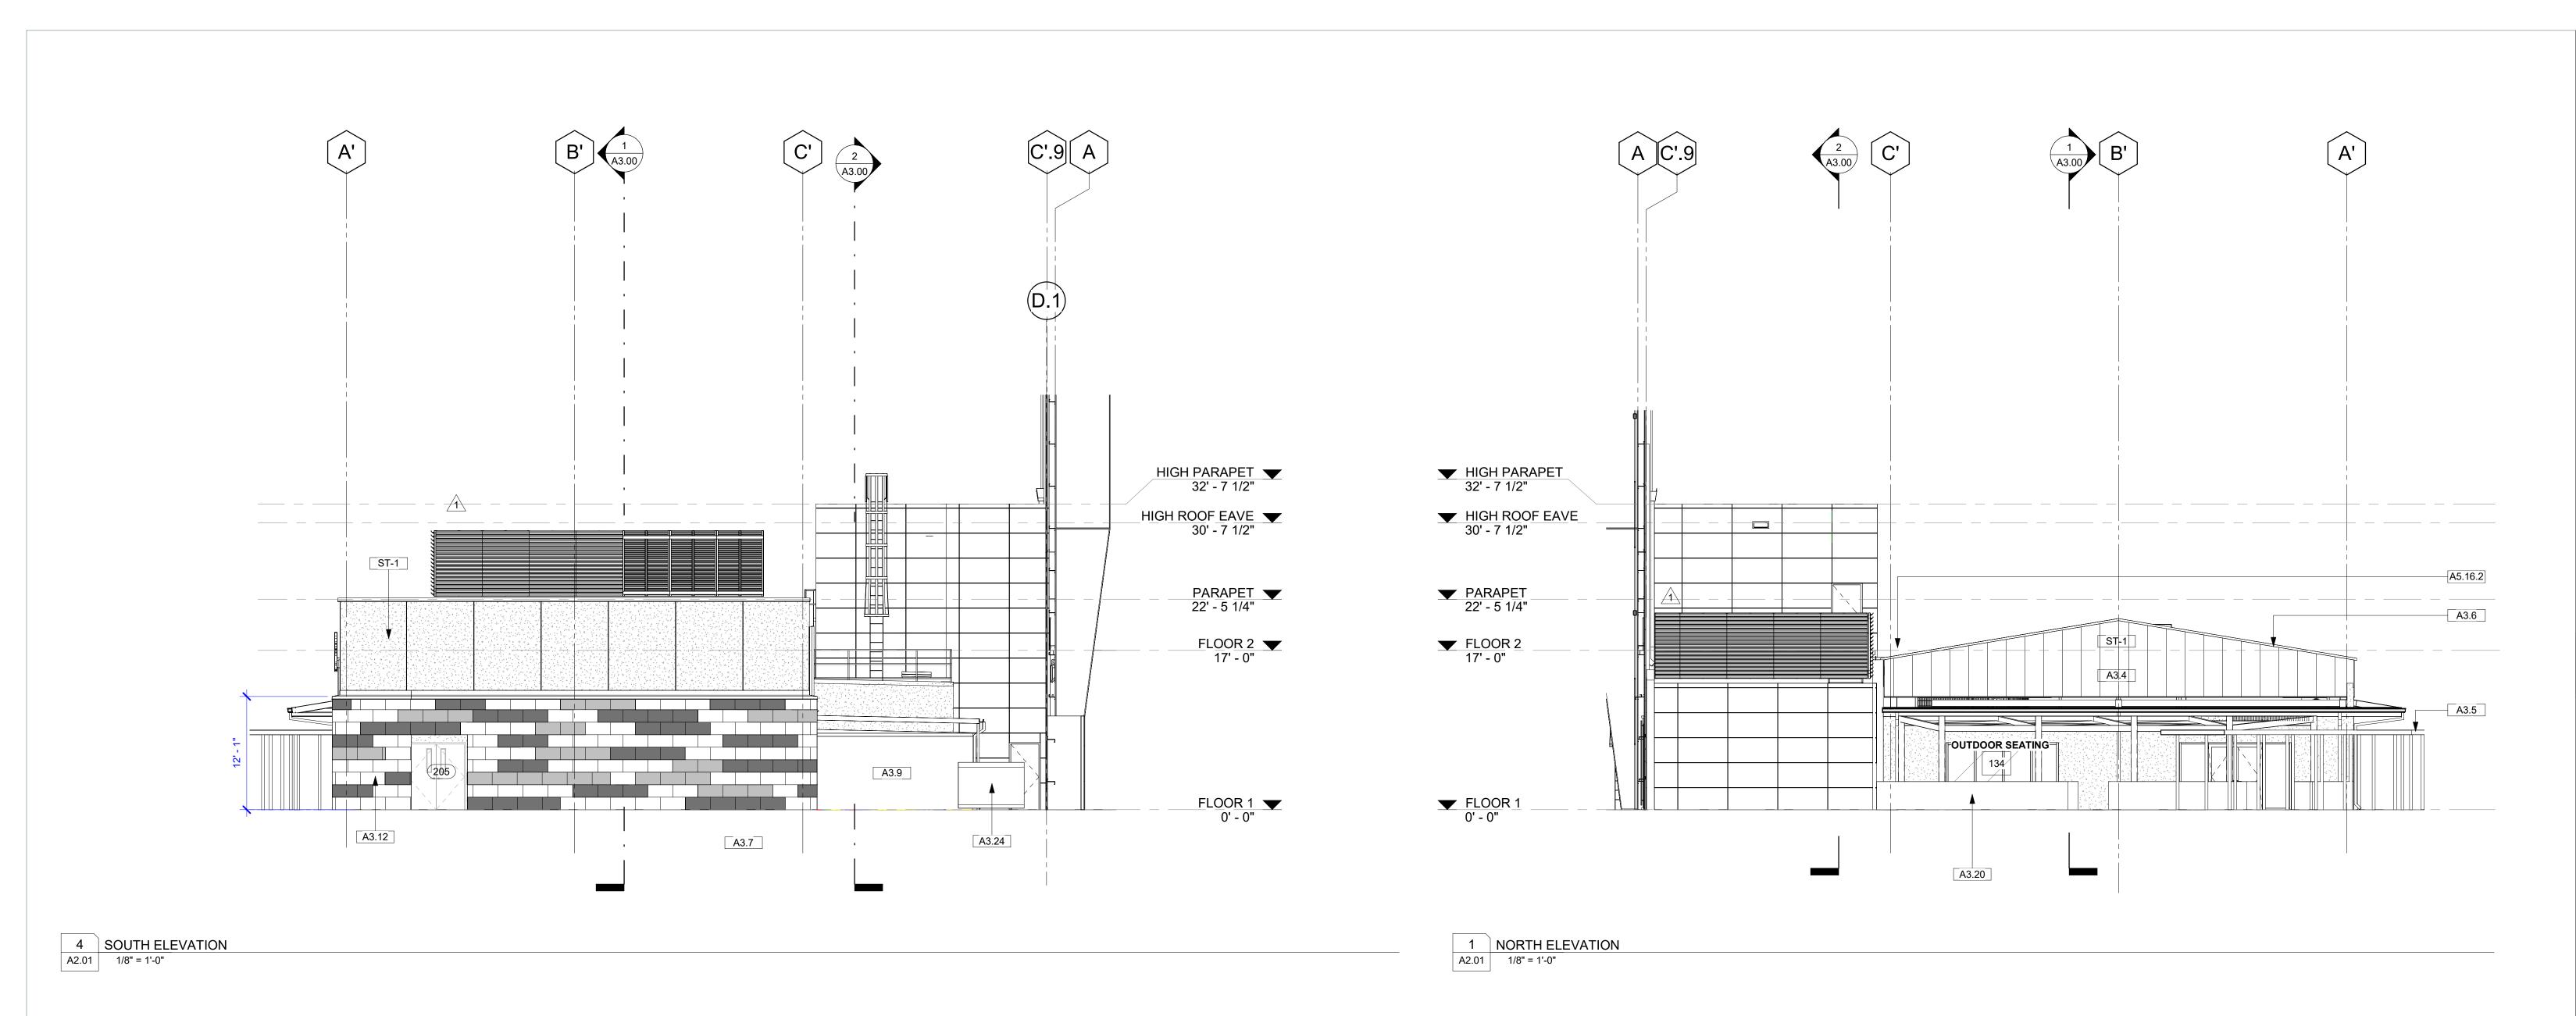
REVISIONS **ROOF PLAN** 

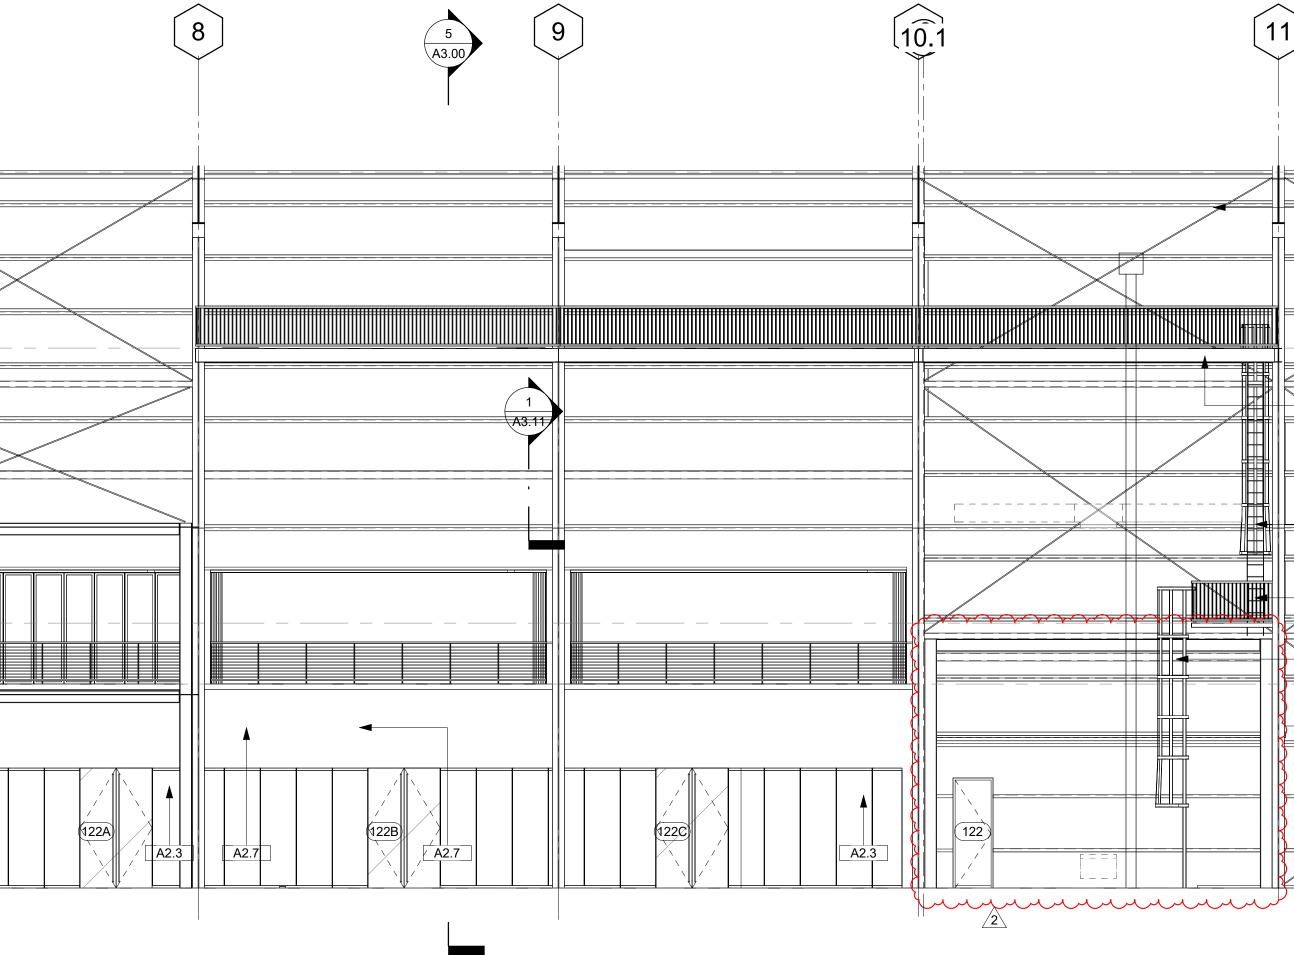
DRAWN BY | WDG A1.30

 3
 EAST ELEVATION 2

 A2.01
 1/8" = 1'-0"

|   | 6     | 6.5  | 7 |
|---|-------|------|---|
| PRACTICE BLDG EAVE                                      | (5.9) |      |   |
| VIDEO PLATFORM<br>45' - 0"                              |       | A2.4 |   |
| VIDEO LADDER LANDING<br>22' - 1"<br>FLOOR 2<br>17' - 0" |       |      |   |
| <u>FLOOR 1</u>  |       |      |   |





| 1     | 2 |
|-------|---|
| A2.4  |   |
| A3.18 |   |
| A2.22 |   |
| A2.21 |   |
| A2.21 |   |
|       |   |
|       |   |

| PLUMBING         3.9       EXTERIOR RATED REFRIGERATOR/FREEZER, RE:<br>FOOD SERVICE         3.12       CAST STONE VENEER, 3 COLOR PATTERN; MAIN<br>FIELD CAST STONE TO MATCH EXISTING PELICANS<br>AND SAINTS ENTRANCES         3.18       NEW LOCATION OF WINCH AND ASSOCIATED<br>HARDWARE AND CONTROLS, RE: STRUCTURAL FOR<br>SUPPORTS         3.20       CONCRETE LOW WALLS PROVIDE BOUNDARY FOR<br>OUTDOOR SEATING AREA         3.24       MECHANICAL EQUIPMENT RE: MECH         45.16.       8X8 STAINLESS STEEL VALLEY GUTTER; R-20<br>CLOSED CELL SPRAY INSULATION TO BE APPLIED   | NO.   | KEYNOTE   |
|--|-------|---|
| STRUCT         2.7       9'-6" ST45 NANAWALL; RE: ID         2.21       NEW LOCATION FOR VIEWING PLATFORM ACCESS<br>LADDER BELOW         2.22       NEW CATWALK FOR ACCESS TO VIEWING<br>PLATFORM         2.24       NEW LOCATION OF ACCESS LADDER LANDING;<br>FIELD VERIFY IF EXISTING PLATFORM CAN BE<br>REUSED OR IF A NEW PLATFORM WILL BE<br>REQUIRED         3.4       EXISTING EIFS FINISH; CLEAN ALL FINISHES TO<br>REMAIN         3.5       EXISTING ALUMINUM CANOPY TO REMAIN; TO BE<br>CLEANED         3.6       EXISTING STANDING SEAM ROOF         3.7       TRANSFER SWITCH AND GAS METER, RE: ELEC AND<br>PLUMBING         3.9       EXTERIOR RATED REFRIGERATOR/FREEZER, RE:<br>FOOD SERVICE         3.12       CAST STONE VENEER, 3 COLOR PATTERN; MAIN<br>FIELD CAST STONE TO MATCH EXISTING PELICANS<br>AND SAINTS ENTRANCES         3.18       NEW LOCATION OF WINCH AND ASSOCIATED<br>HARDWARE AND CONTROLS, RE: STRUCTURAL FOF<br>SUPPORTS         3.20       CONCRETE LOW WALLS PROVIDE BOUNDARY FOR<br>OUTDOOR SEATING AREA         3.24       MECHANICAL EQUIPMENT RE: MECH         5.16.       8X8 STAINLESS STEEL VALLEY GUTTER; R-20<br>CLOSED CELL SPRAY INSULATION TO BE APPLIED | 2.3   | OPEN TO FIELD W/ MTL GUARDRAIL  |
| <ul> <li>2.21 NEW LOCATION FOR VIEWING PLATFORM ACCESS<br/>LADDER BELOW</li> <li>2.22 NEW CATWALK FOR ACCESS TO VIEWING<br/>PLATFORM</li> <li>2.24 NEW LOCATION OF ACCESS LADDER LANDING;<br/>FIELD VERIFY IF EXISTING PLATFORM CAN BE<br/>REUSED OR IF A NEW PLATFORM WILL BE<br/>REQUIRED</li> <li>3.4 EXISTING EIFS FINISH; CLEAN ALL FINISHES TO<br/>REMAIN</li> <li>3.5 EXISTING ALUMINUM CANOPY TO REMAIN; TO BE<br/>CLEANED</li> <li>3.6 EXISTING STANDING SEAM ROOF</li> <li>3.7 TRANSFER SWITCH AND GAS METER, RE: ELEC AND<br/>PLUMBING</li> <li>3.9 EXTERIOR RATED REFRIGERATOR/FREEZER, RE:<br/>FOOD SERVICE</li> <li>3.12 CAST STONE VENEER, 3 COLOR PATTERN; MAIN<br/>FIELD CAST STONE TO MATCH EXISTING PELICANS<br/>AND SAINTS ENTRANCES</li> <li>3.18 NEW LOCATION OF WINCH AND ASSOCIATED<br/>HARDWARE AND CONTROLS, RE: STRUCTURAL FOR<br/>SUPPORTS</li> <li>3.20 CONCRETE LOW WALLS PROVIDE BOUNDARY FOR<br/>OUTDOOR SEATING AREA</li> <li>3.24 MECHANICAL EQUIPMENT RE: MECH</li> <li>5.16. 8X8 STAINLESS STEEL VALLEY GUTTER; R-20<br/>CLOSED CELL SPRAY INSULATION TO BE APPLIED</li> </ul>   | 2.4   |   |
| LADDER BELOW         2.22       NEW CATWALK FOR ACCESS TO VIEWING<br>PLATFORM         2.24       NEW LOCATION OF ACCESS LADDER LANDING;<br>FIELD VERIFY IF EXISTING PLATFORM CAN BE<br>REUSED OR IF A NEW PLATFORM WILL BE<br>REQUIRED         3.4       EXISTING EIFS FINISH; CLEAN ALL FINISHES TO<br>REMAIN         3.5       EXISTING ALUMINUM CANOPY TO REMAIN; TO BE<br>CLEANED         3.6       EXISTING STANDING SEAM ROOF         3.7       TRANSFER SWITCH AND GAS METER, RE: ELEC AND<br>PLUMBING         3.9       EXTERIOR RATED REFRIGERATOR/FREEZER, RE:<br>FOOD SERVICE         3.12       CAST STONE VENEER, 3 COLOR PATTERN; MAIN<br>FIELD CAST STONE TO MATCH EXISTING PELICANS<br>AND SAINTS ENTRANCES         3.18       NEW LOCATION OF WINCH AND ASSOCIATED<br>HARDWARE AND CONTROLS, RE: STRUCTURAL FOF<br>SUPPORTS         3.20       CONCRETE LOW WALLS PROVIDE BOUNDARY FOR<br>OUTDOOR SEATING AREA         3.24       MECHANICAL EQUIPMENT RE: MECH         5.16.       8X8 STAINLESS STEEL VALLEY GUTTER; R-20<br>CLOSED CELL SPRAY INSULATION TO BE APPLIED   | 2.7   |   |
| PLATFORM         2.24       NEW LOCATION OF ACCESS LADDER LANDING;<br>FIELD VERIFY IF EXISTING PLATFORM CAN BE<br>REUSED OR IF A NEW PLATFORM WILL BE<br>REQUIRED         3.4       EXISTING EIFS FINISH; CLEAN ALL FINISHES TO<br>REMAIN         3.5       EXISTING ALUMINUM CANOPY TO REMAIN; TO BE<br>CLEANED         3.6       EXISTING STANDING SEAM ROOF         3.7       TRANSFER SWITCH AND GAS METER, RE: ELEC AND<br>PLUMBING         3.9       EXTERIOR RATED REFRIGERATOR/FREEZER, RE:<br>FOOD SERVICE         3.12       CAST STONE VENEER, 3 COLOR PATTERN; MAIN<br>FIELD CAST STONE TO MATCH EXISTING PELICANS<br>AND SAINTS ENTRANCES         3.18       NEW LOCATION OF WINCH AND ASSOCIATED<br>HARDWARE AND CONTROLS, RE: STRUCTURAL FOR<br>SUPPORTS         3.20       CONCRETE LOW WALLS PROVIDE BOUNDARY FOR<br>OUTDOOR SEATING AREA         3.24       MECHANICAL EQUIPMENT RE: MECH         5.16.       8X8 STAINLESS STEEL VALLEY GUTTER; R-20<br>CLOSED CELL SPRAY INSULATION TO BE APPLIED  |       | LADDER BELOW  |
| FIELD VERIFY IF EXISTING PLATFORM CAN BE<br>REUSED OR IF A NEW PLATFORM WILL BE<br>REQUIRED3.4EXISTING EIFS FINISH; CLEAN ALL FINISHES TO<br>REMAIN3.5EXISTING ALUMINUM CANOPY TO REMAIN; TO BE<br>CLEANED3.6EXISTING STANDING SEAM ROOF3.7TRANSFER SWITCH AND GAS METER, RE: ELEC AND<br>PLUMBING3.9EXTERIOR RATED REFRIGERATOR/FREEZER, RE:<br>FOOD SERVICE3.12CAST STONE VENEER, 3 COLOR PATTERN; MAIN<br>FIELD CAST STONE TO MATCH EXISTING PELICANS<br>AND SAINTS ENTRANCES3.18NEW LOCATION OF WINCH AND ASSOCIATED<br>HARDWARE AND CONTROLS, RE: STRUCTURAL FOR<br>SUPPORTS3.20CONCRETE LOW WALLS PROVIDE BOUNDARY FOR<br>OUTDOOR SEATING AREA3.24MECHANICAL EQUIPMENT RE: MECH<br>\$5.16.5.16.8X8 STAINLESS STEEL VALLEY GUTTER; R-20<br>CLOSED CELL SPRAY INSULATION TO BE APPLIED   | 2.22  |   |
| REMAIN         33.5       EXISTING ALUMINUM CANOPY TO REMAIN; TO BE CLEANED         33.6       EXISTING STANDING SEAM ROOF         33.7       TRANSFER SWITCH AND GAS METER, RE: ELEC AND PLUMBING         33.9       EXTERIOR RATED REFRIGERATOR/FREEZER, RE: FOOD SERVICE         33.12       CAST STONE VENEER, 3 COLOR PATTERN; MAIN FIELD CAST STONE TO MATCH EXISTING PELICANS AND SAINTS ENTRANCES         33.18       NEW LOCATION OF WINCH AND ASSOCIATED HARDWARE AND CONTROLS, RE: STRUCTURAL FOR SUPPORTS         33.20       CONCRETE LOW WALLS PROVIDE BOUNDARY FOR OUTDOOR SEATING AREA         33.24       MECHANICAL EQUIPMENT RE: MECH         43.24       MECHANICAL EQUIPMENT RE: MECH         43.24       STAINLESS STEEL VALLEY GUTTER; R-20 CLOSED CELL SPRAY INSULATION TO BE APPLIED  | 2.24  | FIELD VERIFY IF EXISTING PLATFORM CAN BE<br>REUSED OR IF A NEW PLATFORM WILL BE |
| CLEANED3.6EXISTING STANDING SEAM ROOF3.7TRANSFER SWITCH AND GAS METER, RE: ELEC AND<br>PLUMBING3.9EXTERIOR RATED REFRIGERATOR/FREEZER, RE:<br>FOOD SERVICE3.12CAST STONE VENEER, 3 COLOR PATTERN; MAIN<br>FIELD CAST STONE TO MATCH EXISTING PELICANS<br>AND SAINTS ENTRANCES3.18NEW LOCATION OF WINCH AND ASSOCIATED<br>HARDWARE AND CONTROLS, RE: STRUCTURAL FOR<br>SUPPORTS3.20CONCRETE LOW WALLS PROVIDE BOUNDARY FOR<br>OUTDOOR SEATING AREA3.24MECHANICAL EQUIPMENT RE: MECH<br>\$3.16.\$5.16.8X8 STAINLESS STEEL VALLEY GUTTER; R-20<br>CLOSED CELL SPRAY INSULATION TO BE APPLIED  | 3.4   |   |
| <ul> <li>3.7 TRANSFER SWITCH AND GAS METER, RE: ELEC AND<br/>PLUMBING</li> <li>3.9 EXTERIOR RATED REFRIGERATOR/FREEZER, RE:<br/>FOOD SERVICE</li> <li>3.12 CAST STONE VENEER, 3 COLOR PATTERN; MAIN<br/>FIELD CAST STONE TO MATCH EXISTING PELICANS<br/>AND SAINTS ENTRANCES</li> <li>3.18 NEW LOCATION OF WINCH AND ASSOCIATED<br/>HARDWARE AND CONTROLS, RE: STRUCTURAL FOR<br/>SUPPORTS</li> <li>3.20 CONCRETE LOW WALLS PROVIDE BOUNDARY FOR<br/>OUTDOOR SEATING AREA</li> <li>3.24 MECHANICAL EQUIPMENT RE: MECH</li> <li>5.16. 8X8 STAINLESS STEEL VALLEY GUTTER; R-20<br/>CLOSED CELL SPRAY INSULATION TO BE APPLIED</li> </ul>   | 3.5   |   |
| PLUMBING         3.9       EXTERIOR RATED REFRIGERATOR/FREEZER, RE:         FOOD SERVICE         3.12       CAST STONE VENEER, 3 COLOR PATTERN; MAIN         FIELD CAST STONE TO MATCH EXISTING PELICANS AND SAINTS ENTRANCES         3.18       NEW LOCATION OF WINCH AND ASSOCIATED         HARDWARE AND CONTROLS, RE: STRUCTURAL FOR SUPPORTS         3.20       CONCRETE LOW WALLS PROVIDE BOUNDARY FOR OUTDOOR SEATING AREA         3.24       MECHANICAL EQUIPMENT RE: MECH         5.16.       8X8 STAINLESS STEEL VALLEY GUTTER; R-20 CLOSED CELL SPRAY INSULATION TO BE APPLIED   | 3.6   | EXISTING STANDING SEAM ROOF   |
| FOOD SERVICE3.12CAST STONE VENEER, 3 COLOR PATTERN; MAIN<br>FIELD CAST STONE TO MATCH EXISTING PELICANS<br>AND SAINTS ENTRANCES3.18NEW LOCATION OF WINCH AND ASSOCIATED<br>HARDWARE AND CONTROLS, RE: STRUCTURAL FOR<br>SUPPORTS3.20CONCRETE LOW WALLS PROVIDE BOUNDARY FOR<br>OUTDOOR SEATING AREA3.24MECHANICAL EQUIPMENT RE: MECH<br>5.16.5.16.8X8 STAINLESS STEEL VALLEY GUTTER; R-20<br>CLOSED CELL SPRAY INSULATION TO BE APPLIED  | 3.7   | TRANSFER SWITCH AND GAS METER, RE: ELEC AND PLUMBING                            |
| FIELD CAST STONE TO MATCH EXISTING PELICANS<br>AND SAINTS ENTRANCES<br>3.18 NEW LOCATION OF WINCH AND ASSOCIATED<br>HARDWARE AND CONTROLS, RE: STRUCTURAL FOR<br>SUPPORTS<br>3.20 CONCRETE LOW WALLS PROVIDE BOUNDARY FOR<br>OUTDOOR SEATING AREA<br>3.24 MECHANICAL EQUIPMENT RE: MECH<br>5.16. 8X8 STAINLESS STEEL VALLEY GUTTER; R-20<br>CLOSED CELL SPRAY INSULATION TO BE APPLIED   | 3.9   |   |
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| 5.16. 8X8 STAINLESS STEEL VALLEY GUTTER; R-20<br>CLOSED CELL SPRAY INSULATION TO BE APPLIED  | 3.20  |   |
| CLOSED CELL SPRAY INSULATION TO BE APPLIED   | -     |   |
| ON THE INTERIOR SIDE OF VALLEY GUTTER  | 5.16. |   |
|  | EXTE  | ERIOR WALL FINISH LEGEND  |
| EXTERIOR WALL FINISH LEGEND  | ST-1  | STUCCO COLOR  |

| EXTEF | RIOR WALL FINISH LEGEND |
|-------|-------------------------|
| ST-1  | STUCCO COLOR            |
| CS-1  | CAST STONE COLOR        |
| CS-2  | CAST STONE COLOR        |
| CS-3  | CAST STONE COLOR        |
|       |                         |



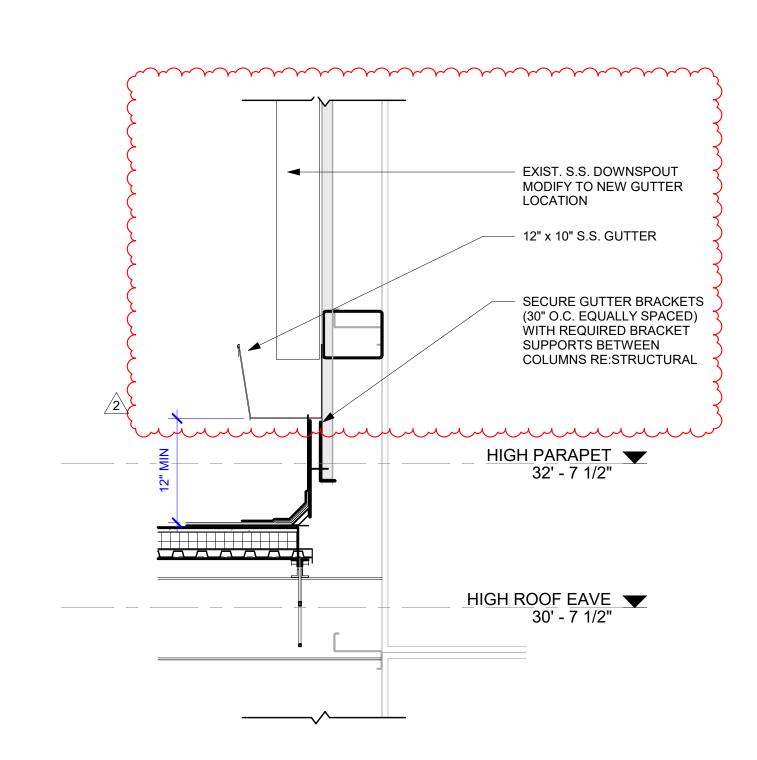
woodward design group 1000 S. NORMAN C. FRANCIS PARKWAY NEW ORLEANS, LA 70125 WOODWARDDESIGNBUILD.COM | 504-822-6443 Erik Wismar, AIA

N.O. SAINTS CAFETERIA & VIEWING EXPANSION 5800 Airline Drive Metairie, Louisiana WDG PROJECT NO | 6022-498 CONSTRUCTION DOCUMENTS 10/09/2023 REVISIONSno.descriptondate1Revision 110/23/232Revision 210/30/23

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|          |  |

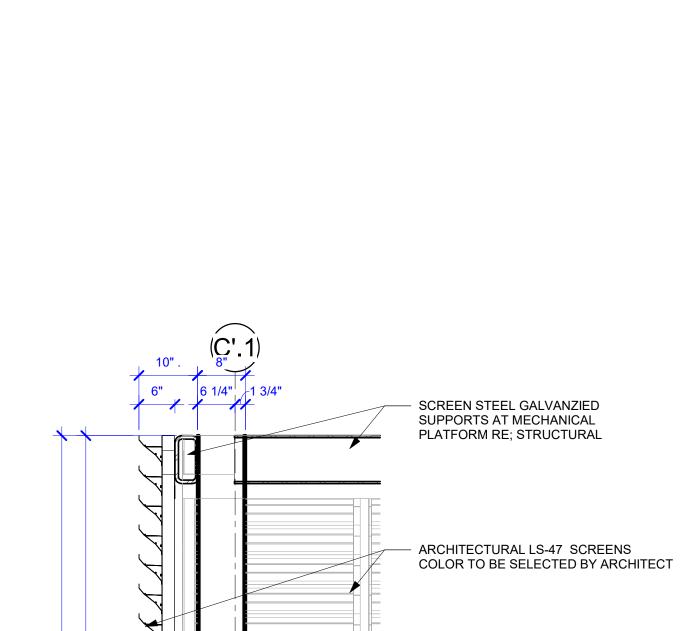
EXTERIOR ELEVATIONS

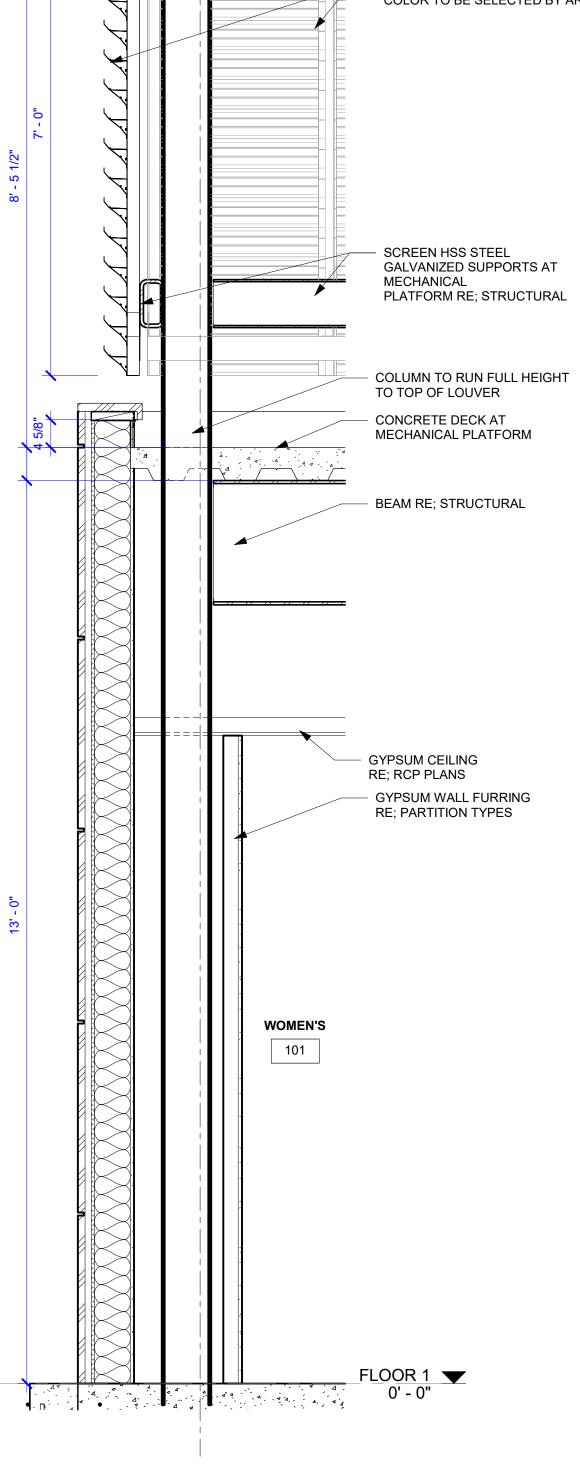
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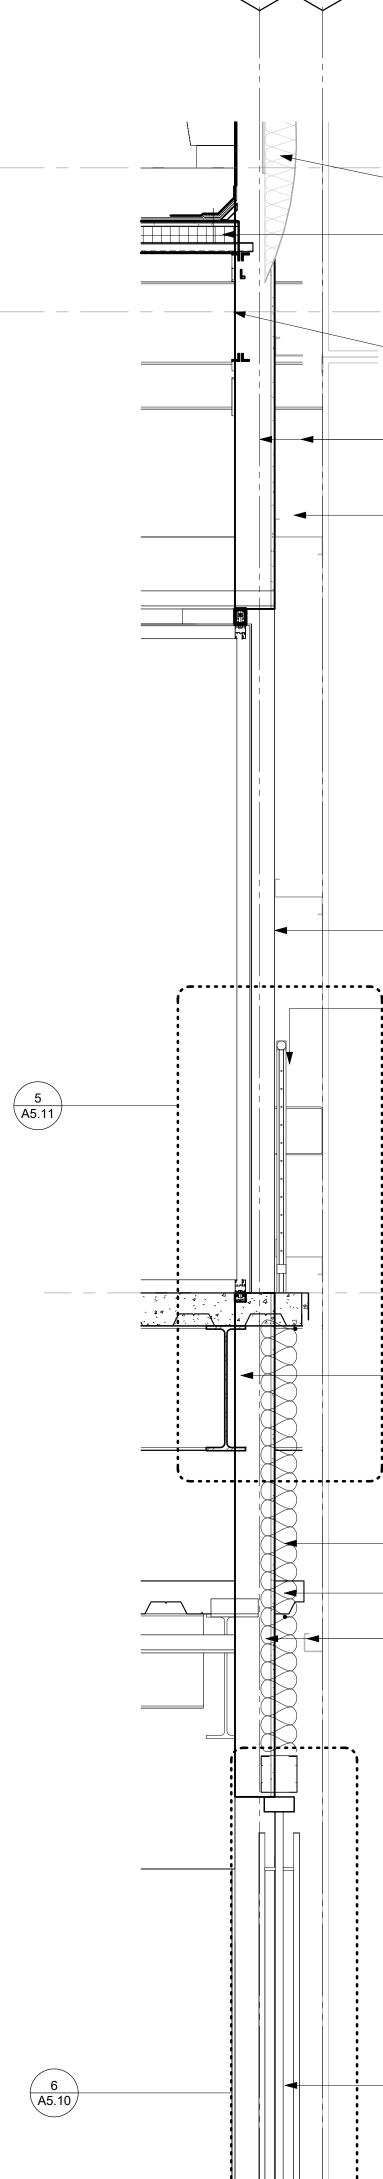
 1
 12" ROOF DRAIN PIPE SUPPORT

 A3.11
 3/4" = 1'-0"





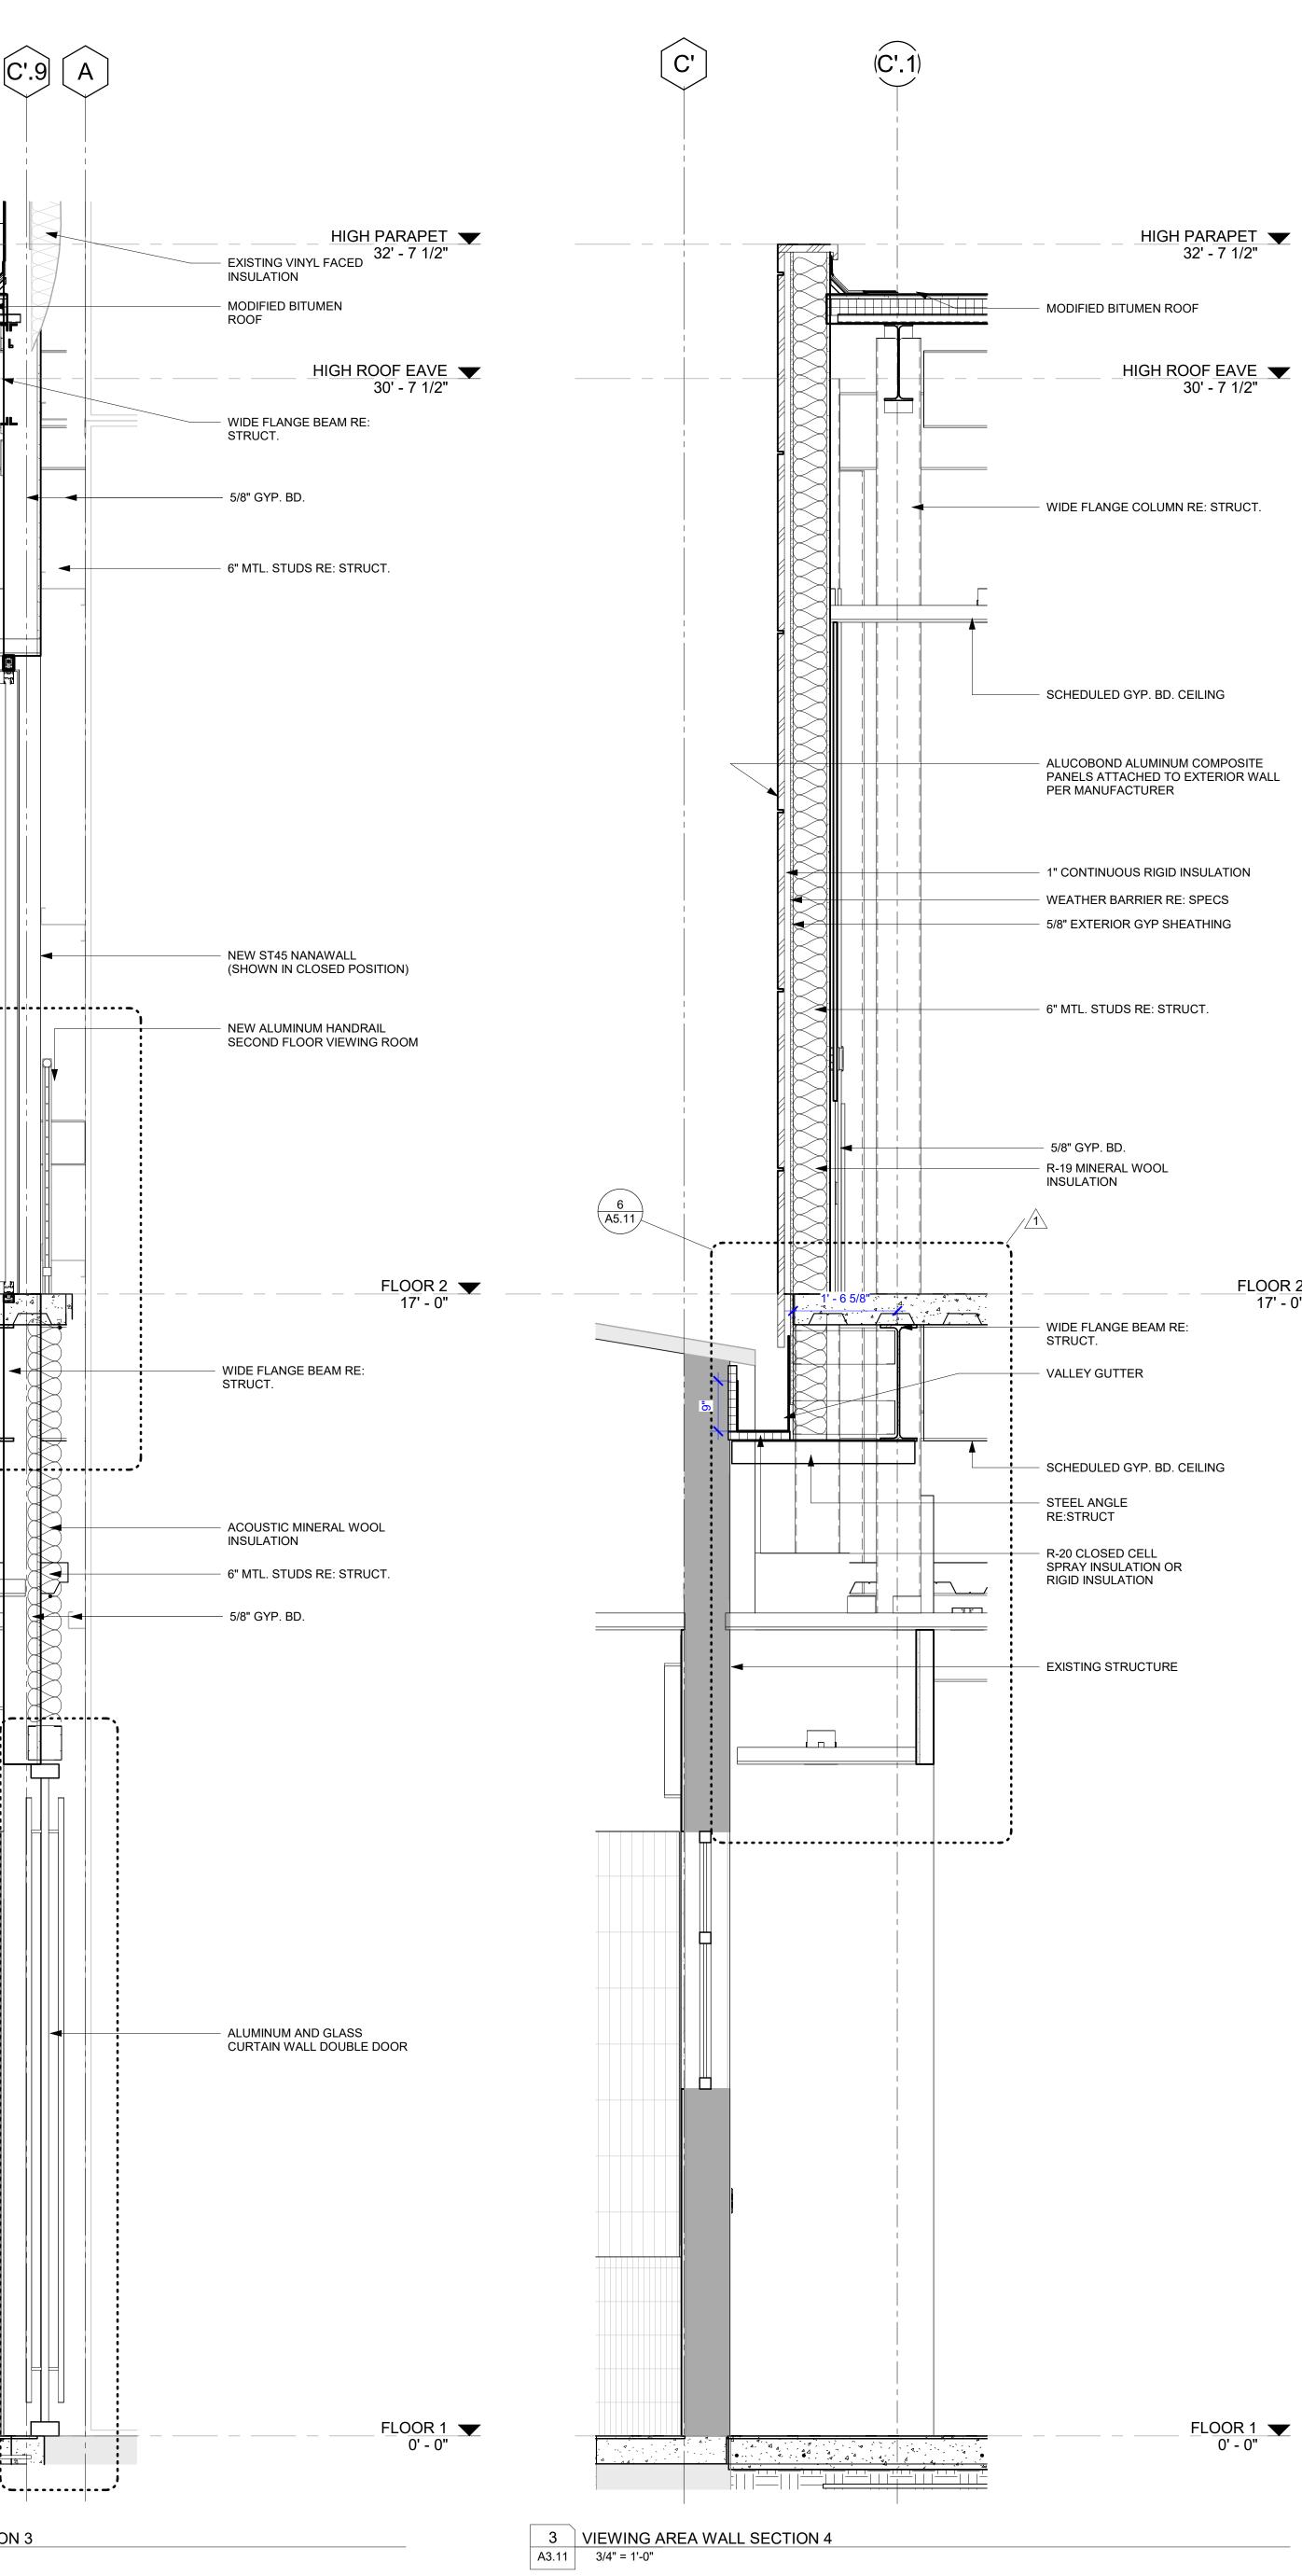
4MECH. TERRACE WALL SECTIONA3.113/4" = 1'-0"



 $\underline{1}$ 

 2
 VIEWING AREA WALL SECTION 3

 A3.11
 3/4" = 1'-0"



# FLOOR 2 **T**

<u>FLOOR 1</u> 0' - 0"



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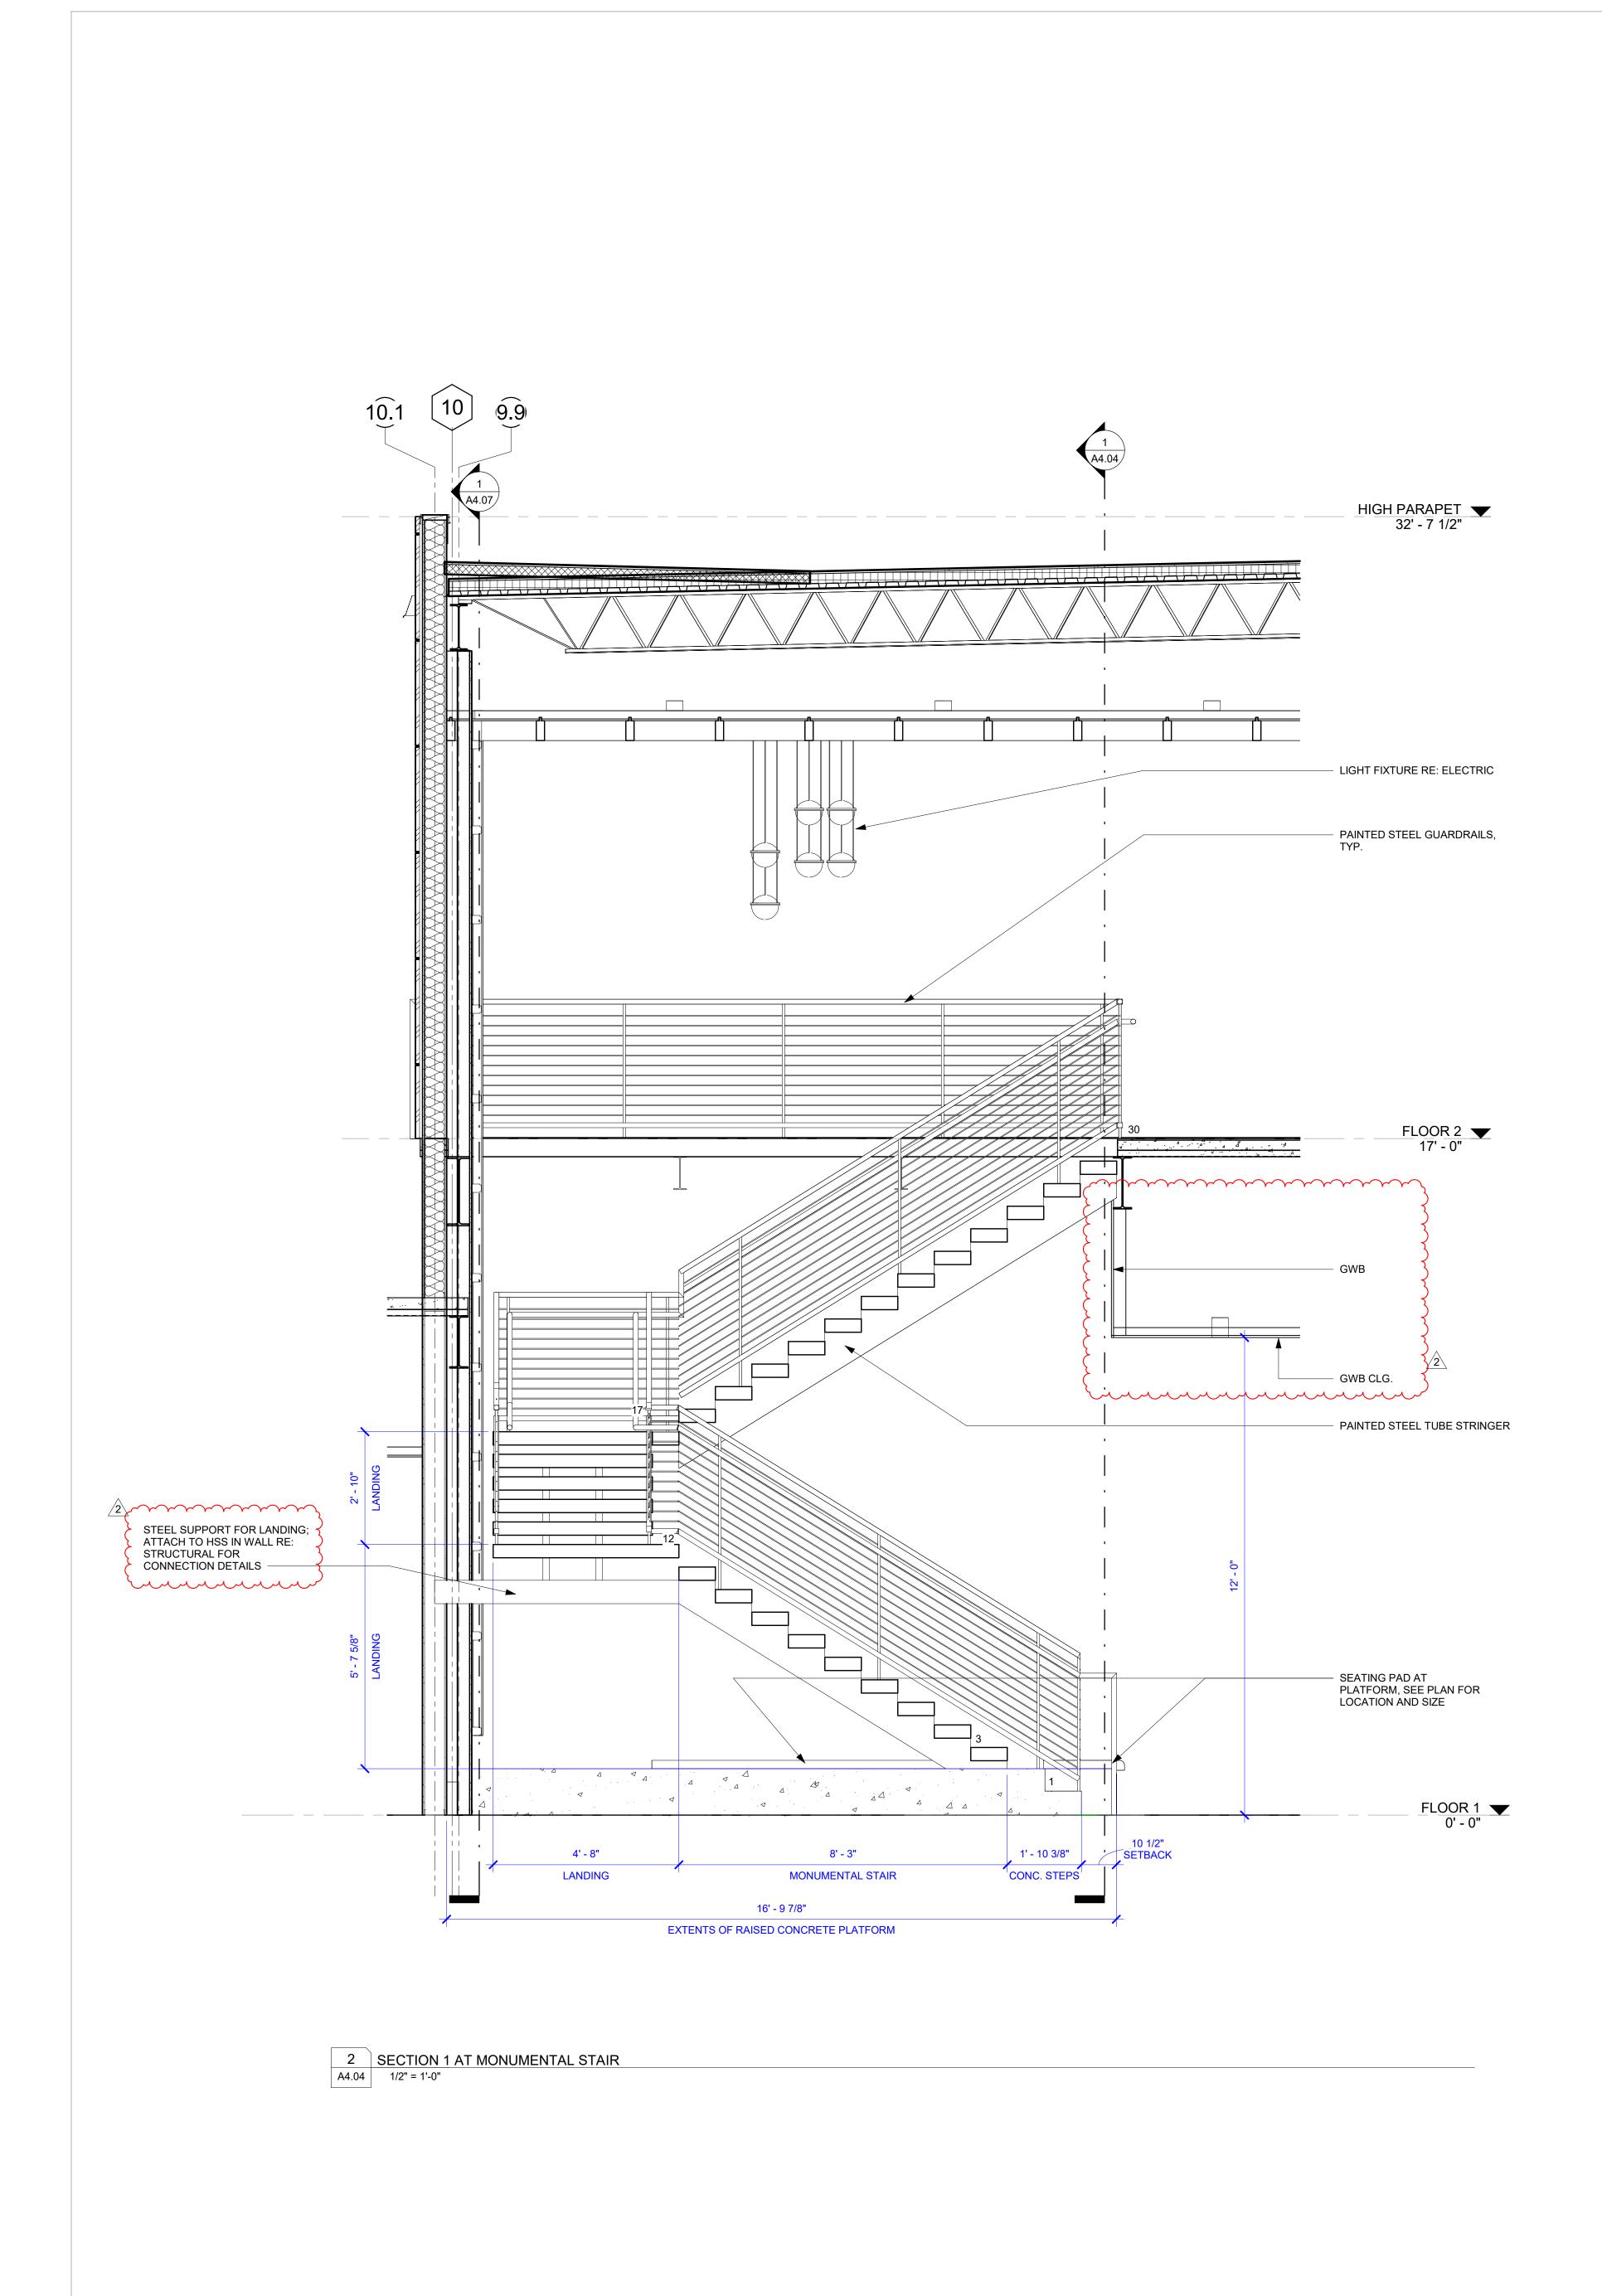
## N.O. SAINTS CAFETERIA & VIEWING EXPANSION 5800 Airline Drive Metairie, Louisiana

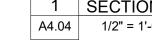
WDG PROJECT NO | 6022-498 CONSTRUCTION DOCUMENTS 10/09/2023

REVISIONS descripton

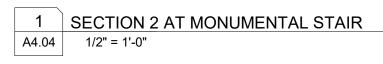
WALL SECTIONS

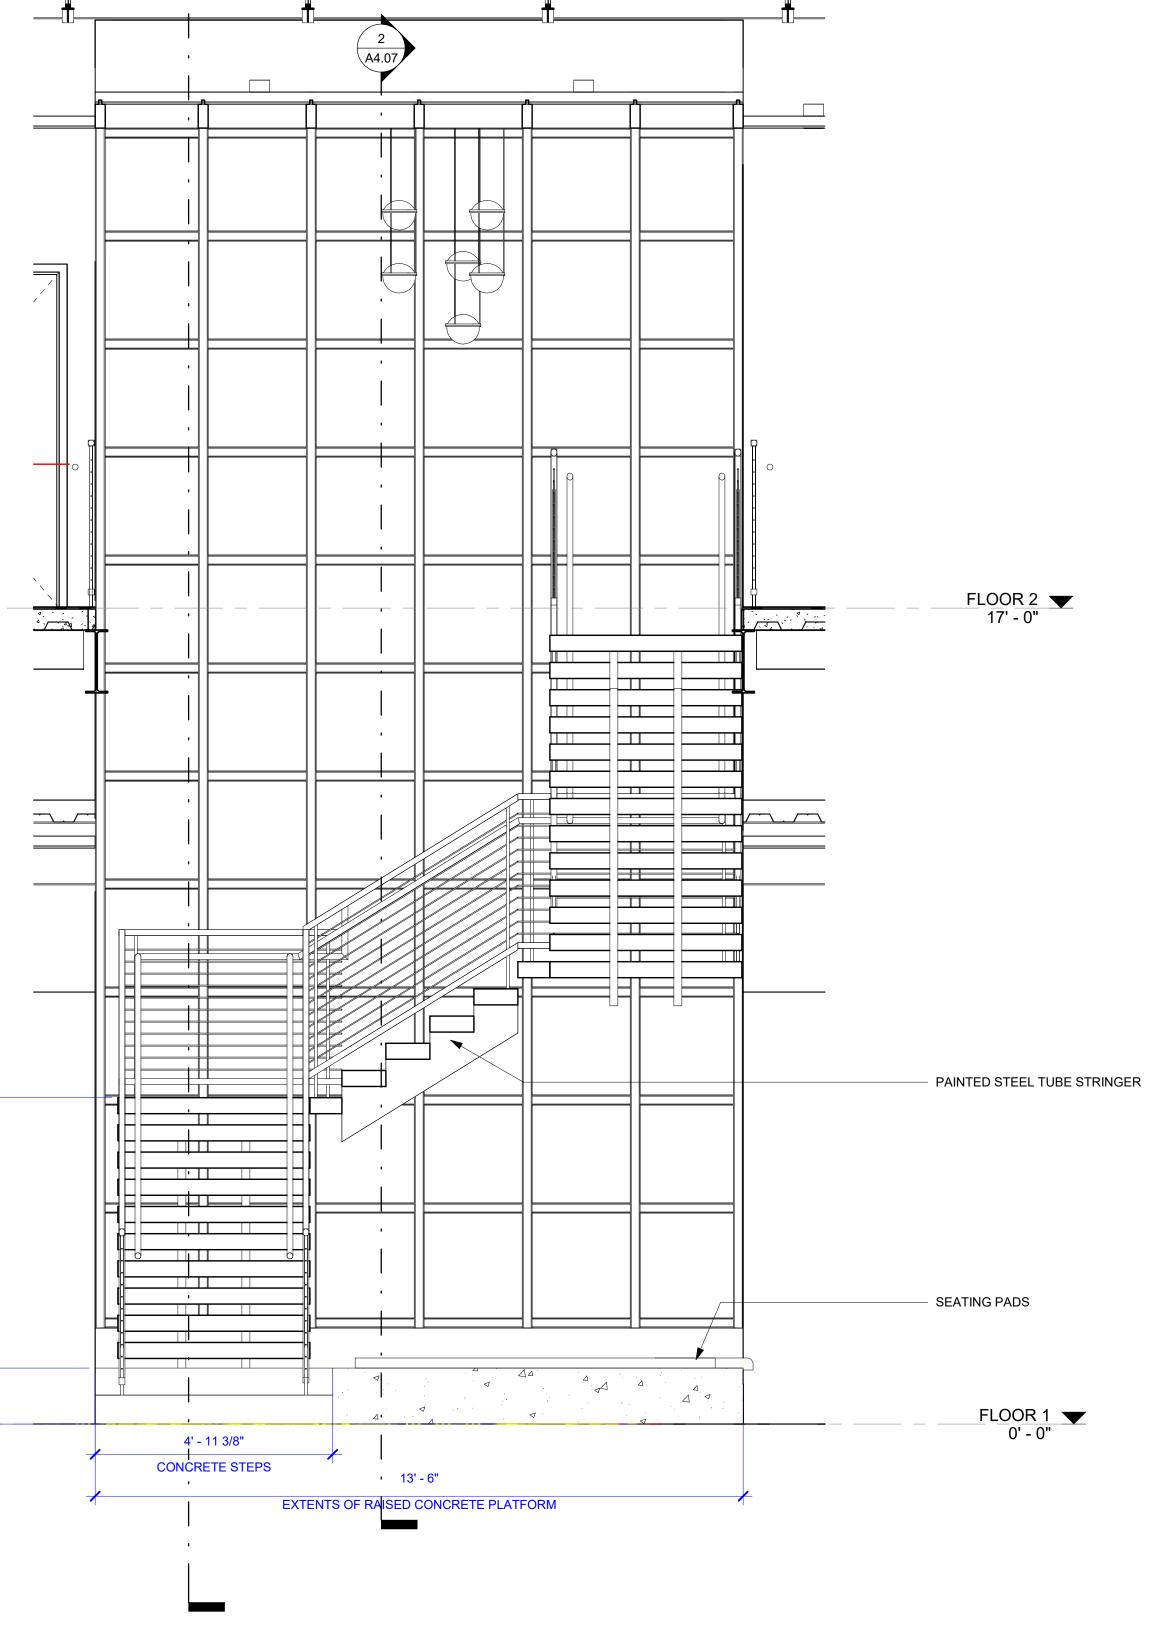
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 $\left(\begin{array}{c} 2\\ \overline{A4.04} \end{array}\right)$ 

HIGH ROOF EAVE 30' - 7 1/2"

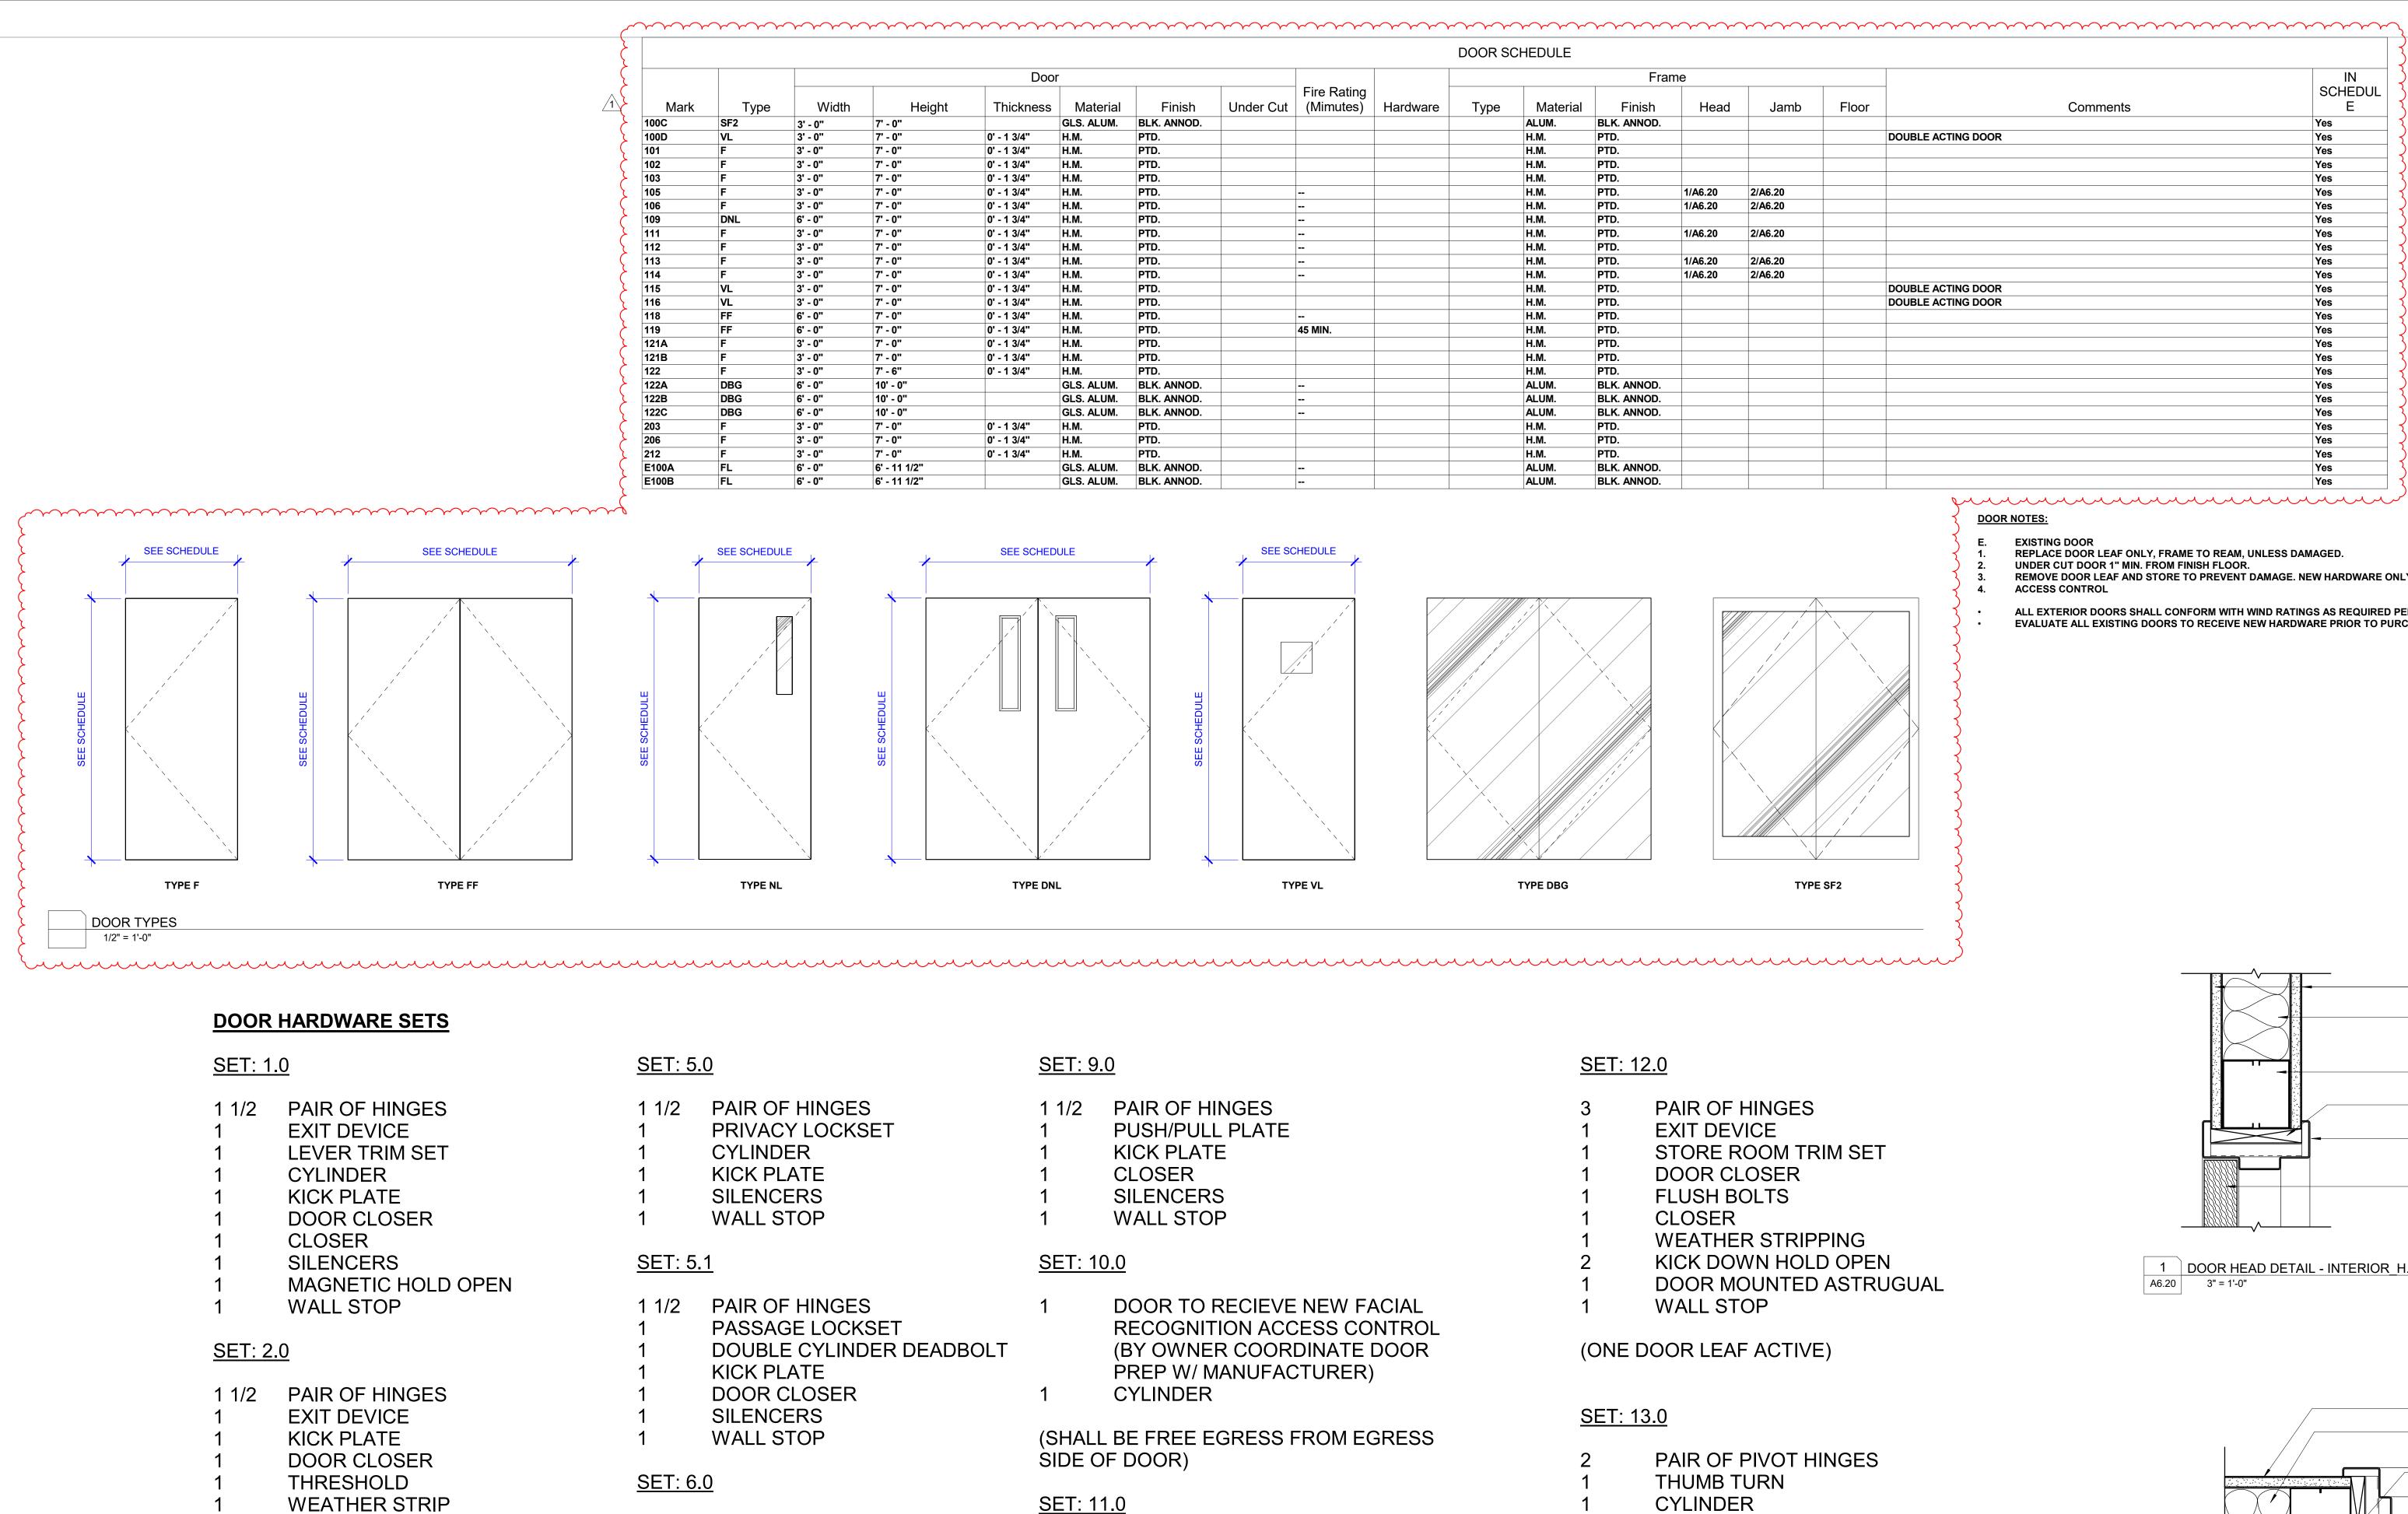


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 descripton
 date

 ision 1
 10/23/23

 ision 2
 10/30/23
 VERTICAL CIRCULATION -MONUMENTAL STAIR DRAWN BY | Author A4.04



| <u>SET: 5</u>                   | <u>.0</u>  | <u>SET: 9</u>                  | <u>).0</u>   | <u>SET:</u>                | 12.0   |
|---------------------------------|--|--------------------------------|--|----------------------------|--|
| 1 1/2<br>1<br>1<br>1<br>1<br>1  | PAIR OF HINGES<br>PRIVACY LOCKSET<br>CYLINDER<br>KICK PLATE<br>SILENCERS<br>WALL STOP  | 1 1/2<br>1<br>1<br>1<br>1<br>1 | PAIR OF HINGES<br>PUSH/PULL PLATE<br>KICK PLATE<br>CLOSER<br>SILENCERS<br>WALL STOP                            | 3<br>1<br>1<br>1<br>1<br>1 | PAIR OF HING<br>EXIT DEVICE<br>STORE ROOM<br>DOOR CLOSE<br>FLUSH BOLTS<br>CLOSER<br>WEATHER ST |
| <u>SET: 5</u>                   | <u>.1</u>  | <u>SET: 1</u>                  | 0.0  | 2                          | KICK DOWN H  |
| 1 1/2<br>1<br>1<br>1            | PAIR OF HINGES<br>PASSAGE LOCKSET<br>DOUBLE CYLINDER DEADBOLT<br>KICK PLATE            | 1                              | DOOR TO RECIEVE NEW FACIAL<br>RECOGNITION ACCESS CONTROL<br>(BY OWNER COORDINATE DOOR<br>PREP W/ MANUFACTURER) | 1<br>1<br>(ONE             | DOOR MOUNT<br>WALL STOP  |
| 1                               | DOOR CLOSER<br>SILENCERS   | 1                              | CYLINDER   | SET:                       | 13.0   |
| 1                               | WALL STOP  | <b>`</b>                       | L BE FREE EGRESS FROM EGRESS   | 2                          |  |
| <u>SET: 6</u>                   |  | SIDE (<br><u>SET: 1</u>        | DF DOOR)<br><u>1.0</u>   | 1<br>1                     | PAIR OF PIVO<br>THUMB TURN<br>CYLINDER   |
| 1 1/2<br>1<br>1<br>1<br>1<br>1. | PAIR OF HINGES<br>STOREROOM LOCKSET<br>CLOSER<br>ARMOR PLATE<br>SILENCERS<br>WALL STOP | 3<br>1<br>1<br>1               | PAIR OF HINGES<br>ACCESS CONTROL FACIAL<br>RECOGNITION (BY OWNER)<br>EXIT DEVICE<br>LEVER TRIM SET             | (VEF                       | RIFY HARDWARE  |
| <u>SET: 7</u>                   | <u>.0</u>  | 1<br>1<br>1                    | KICK PLATE (PUSH SIDE ONLY)<br>DOOR CLOSER<br>FLUSH BOLTS  |                            |  |
| 1 1/2<br>1<br>1<br>1<br>1       | PAIR OF HINGES<br>PASSAGE LOCKSET<br>CLOSER<br>ARMOR PLATE<br>SILENCERS                | 1<br>1<br>2<br>1<br>1          | CLOSER<br>WEATHER STRIPPING<br>KICK DOWN HOLD OPEN<br>DOOR MOUNTED ASTRUGUAL<br>WALL STOP                      |                            |  |
| 1                               | KICK DOWN DOOR STOP<br>FLOOR STOP  | •                              | L BE FREE EGRESS FROM EGRESS   |                            |  |
| <u>SET: 8</u>                   | <u>.0</u>  | SIDE (                         | OF DOOR AND ONE DOOR LEAF ACTIVE)  |                            |  |
| 1 1/2<br>1                      | PAIR OF HINGES<br>PASSAGE LOCKSET  |                                |  |                            |  |

## SPRING PIVOT HINGES PUSH PLATES 2 ARMOUR PLATES (IF DOOR HAS 2 FINISH THAT CAN GET SCRATCHED OR DENTED.) FLOOR STOPS 2 (VERIFY HARDWARE W/ DOOR MANUF.)

DOOR DRIP HEAD

DOOR DRIP SILL

(EXIT ONLY NO RE-ENTRY)

# <u>SET: 4.0</u>

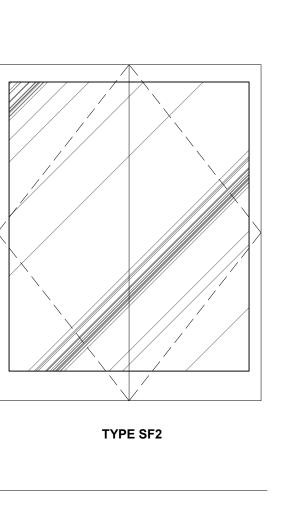
<u>SET: 3.0</u>

| 1 1/2 | PAIR OF HINGES |
|-------|----------------|
| 1     | OFFICE LOCKSET |
| 1     | CYLINDER       |
| 1     | SILENCERS      |
| 1     | WALL STOP      |
|       |                |

| <u>SET: 5</u>               | <u>.0</u>   | <u>SET: 9</u>             | <u>.0</u>   | <u>SET:</u>                | 12.0   |
|-----------------------------|---|---------------------------|---|----------------------------|--|
| 1 1/2<br>1<br>1<br>1<br>1   | PAIR OF HINGES<br>PRIVACY LOCKSET<br>CYLINDER<br>KICK PLATE<br>SILENCERS<br>WALL STOP | 1 1/2<br>1<br>1<br>1<br>1 | PAIR OF HINGES<br>PUSH/PULL PLATE<br>KICK PLATE<br>CLOSER<br>SILENCERS<br>WALL STOP   | 3<br>1<br>1<br>1<br>1<br>1 | PAIR OF H<br>EXIT DEVIO<br>STORE RC<br>DOOR CLC<br>FLUSH BO<br>CLOSER<br>WEATHER |
| <u>SET: 5</u>               | <u>.1</u>   | <u>SET: 1</u>             | 0.0   | 2                          | KICK DOW   |
| 1 1/2<br>1                  | PAIR OF HINGES<br>PASSAGE LOCKSET   | 1                         | DOOR TO RECIEVE NEW FACIAL<br>RECOGNITION ACCESS CONTROL  | 1                          | DOOR MOU<br>WALL STO   |
| 1<br>1<br>1                 | DOUBLE CYLINDER DEADBOLT<br>KICK PLATE<br>DOOR CLOSER                                 | 1                         | (BY OWNER COORDINATE DOOR<br>PREP W/ MANUFACTURER)<br>CYLINDER  | (ONE                       | DOOR LEAF  |
| 1                           | SILENCERS   | -                         |   | <u>SET:</u>                | 13.0   |
|                             | WALL STOP   | <b>`</b>                  | L BE FREE EGRESS FROM EGRESS<br>DF DOOR)  | 2                          |  |
| <u>SET: 6</u><br>1 1/2      | <u>.0</u><br>PAIR OF HINGES   | <u>SET: 1</u>             | <u>1.0</u>  | 1<br>1<br>(V/EF            | THUMB TU<br>CYLINDER<br>RIFY HARDWA  |
| 1<br>1<br>1<br>1<br>1<br>1. | STOREROOM LOCKSET<br>CLOSER<br>ARMOR PLATE<br>SILENCERS<br>WALL STOP                  | 3<br>1<br>1<br>1<br>1     | PAIR OF HINGES<br>ACCESS CONTROL FACIAL<br>RECOGNITION (BY OWNER)<br>EXIT DEVICE<br>LEVER TRIM SET<br>KICK PLATE (PUSH SIDE ONLY) | ( • – 1                    |  |
| <u>SET: 7</u>               | <u>.0</u>   | 1<br>1                    | DOOR CLOSER<br>FLUSH BOLTS  |                            |  |
| 1 1/2<br>1<br>1<br>1<br>1   | PAIR OF HINGES<br>PASSAGE LOCKSET<br>CLOSER<br>ARMOR PLATE<br>SILENCERS               | 1<br>1<br>2<br>1<br>1     | CLOSER<br>WEATHER STRIPPING<br>KICK DOWN HOLD OPEN<br>DOOR MOUNTED ASTRUGUAL<br>WALL STOP   |                            |  |
| 1<br>1                      | KICK DOWN DOOR STOP<br>FLOOR STOP   | <b>`</b>                  | L BE FREE EGRESS FROM EGRESS<br>OF DOOR AND ONE DOOR LEAF ACTIVE)   |                            |  |
| <u>SET: 8</u>               | <u>.0</u>   |                           | ,<br>,  |                            |  |
| 1 1/2<br>1                  | PAIR OF HINGES<br>PASSAGE LOCKSET   |                           |   |                            |  |

| 1/2 PAIR OF HI |     |
|----------------|-----|
| PASSAGE L      | .OC |
| CLOSER         |     |
| KICK PLATE     | -   |
| SILENCERS      | •   |
| KICK DOWN      | 1 D |
| FLOOR STO      | P   |

| • •   |              |              | · · · · ·   | ••••        | ••••      | · · · ·               | • • • • • |       | CHEDULE  |             |         | · · ·   |
|-------|--------------|--------------|-------------|-------------|-----------|-----------------------|-----------|-------|----------|-------------|---------|---------|
|       |              | Doo          | or          |             |           |                       |           |       |          | Fran        |         |         |
| Nidth | Height       | Thickness    |             | Finish      | Under Cut | Fire Rating (Mimutes) | Hardware  | Туре  | Material | Finish      | Head    |         |
|       | 7' - 0"      |              | GLS. ALUM.  | BLK. ANNOD. |           | (initiated)           | Thanamaro | 1,900 | ALUM.    | BLK. ANNOD. |         | <b></b> |
| •     | 7' - 0"      | 0' - 1 3/4'' | H.M.        | PTD.        |           |                       |           |       | H.M.     | PTD.        |         |         |
| •     | 7' - 0"      | 0' - 1 3/4"  | H.M.        | PTD.        |           |                       |           |       | H.M.     | PTD.        |         |         |
| •     | 7' - 0"      | 0' - 1 3/4"  | H.M.        | PTD.        |           |                       |           |       | H.M.     | PTD.        |         |         |
| •     | 7' - 0"      | 0' - 1 3/4"  | H.M.        | PTD.        |           |                       |           |       | H.M.     | PTD.        |         |         |
| •     | 7' - 0"      | 0' - 1 3/4"  | H.M.        | PTD.        |           |                       |           |       | H.M.     | PTD.        | 1/A6.20 | 2/A6.   |
| •     | 7' - 0"      | 0' - 1 3/4"  | H.M.        | PTD.        |           |                       |           |       | H.M.     | PTD.        | 1/A6.20 | 2/A6    |
| •     | 7' - 0"      | 0' - 1 3/4"  | H.M.        | PTD.        |           |                       |           |       | H.M.     | PTD.        |         |         |
| •     | 7' - 0"      | 0' - 1 3/4"  | H.M.        | PTD.        |           |                       |           |       | H.M.     | PTD.        | 1/A6.20 | 2/A6.   |
| •     | 7' - 0"      | 0' - 1 3/4"  | H.M.        | PTD.        |           |                       |           |       | H.M.     | PTD.        |         |         |
| •     | 7' - 0"      | 0' - 1 3/4"  | H.M.        | PTD.        |           |                       |           |       | H.M.     | PTD.        | 1/A6.20 | 2/A6.   |
| •     | 7' - 0"      | 0' - 1 3/4"  | H.M.        | PTD.        |           |                       |           |       | H.M.     | PTD.        | 1/A6.20 | 2/A6    |
| •     | 7' - 0"      | 0' - 1 3/4"  | H.M.        | PTD.        |           |                       |           |       | H.M.     | PTD.        |         |         |
| •     | 7' - 0"      | 0' - 1 3/4"  | H.M.        | PTD.        |           |                       |           |       | H.M.     | PTD.        |         |         |
| •     | 7' - 0"      | 0' - 1 3/4"  | H.M.        | PTD.        |           |                       |           |       | H.M.     | PTD.        |         |         |
| •     | 7' - 0"      | 0' - 1 3/4"  | H.M.        | PTD.        |           | 45 MIN.               |           |       | H.M.     | PTD.        |         |         |
| •     | 7' - 0"      | 0' - 1 3/4"  | H.M.        | PTD.        |           | -5 101114.            |           |       | H.M.     | PTD.        |         |         |
| •     | 7' - 0"      | 0' - 1 3/4"  | H.M.        | PTD.        |           |                       |           |       | H.M.     | PTD.        |         |         |
| •     | 7' - 6"      | 0' - 1 3/4"  | H.M.        | PTD.        |           |                       |           |       | H.M.     | PTD.        |         |         |
| •     | 10' - 0"     |              | GLS. ALUM.  | BLK. ANNOD. |           |                       |           |       | ALUM.    | BLK. ANNOD. |         |         |
| •     | 10' - 0"     |              | GLS. ALUM.  | BLK. ANNOD. |           |                       |           |       | ALUM.    | BLK. ANNOD. |         |         |
| •     | 10' - 0"     |              | GLS. ALUM.  | BLK. ANNOD. |           |                       |           |       | ALUM.    | BLK. ANNOD. |         |         |
| •     | 7' - 0"      | 0' - 1 3/4"  | H.M.        | PTD.        |           |                       |           |       | H.M.     | PTD.        |         |         |
| •     | 7' - 0"      | 0' - 1 3/4"  | H.M.        | PTD.        |           |                       |           |       | H.M.     | PTD.        |         |         |
| •     | 7' - 0"      | 0' - 1 3/4"  | H.M.        | PTD.        |           |                       |           |       | H.M.     | PTD.        |         |         |
| •     | 6' - 11 1/2" |              | GLS. ALUM.  | BLK. ANNOD. |           |                       |           |       | ALUM.    | BLK. ANNOD. |         |         |
| •     | 6' - 11 1/2" |              | GLS. ALUM.  | BLK. ANNOD. |           |                       |           |       | ALUM.    | BLK. ANNOD. |         |         |
|       | V - 11 1/2   |              | JLS. ALUNI. |             |           |                       |           |       |          |             |         |         |



DOOR STOP

|      |       | _                  | IN<br>SCHEDUL |
|------|-------|--------------------|---------------|
| Jamb | Floor | Comments           | E             |
|      |       |                    | Yes           |
|      |       | DOUBLE ACTING DOOR | Yes           |
|      |       |                    | Yes           |
|      |       |                    | Yes           |
|      |       |                    | Yes           |
| .20  |       |                    | Yes           |
| 20   |       |                    | Yes           |
|      |       |                    | Yes           |
| 20   |       |                    | Yes           |
|      |       |                    | Yes           |
| 20   |       |                    | Yes           |
| .20  |       |                    | Yes           |
|      |       | DOUBLE ACTING DOOR | Yes           |
|      |       | DOUBLE ACTING DOOR | Yes           |
|      |       |                    | Yes           |

## DOOR NOTES:

EXISTING DOOR Ε. REPLACE DOOR LEAF ONLY, FRAME TO REAM, UNLESS DAMAGED. UNDER CUT DOOR 1" MIN. FROM FINISH FLOOR.

REMOVE DOOR LEAF AND STORE TO PREVENT DAMAGE. NEW HARDWARE ONLY. ACCESS CONTROL

ALL EXTERIOR DOORS SHALL CONFORM WITH WIND RATINGS AS REQUIRED PER CODE. EVALUATE ALL EXISTING DOORS TO RECEIVE NEW HARDWARE PRIOR TO PURCHASING.

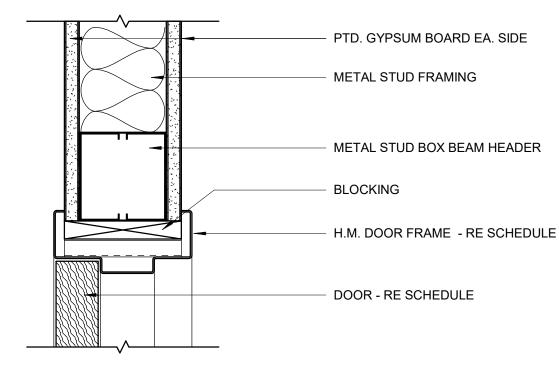
HINGES /ICE ROOM TRIM SET LOSER BOLTS

ER STRIPPING WN HOLD OPEN OUNTED ASTRUGUAL

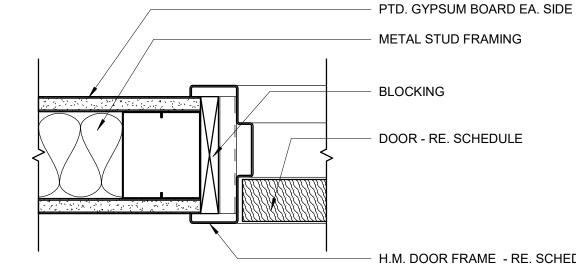
AF ACTIVE)

PIVOT HINGES TURN

WARE W/ GLASS SUPPLIER)

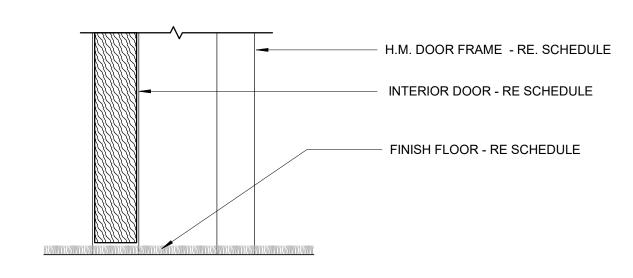


1 DOOR HEAD DETAIL - INTERIOR\_H.M. FRAME\_GYP. BD. A6.20 3" = 1'-0"



H.M. DOOR FRAME - RE. SCHEDULE

2 DOOR JAMB DETAIL - INTERIOR\_H.M. FRAME\_GYP. BD. A6.20 3" = 1'-0"







NEW ORLEANS, LA 70125 WOODWARDDESIGNBUILD.COM | 504-822-6443 Erik Wismar, AIA

N.O. SAINTS CAFETERIA & VIEWING EXPANSION 5800 Airline Drive Metairie, Louisiana WDG PROJECT NO | 6022-498 CONSTRUCTION DOCUMENTS 10/09/2023 REVISIONS no.descriptondate1Revision 210/30/23 DOOR SCHEDULE DRAWN BY | WDG A6.20

|  |   |                                      | ROOM FINISH LEGEND  |  |
|--|---|--------------------------------------|---|--|
| KEY NAME                               | DESCRIPTION                                     | MANUFACTURER                         | MODEL, NAME & COLOR   | SIZE & SPEC & NOTES  |
| ~~~~~~~~~~~~~~~~~~~~~~~~~~~~~~~~~~~~~~ |   |                                      | $\sim \sim $ |  |
| CL-01                                  | SHIP LAP CEILING                                | SHERWIN WILLIAMS                     | MODEL TBD. NAME TBD. PAINT WHITE  |  |
| CL-02                                  | GYP BD CEILING                                  | N/A N/A                              | NA  |  |
| CL-03                                  | CEILING TILE                                    | AMERICAN TIN                         | PATTERN #15, RUSTIC COPPER TRANSLUCENT, COLOR BRASS   | 24X24; DROP IN CEILING TILES   |
| CO-01                                  | SEALED CONCRETE, SEALED CONCRETE PLINTH CEILING | N/A                                  | N/A   |  |
| CT-01                                  | CARPET TILE                                     | BENTLEY                              | "BRINK" 801674, COLOR VARIES  | 24X48  |
| FRP-01                                 | FIBERGLASS REINFORCED PANELS                    |                                      | TEXTURED, COLOR: WHITE  |  |
| GL-01                                  | VIEWING GLASS WITH ELECTROLYTIC FILM            | GLASS: TBD, FILM: OPAQUE SMART GLASS | TBD, WHITE, WHITE FILM  | FILM APPLIED TO INTERIOR SIDE OF GLASS                                   |
| M1-01                                  | MIRROR  | MCGRORY GLASS                        | N/A, BRONZE MIRROR, BRONZE TINT   | SAINTS LOGO APPLIED VIA FILM ON TOP OF MIRROR                            |
| PL-01                                  | PLASTIC LAMINATE                                | WILSONART                            | BLACK 1595-60 MATTE FINISH  |  |
| PL-02                                  | DECORATIVE METAL LAMINATE                       | WILSONART                            | SATIN BRUSHED GOLD ALUMINUM 6258-00-419   |  |
| PT-01                                  | PAINT   | SHERWAN WILLIAMS                     | GREEK VANILLA, WHITE  |  |
| PT-02                                  | PAINT   | SHERWAN WILLIAMS                     | IRON ORE, DARK GRAY   |  |
| PT-03                                  | PAINI PAINI                                     | SCUEFMASTER                          | SM8012 BRASS  | ARPLIED BEHIND CEILING COEFERS AND BOOKSHELF LEVEL 2                     |
| SC-01                                  |   | CAMBRIA                              | QUARTZ COUNTERTOP, WEYBOURNE, WHITE   |  |
| SC-01<br>TL-00                         | FLOOR TILE                                      | ATLAS CONCORDE                       | BOOST, PEARL MATTE  | 12"x24" ANTI-SLIP FINISH, 1/16" JOINT WIDTH, GROUT: MAPEI 11 SAHARA BEIG |
| TL-01                                  | FLOOR TILE                                      | ATLAS CONCORDE                       | PALE OAK NATURAL, OAK   | 18.5MM X 150MM, WOOD LOOK FLOOR TILING                                   |
| TL-02                                  | FLOOR TILE                                      | TILE BAR                             | CHIPS / MACRO, WHITE, WHITE   | 9" X 9" LIGHT TERAZZO FLOOR TILE   |
| TL-03                                  | FLOOR TILE                                      | TILE BAR                             | CHIPS / MACRO, NERO, NERO   | 9" X 9" DARK TERAZZO FLOOR TILE  |
| TL-04                                  | WALL TILE                                       | DALTILE                              | REMEDY, WHITE, WHITE  | WHITE ACCENT TILE  |
| TL-05                                  | WALL TILE                                       | DALTILE                              | STARE / ELECTRIC VOLT, GOLD, GOLD   | GOLD PATTERNED ACCENT TILE   |
| TL-06                                  | WALL TILE                                       | CAESAR CERAMICS USA                  | NATURE: STAVE, MAPLE, MAPLE   | WOOD LOOK ACCENT TILE  |
| TL-07                                  | WALL TILE                                       | ARIZONA TILE                         | CONCERTO BLACK MATTE & GLOSS, BLACK   | 2.25" X 9.75" 20% GLOSS, 80% MATTE                                       |
| TL-08                                  | WALL TILE                                       | PLATFORM SURFACES                    | VALLA, NAVY, NAVY   | 2" X 10"   |
| TL-09                                  | WALL TILE                                       | NEMO TILE                            | GOUACHE, NUAGE /MER, GREEN AND WHITE  | 20% WHITE 6"X6", 40% WHITE 3"X6", 40% GREEN 3"X6"                        |
| TL-11                                  | WALL TILE                                       | DALTILE                              | MIRAMO MR48, HORIZON, BLUE  | 1"X6"  |
| JL-12                                  | WALLTILE  | DALTILE                              | STAGECRAFT K111, BLACK  | 6"X6"  |
| TL-13                                  | WALL TILE                                       | TILE BAR                             | AUTEUR DIAGONAL, LIGHT GRAY   | 9" X 9"  |
| TL-14                                  | WALL TILE                                       | KEOPE                                | UBIK, UBIK WALNUT NATURAL FINISH  | 24" X 24", JOINT WIDTH: 1/16", GROUT: MAPEI 11 SAHARA BEIGE              |
| WC-01                                  | WALL COVERING                                   | INNOVATIONS USA                      | CUBISM CUB - 100, METZINGER, BLACK AND GRAY   | VERTICAL SHIP LAP PAINTED BLACKT TO 2'-10" BELOW WALL COVERING           |
| WD-02                                  | WOOD CEILING COFFERS                            | N/A                                  | N/A, PAINT BLACK  | EGG CRATE COFFERS  |
| WF-01                                  | WOOD FLOOR                                      | KNOWN COLLECTION                     | KRE REINER EURO, EUROPEAN WHITE OAK, WHITE OAK, TREATED WITH UB URETHANE WITH ALUMINUM OXIDE      | 9/16" H X 5.5w X 86-5/8"L  |
| WP-01                                  | SOFFIT PANEL                                    | SURFACING SOLUTION                   | PROFILE 455, WHITE OAK  |  |

| ROOM   |                  | CEILING    |          |                            | BASE      |              | WALL FINIS        | βH            |              |                   |
|--------|------------------|------------|----------|----------------------------|-----------|--------------|-------------------|---------------|--------------|-------------------|
| NUMBER | Name             | FINISH     | HEIGHT   | FLOOR FINISH               | FINISH    | NORTH        | SOUTH             | EAST          | WEST         | COMMENTS          |
| $\sim$ |                  | $\sim$     |          |                            |           | $\sim$       | $\overline{}$     | $\overline{}$ | $\sim$       |                   |
| 100    | DINING HALL      | CL-01      | 13' - 6" | TL-02                      | TL-04     | TL-04        | TL-04             | TL-04         | TL-04        | TERRAZZO TILE     |
| 101    | WOMEN'S          | CL-02      | 9' - 0"  | TL-00                      | TL-00     | TL-07, TL-14 | TL-07, TL-14      | TL-07, TL-14  | TL-07, TL-14 |                   |
| 102    | MEN'S            | CL-02      | 9' - 0"  | TL-00                      | TL-00     | TL-07, TL-14 | TL-07, TL-14      | TL-07, TL-14  | TL-07, TL-14 |                   |
| 103    | JAN.             | CL-02      | 9' - 0"  | CONCRETE                   | RB-1      | PT           | PT                | PT            | PT           |                   |
| 104    | FREEZER / COOLER | PER. MANF. |          | INSULATED FLOOR, PER MANF. | PER MANF. | PER MANF.    | PER MANF.         | PER MANF.     | PER MANF.    | WALK IN FREEZER   |
| 105    | DRY FOOD STORAGE | ACT-1      | 10' - 0" | QTL-1                      | QTL-2     | FRP-01       | FRP-01            | FRP-01        | FRP-01       |                   |
| 106    | NON-FOOD STORAGE | ACT-1      | 10' - 0" | QTL-1                      | QTL-2     | FRP-01       | FRP-01            | FRP-01        | FRP-01       |                   |
| 107    | CAN WASHING      | PT         | 10' - 0" | CONCRETE                   | (NONE)    | PT           | PT                | PT            | PT           |                   |
| 108    | ICE PRODUCTION   | ACT-1      | 12' - 0" | QTL-1                      | QTL-2     | PT           | PT                | PT            | PT           |                   |
| 109    | RECEIVING        | ACT-1      | 12' - 0" | QTL-1                      | QTL-2     | FRP-01       | FRP-01            | FRP-01        | FRP-01       |                   |
| 110    | LOCKERS          | GYP-2      | 10' - 0" | QTL-1                      | QTL-2     | PT           | PT                | PT            | PT           |                   |
| 111    | ADA RESTROOM     | GYP-2      | 9' - 0"  | TL-1                       | TL-2      | FRP-01       | FRP-01            | FRP-01        | FRP-01       |                   |
| 112    | OFFICE           | ACT-2      | 9' - 0"  | TL-1                       | TL-2      | PT           | PT                | PT            | PT           |                   |
| 113    | OFFICE           | ACT-2      | 9' - 0"  | TL-1                       | TL-2      | PT           | PT                | PT            | PT           |                   |
| 114    | UTENSIL STORAGE  | ACT-1      | 10' - 0" | QTL-1                      | QTL-2     | FRP-01       | FRP-01            | FRP-01        | FRP-01       |                   |
| 115    | DISHWASH         | ACT-1      | 10' - 0" | QTL-1                      | QTL-2     | FRP-01       | FRP-01            | FRP-01        | FRP-01       |                   |
| 116    | KITCHEN          | ACT-1      | 10' - 0" | QTL-1                      | QTL-2     | FRP-01       | FRP-01            | FRP-01        | FRP-01       |                   |
| 117    | CORRIDOR         | ACT-1      | 10' - 0" | QTL-1                      | QTL-2     | FRP-01       | FRP-01            | FRP-01        | FRP-01       |                   |
| 118    | STOR.            | ACT-1      | 10' - 0" | CONCRETE                   | RB-1      | PT           | PT                | PT            | PT           |                   |
| 119    | ELEC.            | ACT-1      | 10' - 0" | CONCRETE                   | RB-1      | PT           | PT                | PT            | PT           |                   |
| 120    | ELEV             | NO CEILING |          | TILE                       |           |              |                   |               |              | ELEVATOR CAR      |
| 121    | STAIR 1          | NO CEILING |          | VCT                        | RB-1      | PT           | PT                | PT            | PT           | INTERIOR STAIRWAY |
| 122    | VIEWING AREA     | CL-02      | 12' - 0" | TL-02                      | TILE      | PT           | PT/ WALL COVERING | PT            | TL-05/ PT    | TERRAZZO TILE     |
|        |                  |            |          |                            |           |              |                   |               |              |                   |

| ROOM FINISH SCHEDULE LEVEL 2 |                  |              |          |                   |        |       |         |      |         |                   |
|------------------------------|------------------|--------------|----------|-------------------|--------|-------|---------|------|---------|-------------------|
| ROOM                         |                  | CEILI        | NG       |                   | BASE   |       | WALL FI | NISH |         |                   |
| NUMBER                       | NAME             | FINISH       | HEIGHT   | FLOOR FINISH      | FINISH | NORTH | SOUTH   | EAST | WEST    | COMMENTS          |
|                              | ·                |              |          | ·                 |        |       |         |      |         |                   |
| 200                          | VIEWING AREA     | CL-02, WD-02 | 10' - 6" | CPT-1/CPT-2/CPT-3 | RB-1   | PT    | PT      | PT   | PT/WP-1 | 1, 5              |
| 201                          | ELEV. LOBBY      | CL-02        | 9' - 6"  | CT-01             |        | PT    | PT      | PT   | PT      |                   |
| 202                          | VIEWING PLATFORM |              |          |                   |        |       |         |      |         |                   |
| 203                          | MEP              | NONE         |          |                   |        |       |         |      |         | EXTERIOR PLATFORM |
| 206                          | CLOSET           |              | 9' - 0"  | VCT               | RB-1   | DT    | PT      | DT   | PT      |                   |

NOTES:
1. REFER TO RCP FOR ADDITIONAL CEILING HEIGHTS, FINISH NOTES, COLOR AND PATTERN LAYOUT ASSOCIATED WITH SP-1
2. STAIR RISER, TREAD, AND LANDING SHALL BE RUBBER FLOORING (RF-1).
3. REFER TO FINISH FLOOR PLAN TRZ-1 PATTERN AND COLOR LAYOUT.
4. REFER TO ENLARGED RESTROOM PLANS AND ELEVATIONS FOR WALL AND FLOOR FINISH LAYOUT.
5. REFER TO FINISH FLOOR PLAN FOR CARPET LAYOUT.
6. REFER TO FINISH LEGEND FOR GYP-1 ALT CEILING.
7. REFER TO FINISH LEGEND FOR ACT-1 ALT CEILING.



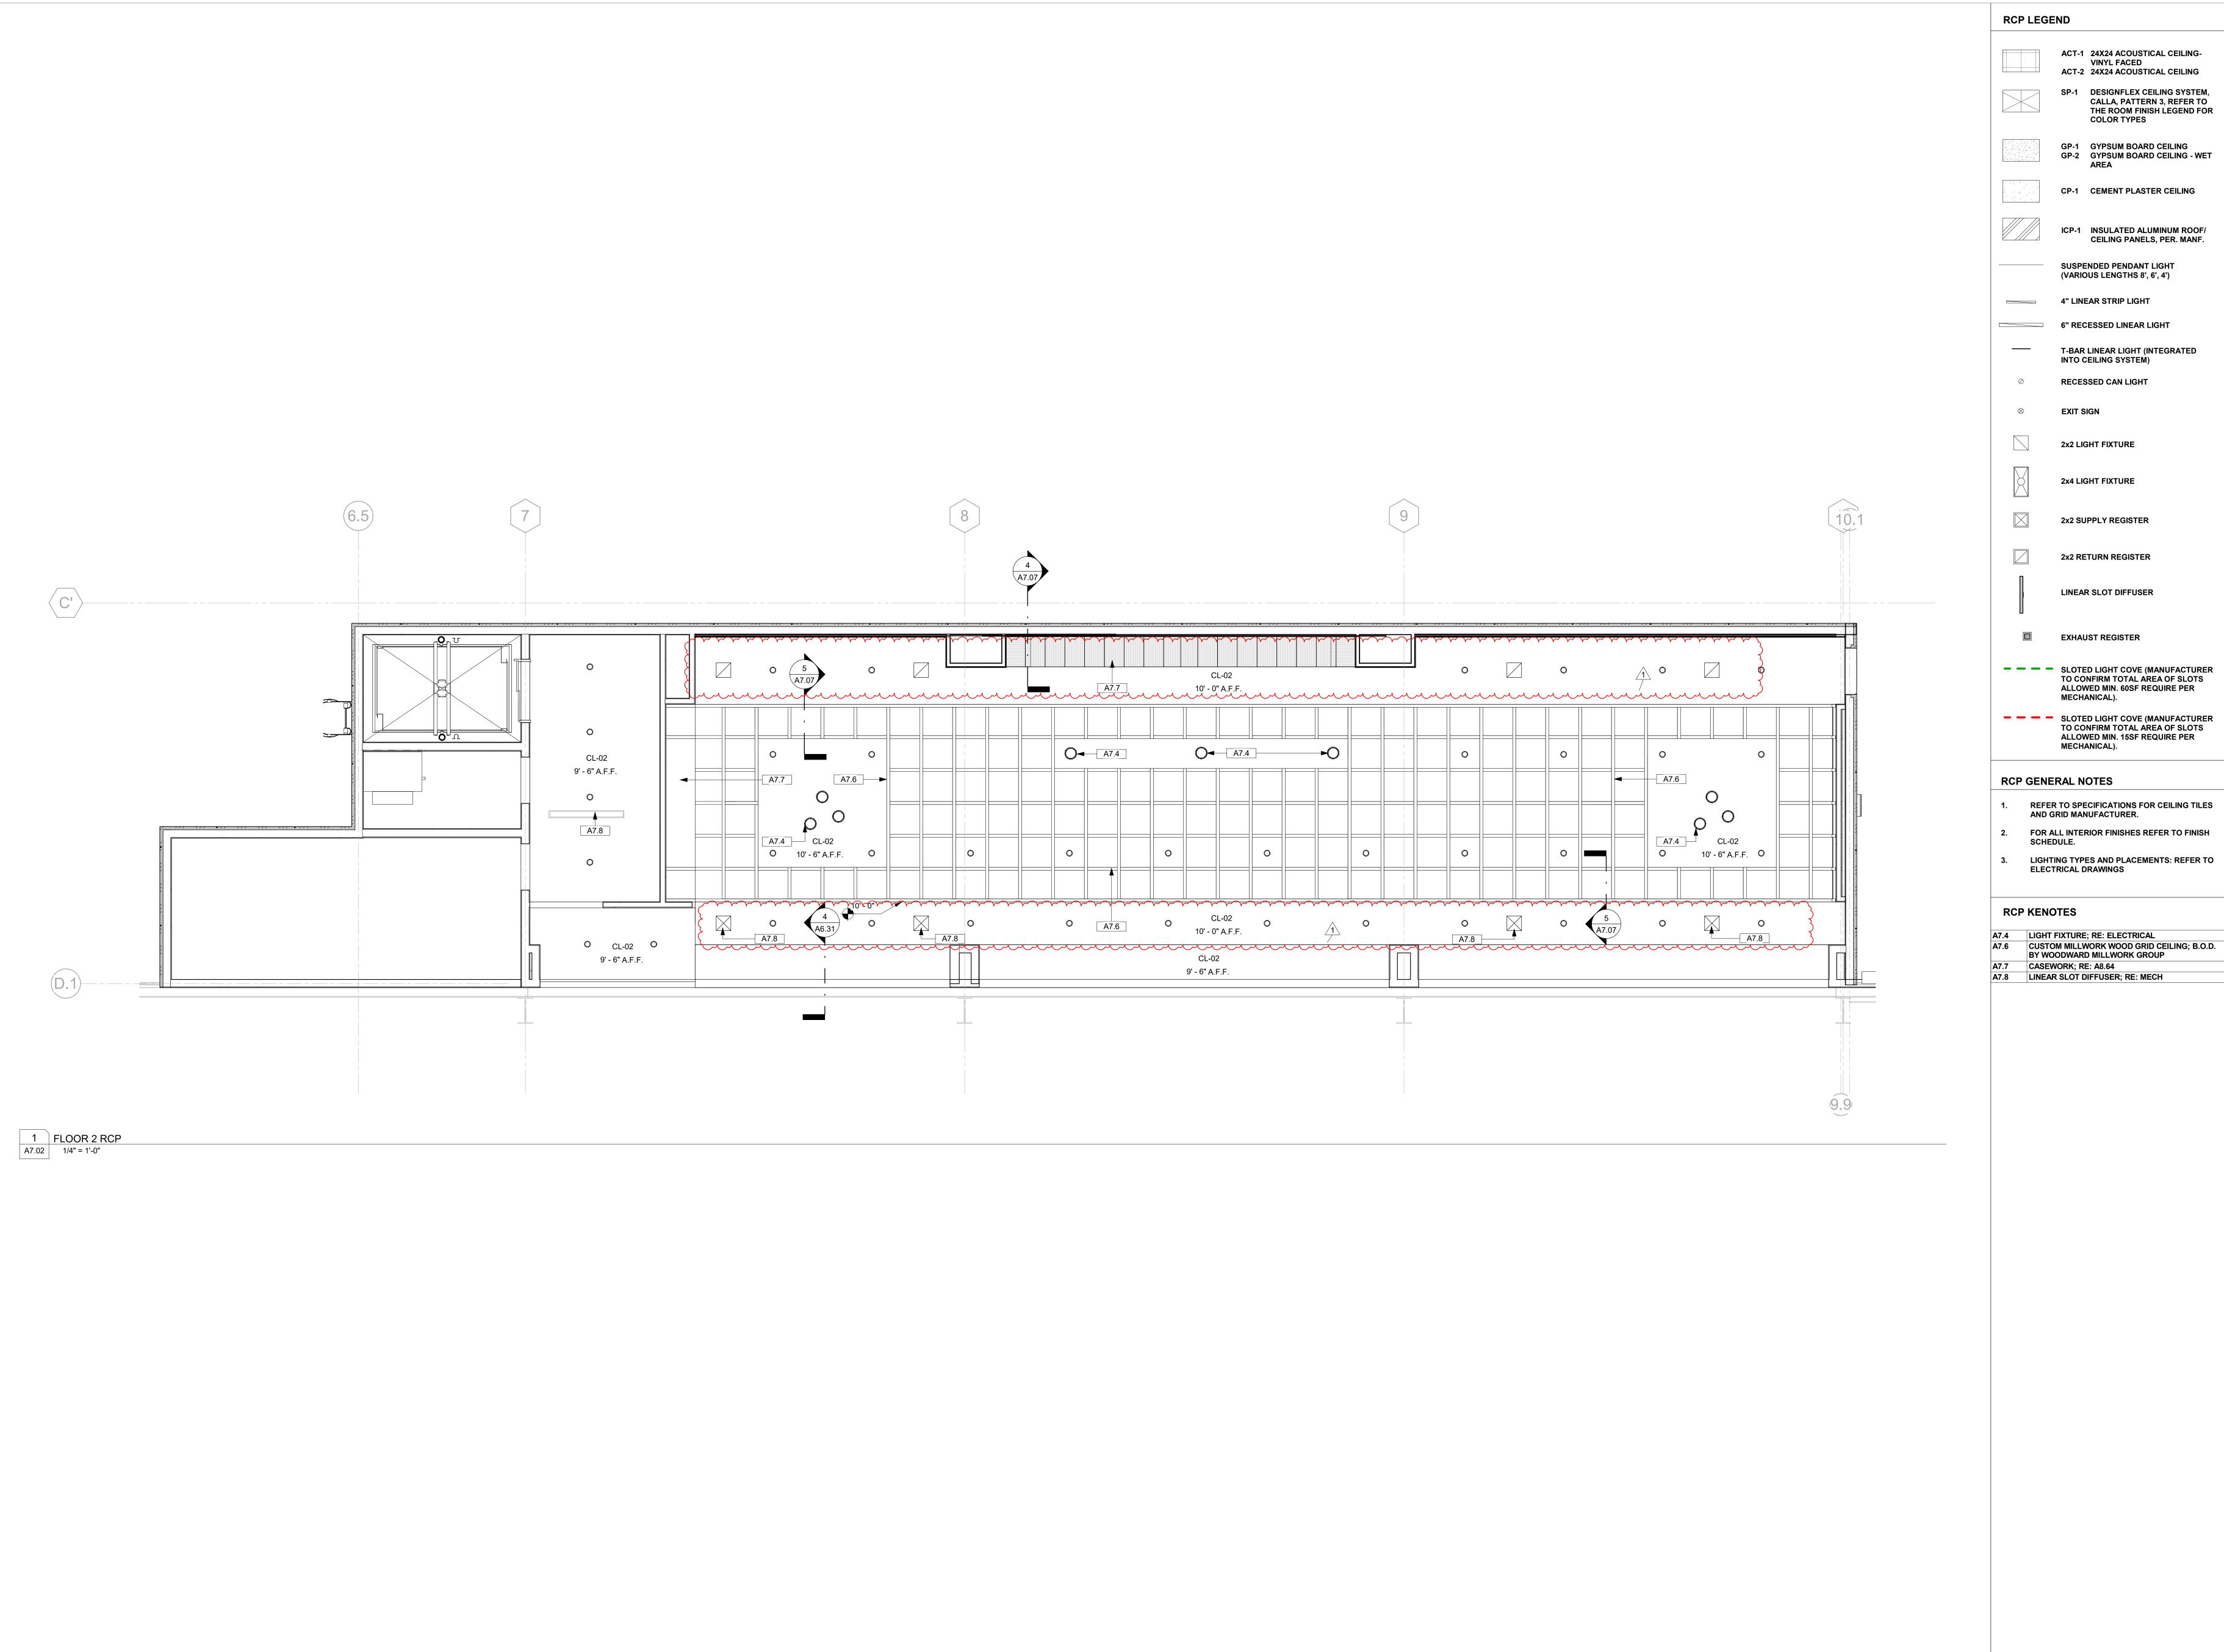
Erik Wismar, AIA

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 date

 on 1
 10/23/23

 on 2
 10/30/23
 \_\_\_\_\_ \_\_\_\_\_ \_\_\_\_\_ \_\_\_\_\_ \_\_\_\_\_ \_\_\_\_\_ **ROOM FINISH SCHEDULES** 

DRAWN BY I WDG A6.50



ACT-2 24X24 ACOUSTICAL CEILING

SP-1 DESIGNFLEX CEILING SYSTEM, CALLA, PATTERN 3, REFER TO THE ROOM FINISH LEGEND FOR

GP-2 GYPSUM BOARD CEILING - WET

ICP-1 INSULATED ALUMINUM ROOF/ CEILING PANELS, PER. MANF.

ALLOWED MIN. 60SF REQUIRE PER

ALLOWED MIN. 15SF REQUIRE PER



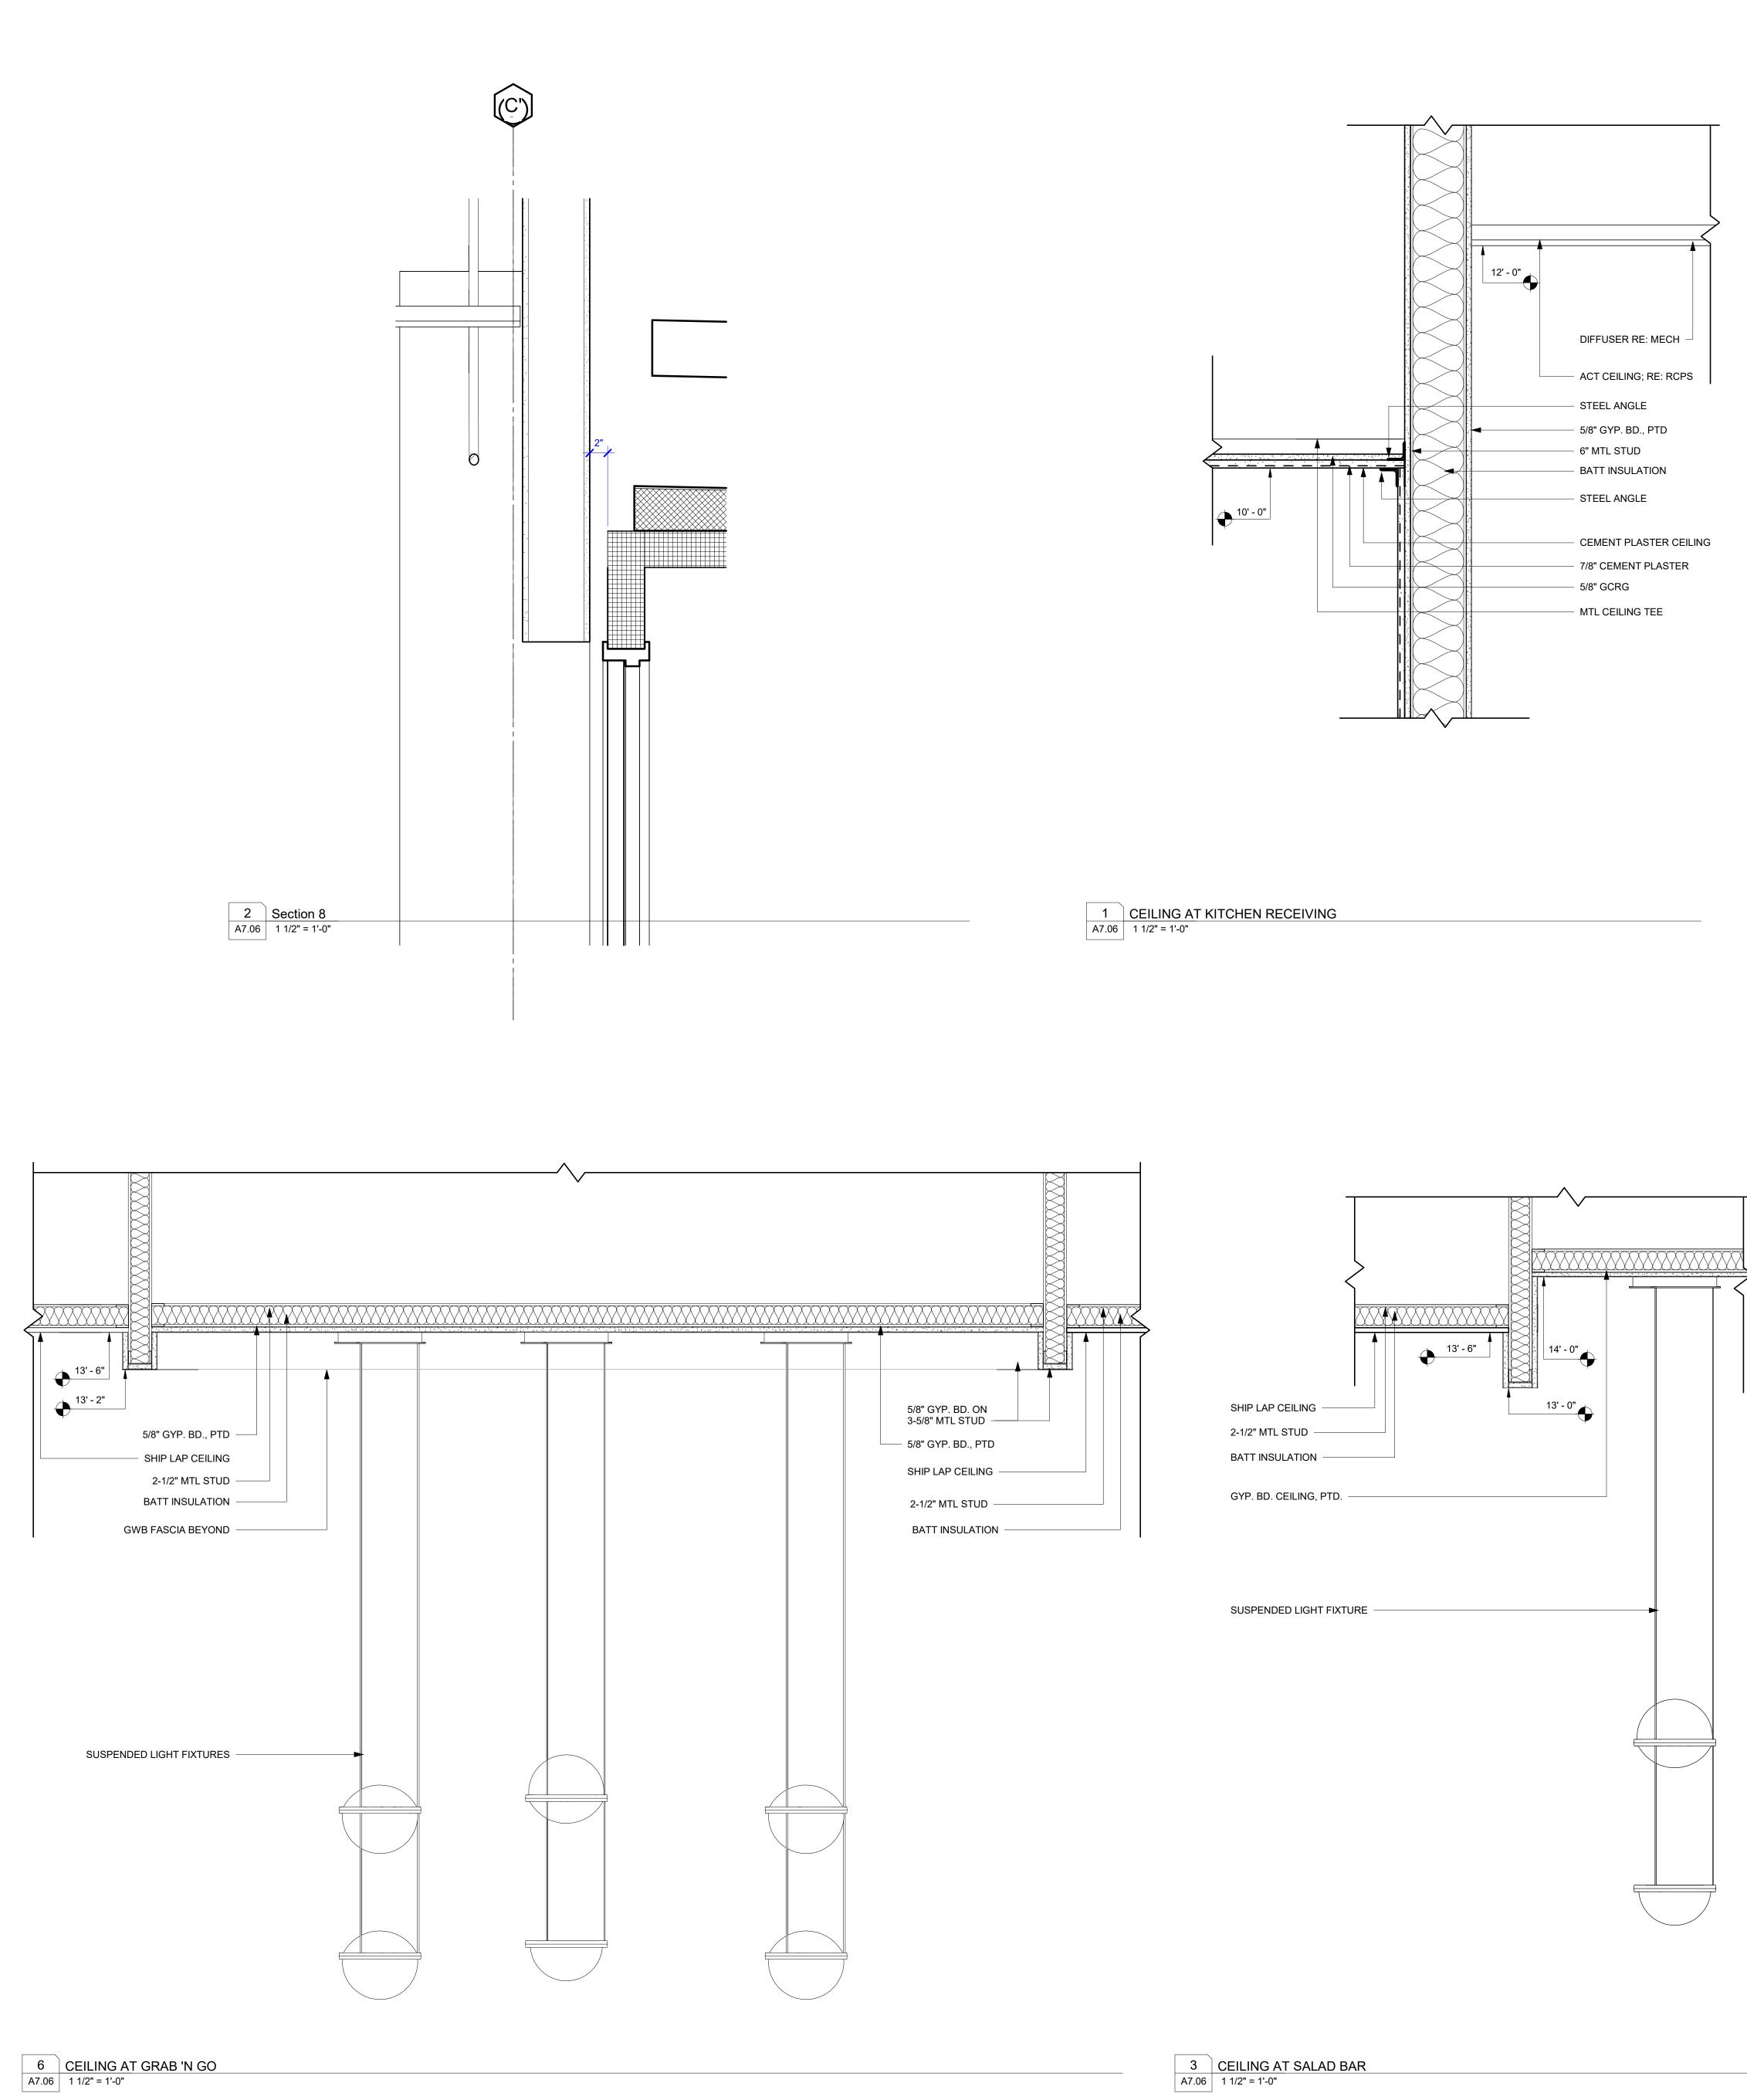
woodward design group 1000 S. NORMAN C. FRANCIS PARKWAY NEW ORLEANS, LA 70125 WOODWARDDESIGNBUILD.COM | 504-822-6443 Erik Wismar, AIA

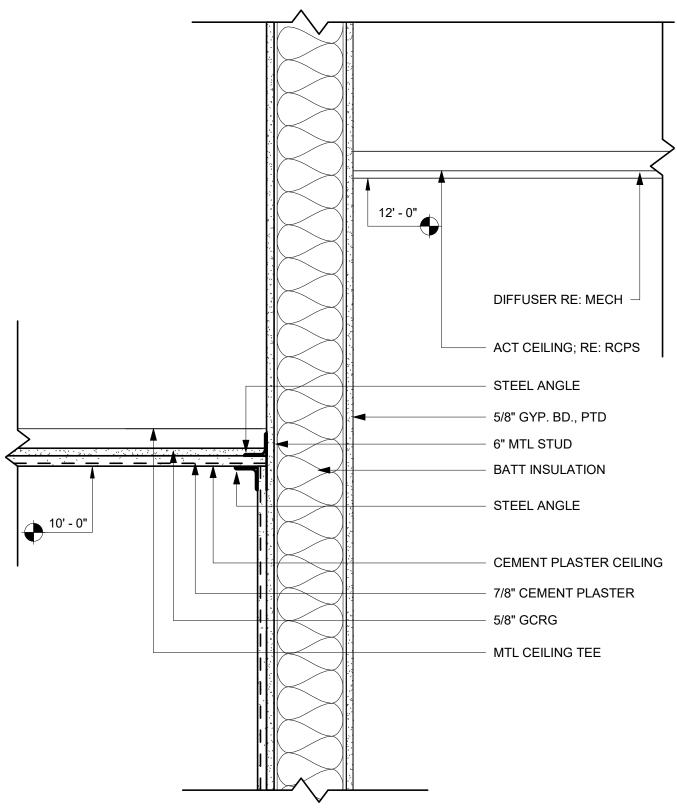
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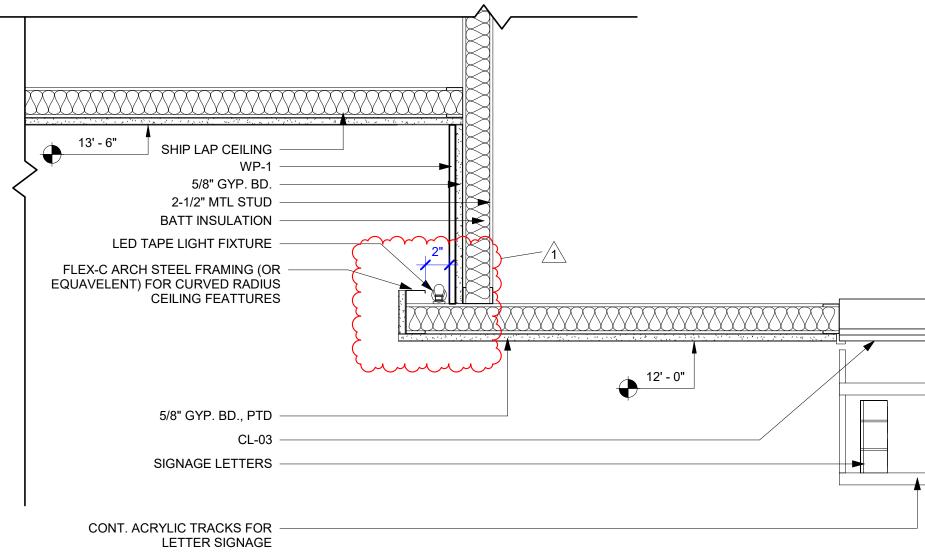
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REVISIONS descripton date on 2 10/30/23 FLOOR 2 RCP

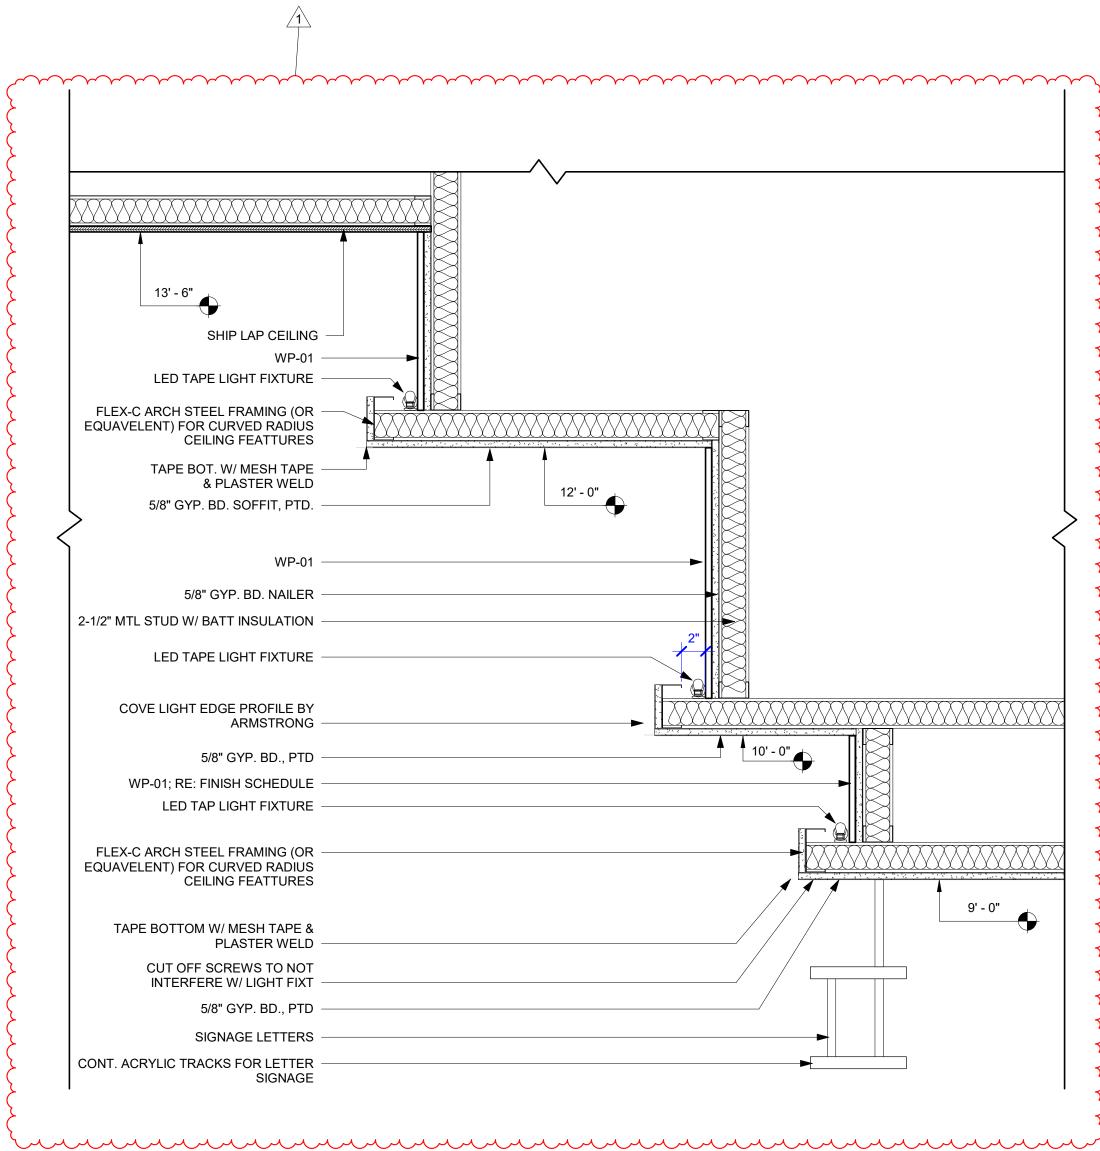
DRAWN BY | Author A7.02











4 SOFFIT AT SERVING STATION A7.06 1 1/2" = 1'-0"





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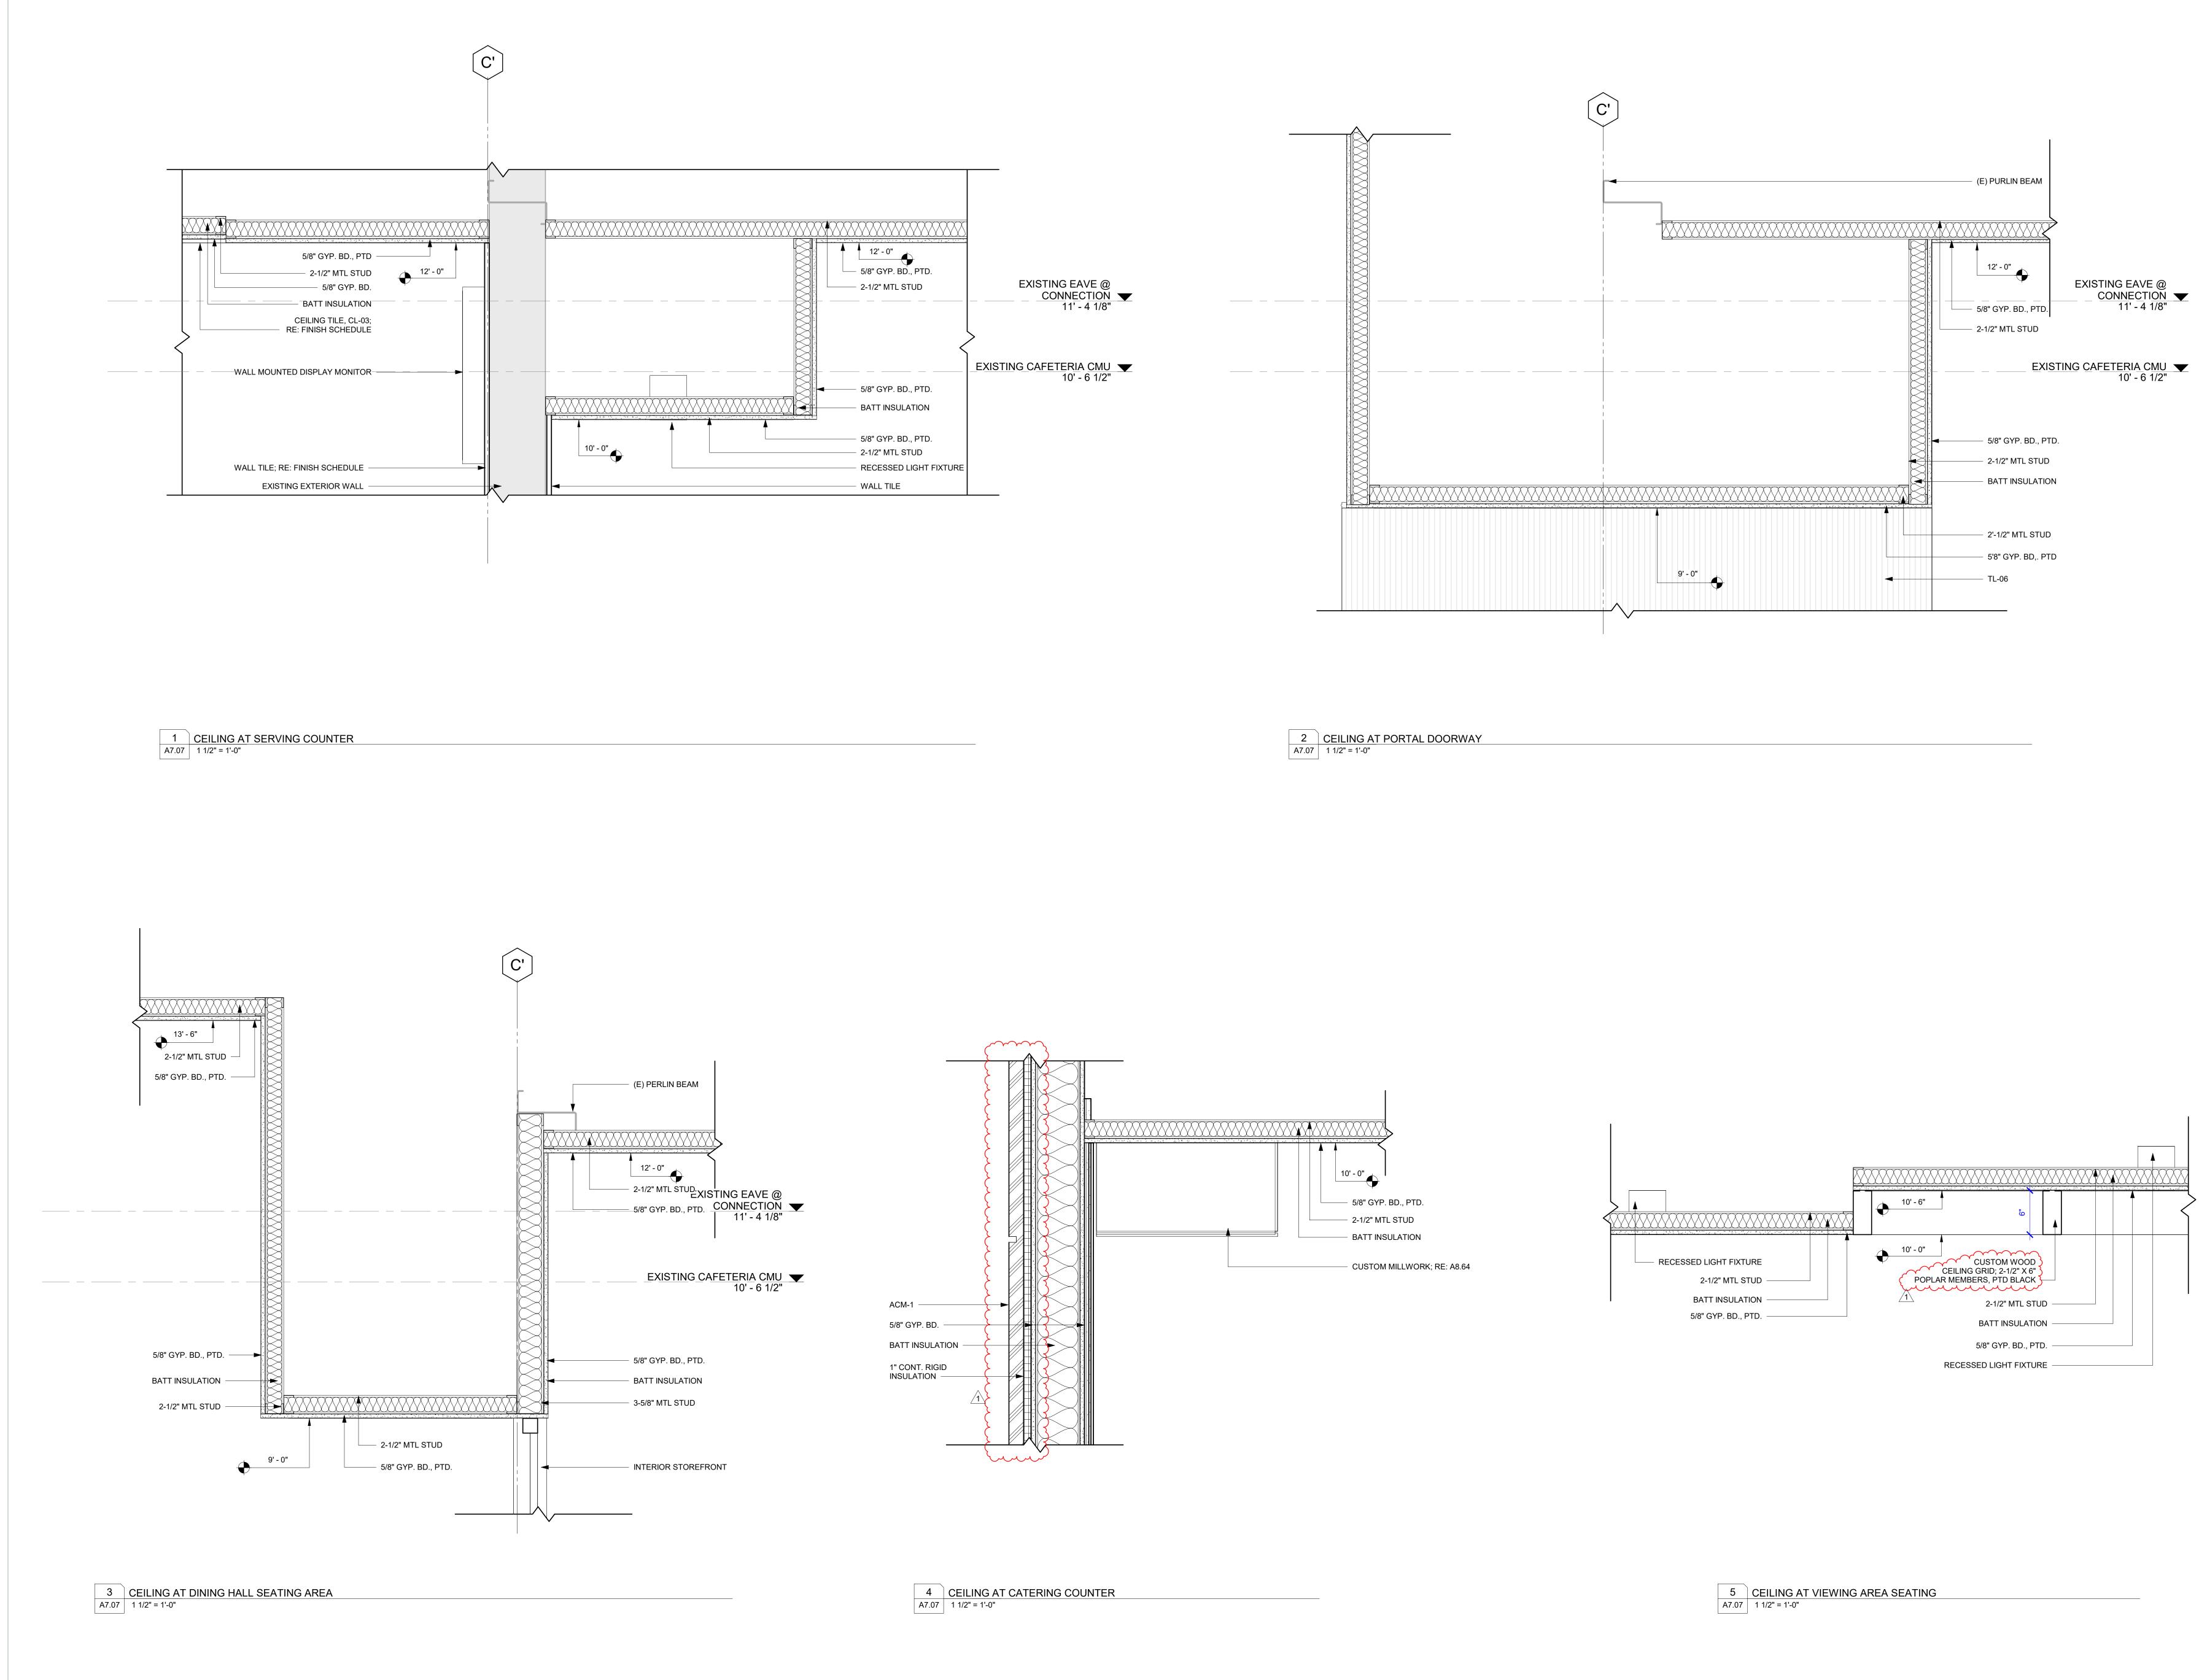
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WDG PROJECT NO | 6022-498 CONSTRUCTION DOCUMENTS 10/09/2023

REVISIONS 
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 date

 Revision 2
 10/30/23
 **CEILING DETAILS** 

DRAWN BY | WDG A7.06





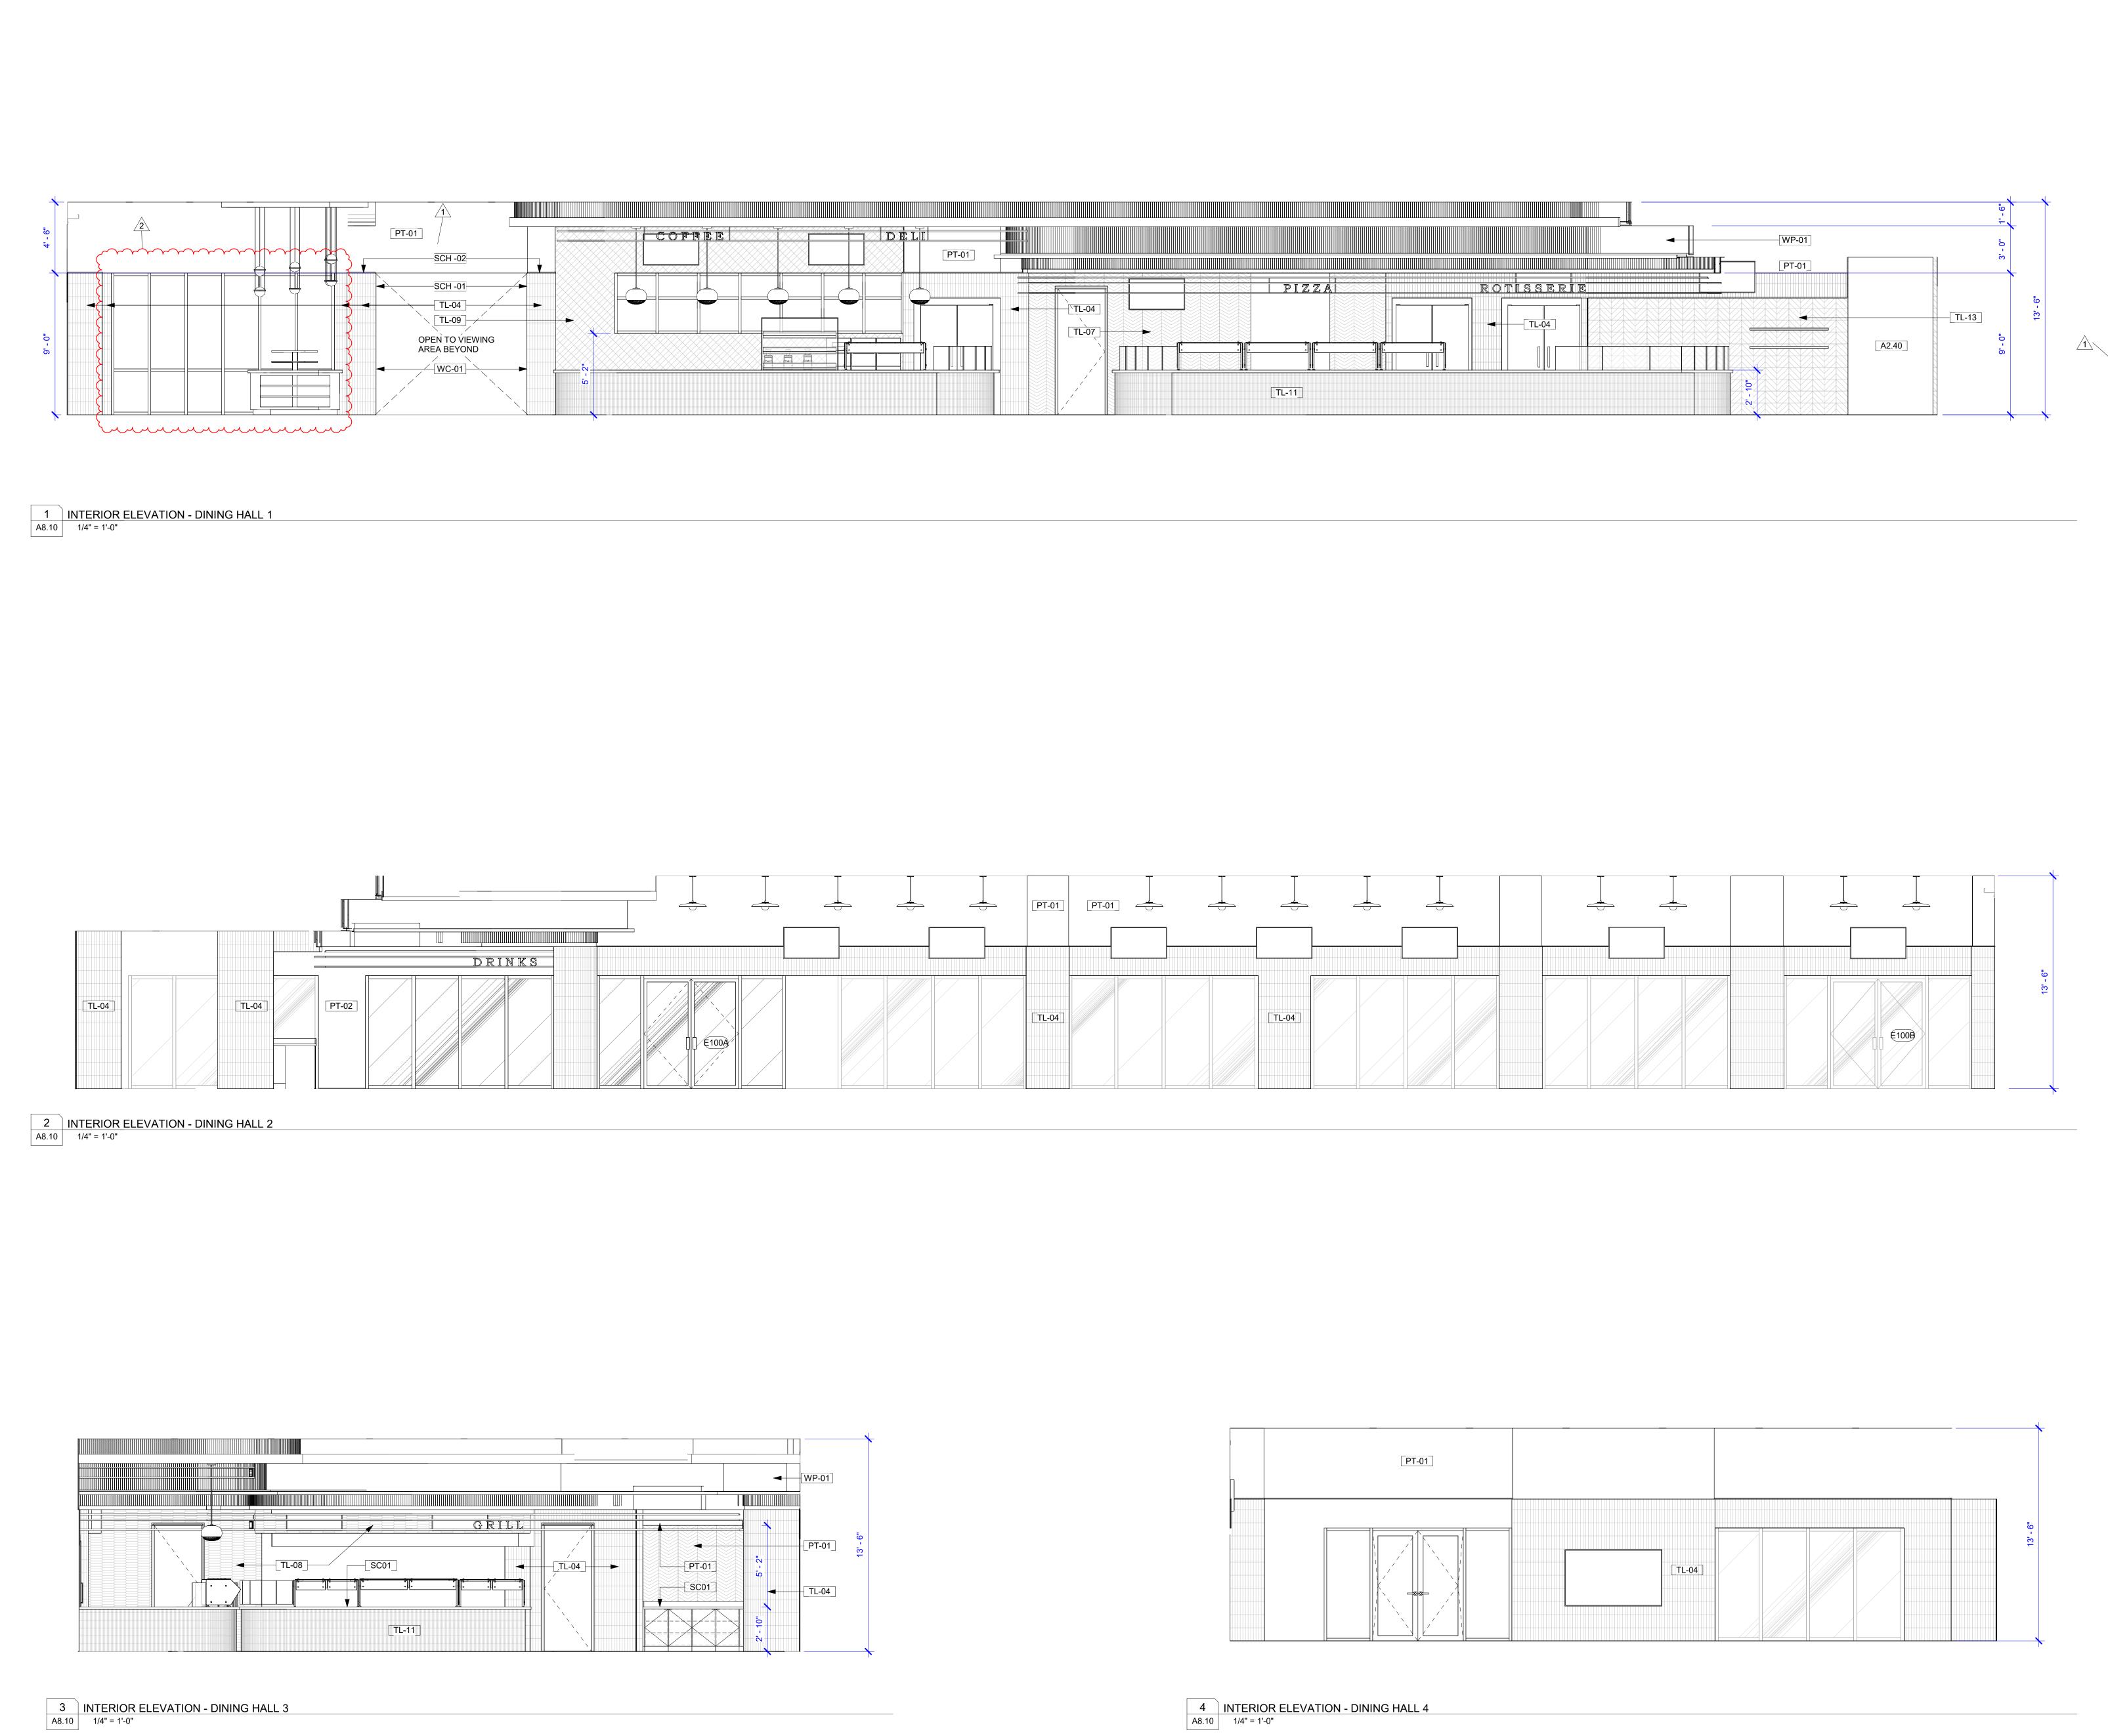
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| CON      | ISTRUCTION DOCUME        | NTS | 10/09/2023       |
|----------|--------------------------|-----|------------------|
|          |                          |     |                  |
| REVI     | SIONS                    |     |                  |
| no.<br>1 | descripton<br>Revision 2 |     | date<br>10/30/23 |
|          |                          |     | 10,00,20         |
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|          |                          |     |                  |
|          |                          |     |                  |
|          |                          |     |                  |
|          |                          |     |                  |

N.O. SAINTS CAFETERIA & VIEWING EXPANSION

5800 Airline Drive

Metairie, Louisiana



|  | 0                   |
|--|---------------------|
|  | 9' - 0"<br>13' - 6" |

| GENERAL NOTES |   |  |  |  |  |  |
|---------------|---|--|--|--|--|--|
| 1.            | SEE PROJECT INFO. SHEET G0.0<br>GENERAL NOTES PERTAINING T  |  |  |  |  |  |
| 2.            | REFER TO SHEET A6.00 FOR PA   |  |  |  |  |  |
| 3.            | REFER TO SHEET A6.20 FOR DO   |  |  |  |  |  |
| 4.            | REFER TO SHEET A6.30 FOR WIN  |  |  |  |  |  |
| 5.            | DIMENSIONS ARE FROM FINISHE<br>WALL TO FINISHED FACE OF WA  |  |  |  |  |  |
| 6.            | ALL DOORS ARE 6" CLR. FROM I<br>OF WALL U.N.O.  |  |  |  |  |  |
| 7.            | ALL DOUBLE DOORS ARE EQUA<br>BETWEEN WALLS U.N.O.   |  |  |  |  |  |
| 8.            | REFER TO FOOD SERVICE PLAN<br>LOCATIONS OF EQUIPMENT AND<br>COORDINATION OF MEP ROUGH   |  |  |  |  |  |
| 9.            | ALL EXTERIOR FINISHES TO REA<br>CLEANED PRIOR TO PROJECT C<br>INCLUDING BUT NOT LIMITED TO<br>METAL PANELS, EIFS, STUCCO,<br>FASCIAS, ETC |  |  |  |  |  |
| 10.           | PROVIDE STAINLESS STEEL CO<br>AT ALL EXTERIOR CORNERS INS   |  |  |  |  |  |
| NO.           | KEYNOTE   |  |  |  |  |  |
| A2.40         | 8'-0" TALL S.S. PANEL   |  |  |  |  |  |
| PT-01         |   |  |  |  |  |  |
| PT-02         | DARK GRAY PAINT   |  |  |  |  |  |
| SC01          | QUARTZ COUNTERTOP   |  |  |  |  |  |
| SCH -01       | S.S. SCHLUTER CORNER TRIM<br>CORNERS, TYP.  |  |  |  |  |  |
| 0011 00       |   |  |  |  |  |  |

|       |  |  | <br> |          |
|-------|--|--|------|----------|
| TL-04 |  |  |      | 13' - 6" |

# CHEET G0.01 FOR ALL RTAINING TO PROJECT. 0 FOR PARTITION TYPES 20 FOR DOOR TYPES. 30 FOR WINDOW TYPES. ROM FINISHED FACE OF FACE OF WALL. CLR. FROM FINISHED FACE ARE EQUALLY SPACED 1.0. RVICE PLAN FOR IPMENT AND MEP ROUGH-INS. GHES TO REMAIN SHALL BE PROJECT COMPLETION. I LIMITED TO GLAZING, S, STUCCO, AWNINGS, STEEL CORNER GUARDS ORNERS INSIDE KITCHEN



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EYNOTE

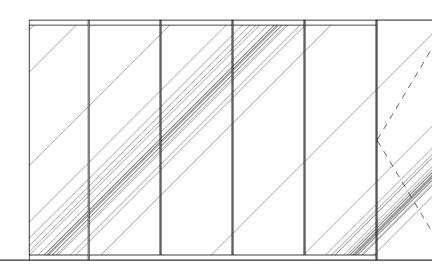
| PT-02   | DARK GRAY PAINT   |
|---------|---|
| SC01    | QUARTZ COUNTERTOP                                       |
| SCH -01 | S.S. SCHLUTER CORNER TRIM AT OUTSIDE CORNERS, TYP.      |
| SCH -02 | BLACK SCHLUTER TRIM AT TOP OF TILE<br>TERMINATION, TYP. |

WC-01WALL COVERINGWP-01WOOD TAMBOUR SOFFIT

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| Revision 1<br>Revision 2 |             | 10/23/23<br>10/30/23 |
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| PT-02 | PT-02 |
|-------|-------|
|       |       |

2INTERIOR ELEVATION - 1ST FLOOR VIEWING AREA 2A8.111/4" = 1'-0"



1INTERIOR ELEVATION - 1ST FLOOR VIEWING AREA 1A8.111/4" = 1'-0"

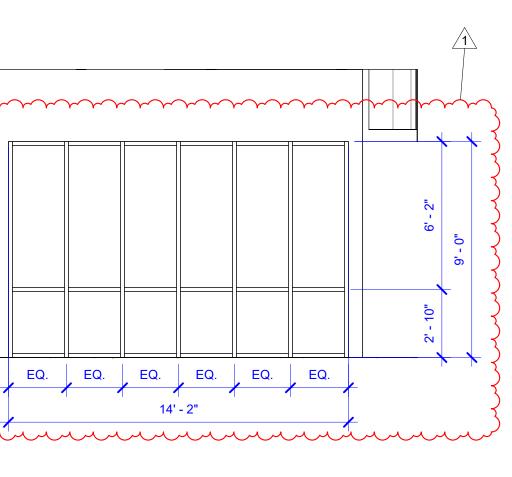
PT-02

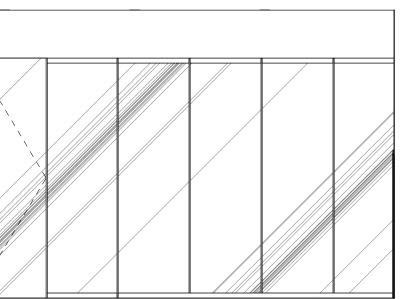
| PT-02 | WC-01<br>OPEN TO<br>DINING HALL<br>BEYOND |  |
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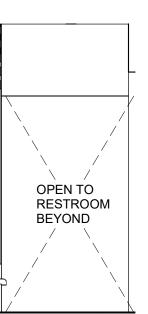
| OPEN TO<br>RESTROOM<br>BEYOND |  |
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|                               |  |

4INTERIOR ELEVATION - 1ST FLOOR VIEWING AREA 4A8.111/4" = 1'-0"

| GENERAL NOTES |  |  |  |  |  |
|---------------|--|--|--|--|--|
| 1.            | SEE PROJECT INFO. SHE<br>GENERAL NOTES PERTA   |  |  |  |  |
| 2.            | REFER TO SHEET A6.00   |  |  |  |  |
| 3.            | REFER TO SHEET A6.20   |  |  |  |  |
| 4.            | REFER TO SHEET A6.30   |  |  |  |  |
| 5.            | DIMENSIONS ARE FROM<br>WALL TO FINISHED FACI   |  |  |  |  |
| 6.            | ALL DOORS ARE 6" CLR<br>OF WALL U.N.O.   |  |  |  |  |
| 7.            | ALL DOUBLE DOORS AR<br>BETWEEN WALLS U.N.O   |  |  |  |  |
| 8.            | REFER TO FOOD SERVIC<br>LOCATIONS OF EQUIPMI<br>COORDINATION OF MEP  |  |  |  |  |
| 9.            | ALL EXTERIOR FINISHES<br>CLEANED PRIOR TO PRO<br>INCLUDING BUT NOT LIN<br>METAL PANELS, EIFS, ST<br>FASCIAS, ETC |  |  |  |  |
| 10.           | PROVIDE STAINLESS ST<br>AT ALL EXTERIOR CORN   |  |  |  |  |
| NO.           | KEY  |  |  |  |  |
| PT-01         | WHITE PAINT  |  |  |  |  |
| PT-02         | DARK GRAY PAINT  |  |  |  |  |
| WC-01         | WALL COVERING  |  |  |  |  |







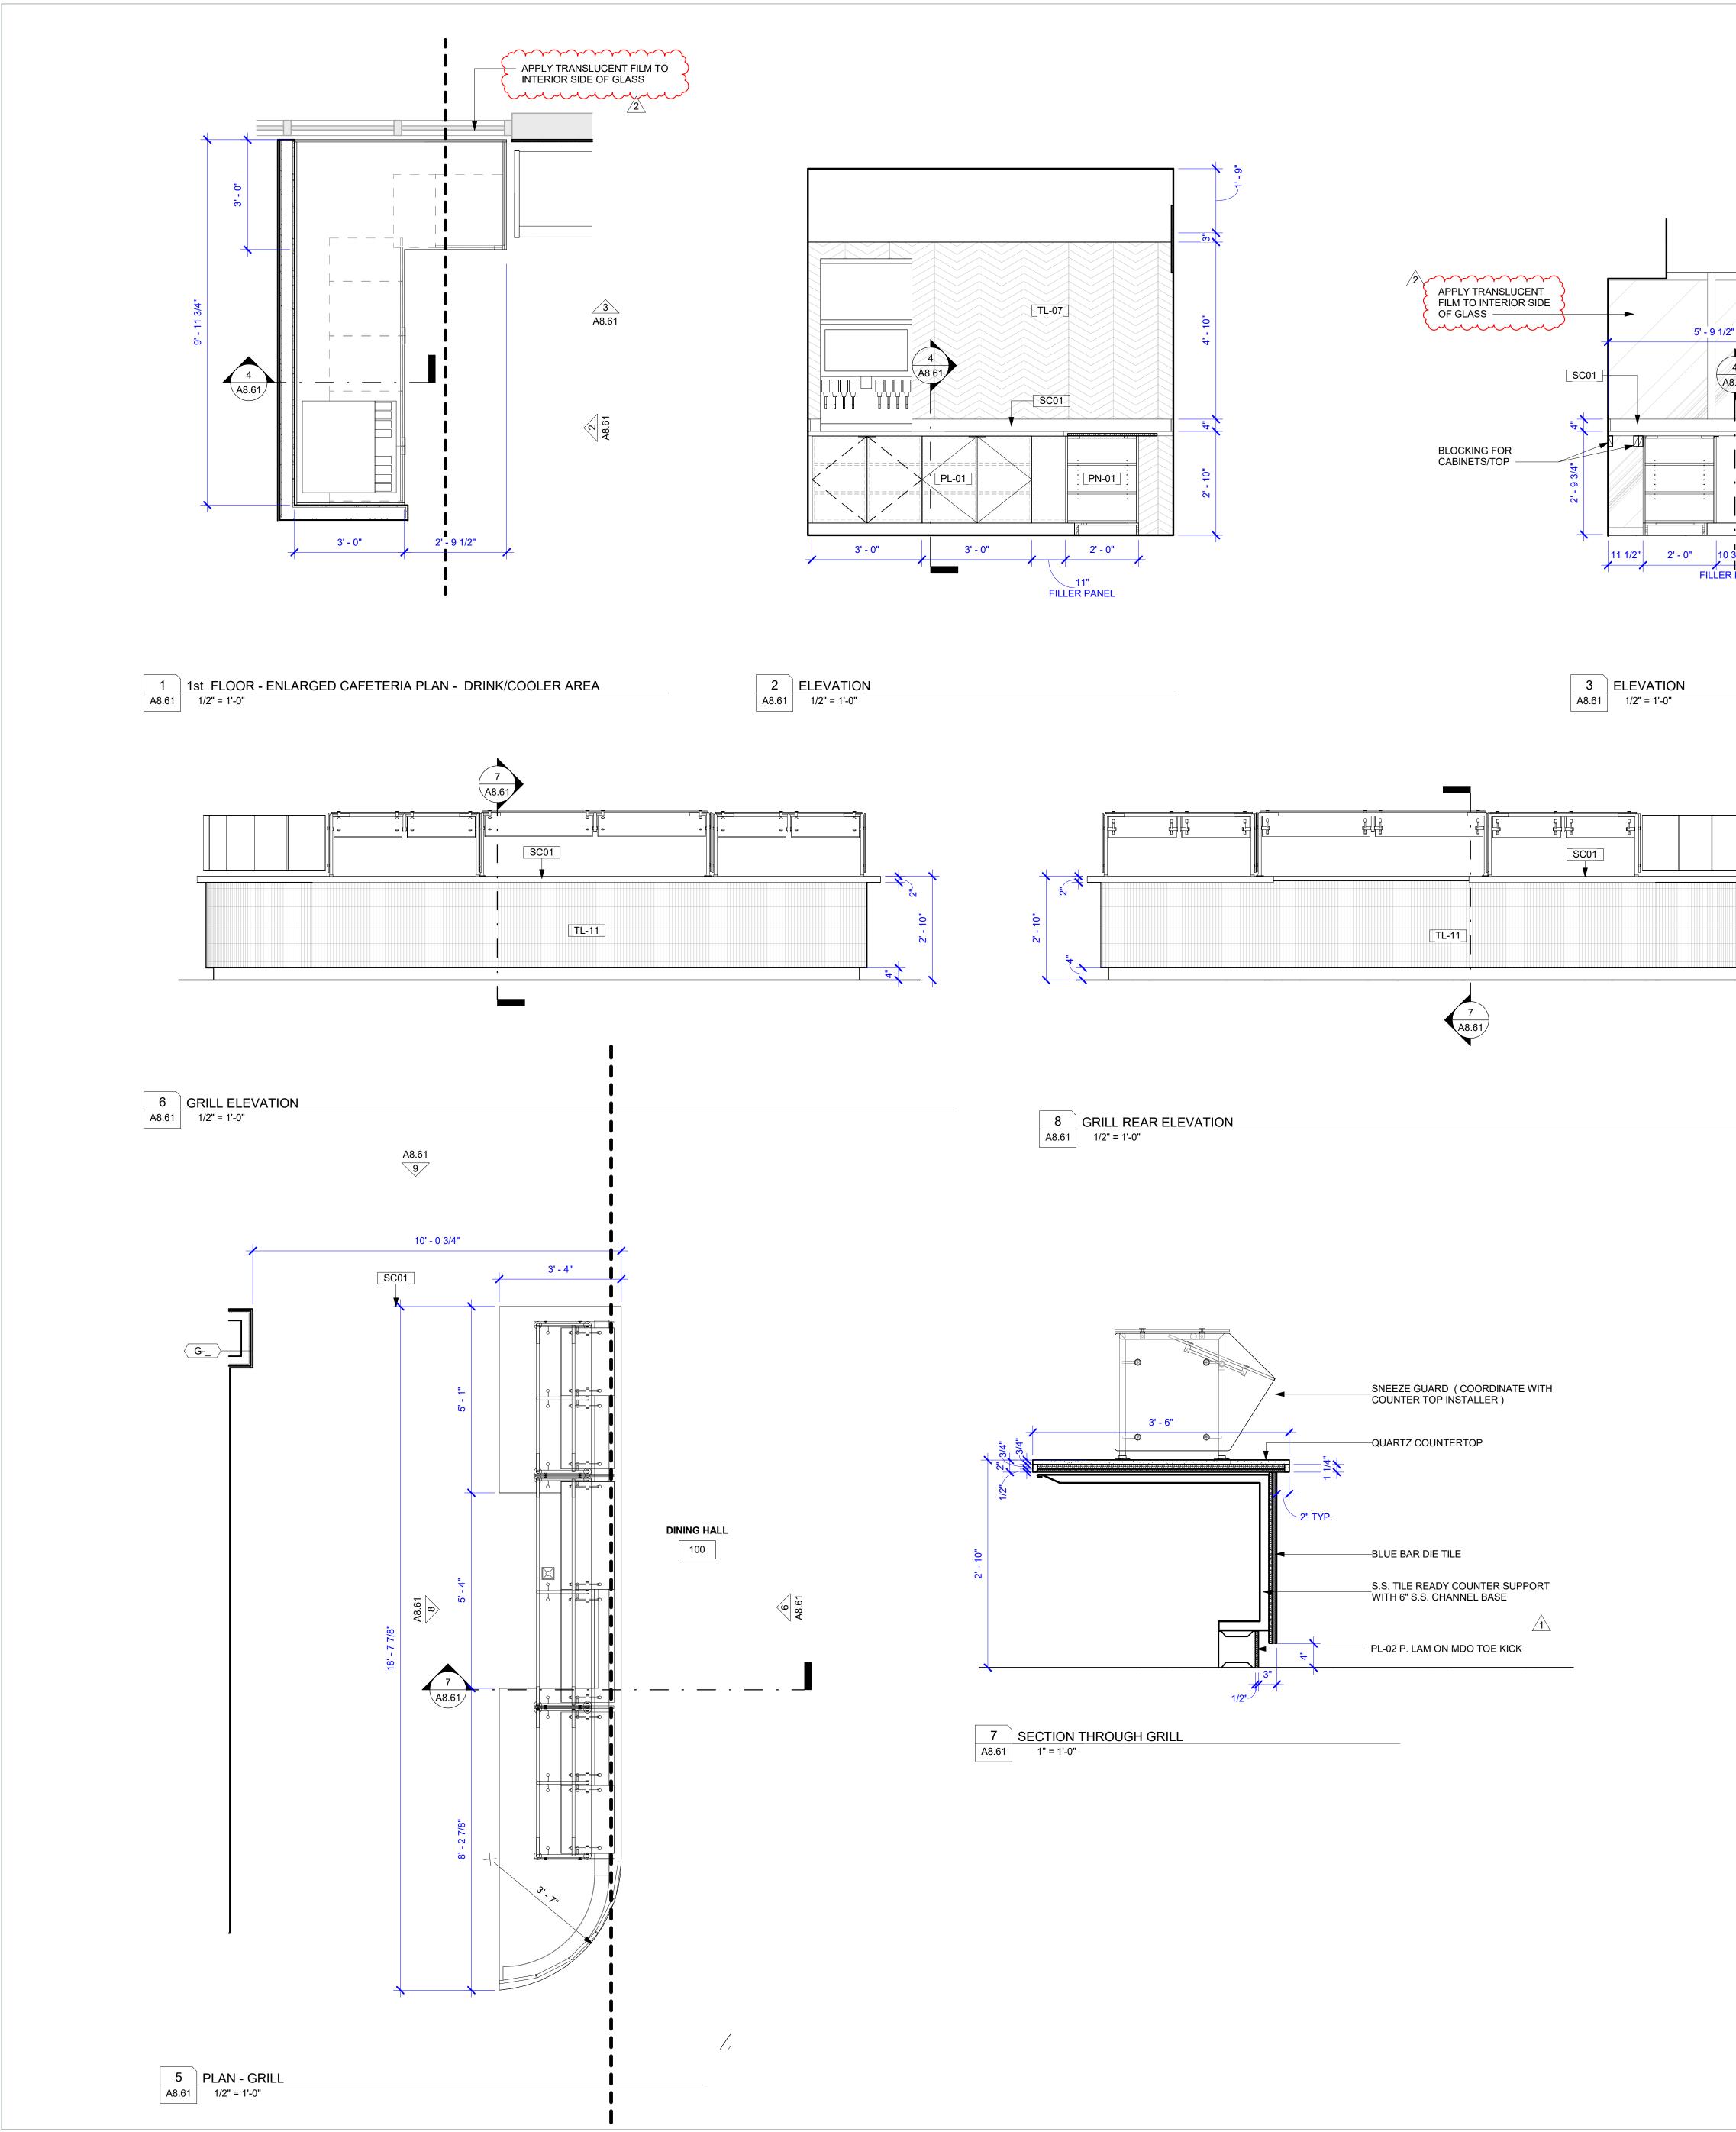
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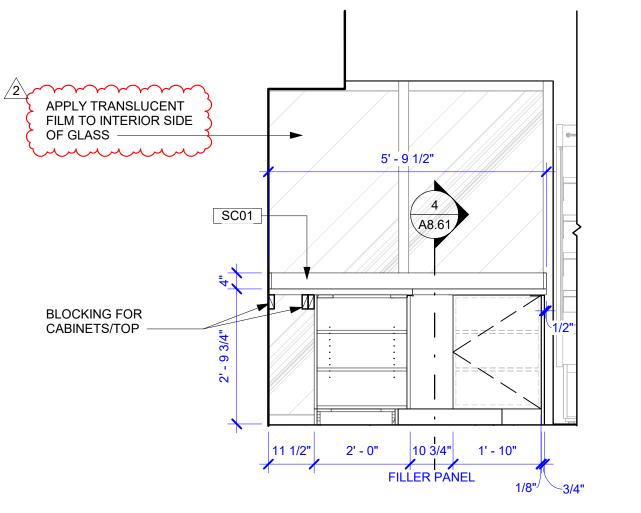
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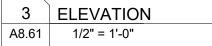


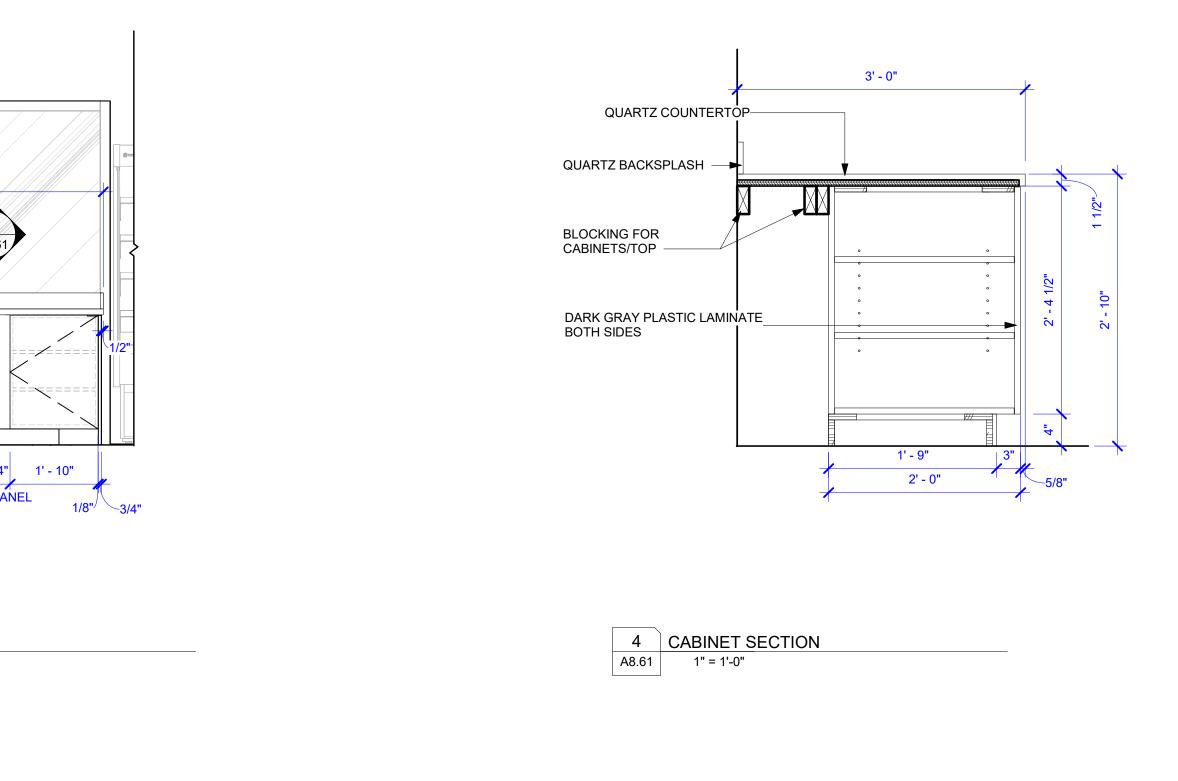
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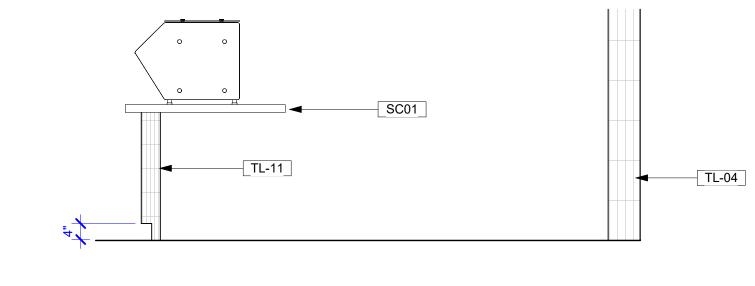
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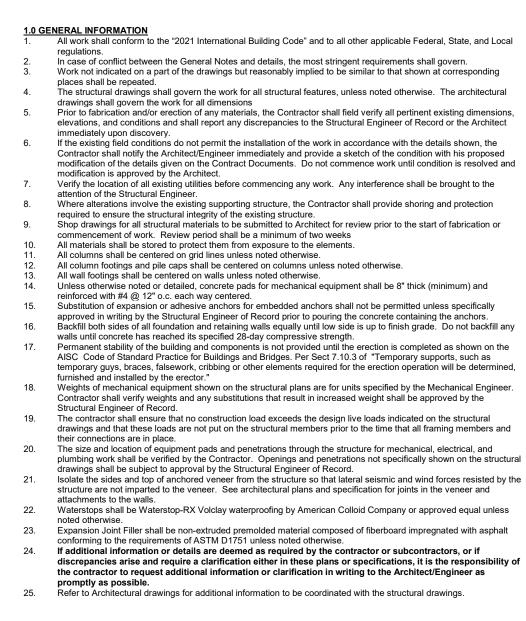
 9
 SOUTH ELEVATION GRILL

 A8.61
 1/2" = 1'-0"



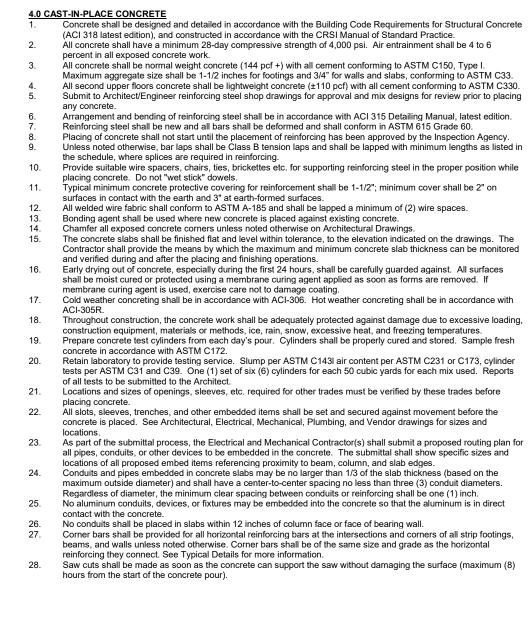
Erik Wismar, AIA

N.O. SAINTS CAFETERIA & VIEWING EXPANSION 5800 Airline Drive Metairie, Louisiana WDG PROJECT NO | 6022-498 \_ CONSTRUCTION DOCUMENTS 10/09/2023 REVISIONS ENLARGED PLANS AND MILLWORK DETAILS DRAWN BY | Author A8.61



2.0 FOUNDATIONS Remove 6-mil vapor retarder and earth fill where concrete will bear on top of pile cap or spread footing. Material used for filling voids under concrete shall be extruded polystyrene insulation board having a minimum compressive strength of 15 psi. Piling shall be treated timber and shall conform to ASTM D25 with a minimum tip diameter of 6 inches and minimum butt diameter of 8 inches (Class 5). Pile length = 35 ft. Design Load = 8 tons as established by the pile load test performed by Eustis Engineering Company, Inch and dated April 26,1995. Piling shall be treated timber and shall conform to ASTM D25 with a minimum tip diameter of 8 inches and minimum butt diameter of 12 inches (Class B). Pile length = 45 ft. Design Load = 17 tons as established by the Geotechnical Investigation performed by Gillen Engineering, LLC and dated August 24, 2012. A minimum of one (1) in-situ load test shall be optional in accordance with ASTM D1143 procedures for piles under static axial compression load. Testing requirements are as per the timber pile design and shall be approved by the Structural EOR. Tests should be performed, unless otherwise specified, by the Timber Pile Installer. Trenching and other excavation coordination for foundations with Pile Foundations shall be the responsibility of the General The Contractor shall coordinate the drilling and testing schedules with the Structural Engineer and shall give a minimum of 48 hours advance notice prior to beginning operations The report of the Geotechnical Engineer or pile load test report shall be forwarded to the Architect and the Structural Engineer of Record for review. Contractor is to notify "LA One Call" a minimum of 48 hours before pile driving operations commence. All piles shall be treated to 0.8 CCA or approved equivalent.

 3.0 ADHESIVE SET ANCHORS AND DOWELS
 Unless noted otherwise, Hitli HIT-HY 270 epoxy system shall be used for an adhesive anchor in hollow brick masonry. Unless noted otherwise, Hilti HIT-HY 200 epoxy system shall be used for an adhesive anchor or dowel in concrete or concrete masonry. Where base material is hollow block brick or other material containing pockets or voids, a screen tube, per manufacturers recommendations, shall be employed in the system. Where embedment depths are not specifically called out on the drawings, notify the Structural Engineer of Record for depth required. A minimum depth required to develop the yield strength of the rod or reinforcing bar will be considered the minimum acceptable without written instructions stating otherwise. Follow manufacturer's requirements for minimum depth of base material, minimum edge distances, and minimum bolt/bar spacing. Anchor capacity used shall be based on the technical data published by Hilti or such other method approved by the 6. EOR. Substitution requests for alternate products must be approved in writing by the EOR prior to use. Contractor shall provide calculations demonstrating that the substituted product is capable of achieving the performance values of the specified product. Substitutions will be evaluated by their having and ICC ESR/ESL showing compliance with the relevant building code for seismic, load resistance, installation category, and availability of comprehensive installation instructions. Adhesive anchor evaluations will also consider creep, in-service temperature and installation temperature. The contractor shall arrange an anchor manufacturer's representative to provide on-site isntallation training for all 7. of the anchoring products specified. The EOR must receive documented confirmation that all of the contractor's personnel who install anchors are trained prior to the commencement of installing anchors. Existing reinforcing bars in the concrete structure may conflict with the specific anchor locations. Unless noted otherwise on the drawings that the bars can be cut, the contractor shall review the existing structural drawings and shall locate the position of the reinforcing bars at the locations of the concrete anchors by the use of Hilti Ferroscan, Hilti PS 1000, ground penetration radar, x-ray, chipping or other approved means.





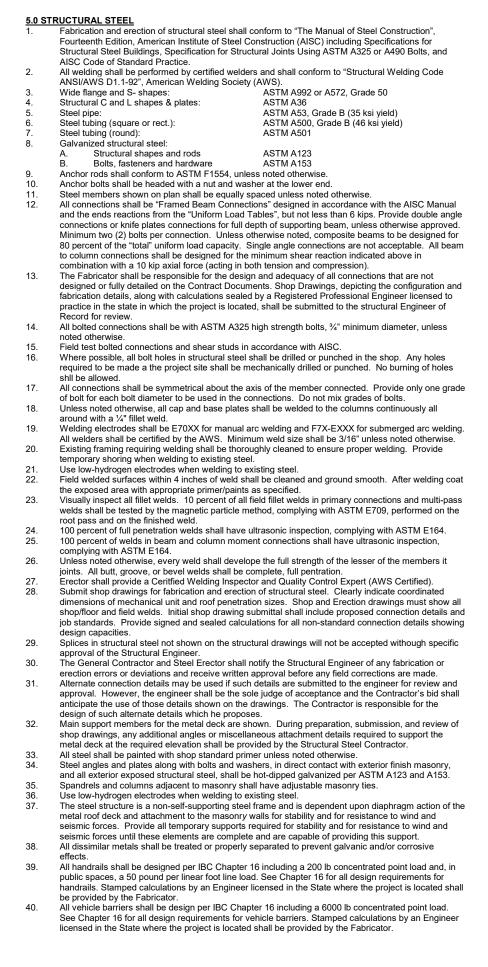
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4.

7.0 METAL DECK

of the EOR.

attachment of steel deck.



|      |                                | RCING S<br>AND EM |                           |               |                           |
|------|--------------------------------|-------------------|---------------------------|---------------|---------------------------|
| BAR  | MIN LAP SPLICE<br>LENGTH (IN.) |                   | MIN EMBED<br>LENGTH (IN.) |               | MIN EMBED<br>LENGTH FOR   |
| SIZE | TOP<br>BARS                    | OTHER<br>BARS     | TOP<br>BARS               | OTHER<br>BARS | HY 150 MAX<br>EPOXY (IN.) |
| 3    | 15                             | 12                | 12                        | 12            | 4                         |
| 4    | 20                             | 15                | 15                        | 12            | 5-1/2                     |
| 5    | 29                             | 23                | 23                        | 17            | 6-3/4                     |
| 6    | 40                             | 31                | 31                        | 24            | 8-1/2                     |
| 7    | 43                             | 33                | 33                        | 25            | 10                        |
| 8    | 49                             | 37                | 37                        | 29            | 11-1/2                    |
| 9    | 60                             | 46                | 46                        | 36            | 14-1/2                    |
| 10   | 74                             | 57                | 57                        | 44            | 15                        |
|      |                                |                   |                           |               |                           |

Table based on ACI 318-02 w/ fc = 4000 psi and fy = 60000

Top bars are considered to be horizontal bars with more

than 12" depth of concrete cast below the reinforcement. Horizontal wall reinforcement is considered a top bar.

 
 6.0 STEEL JOISTS

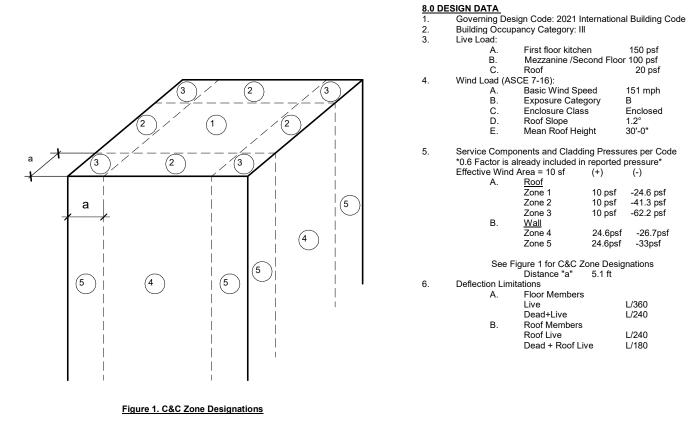
 1.
 Steel joists and accessories (including bridging) shall be fabricated and erected in accordance with the
 manufacturer's and Steel Joist Institute's latest specifications and requirements. The joist manufacturer shall confirm that all roof joist can safely withstand uplift pressures shown on the 8.0 and 8.1 section of these general notes. Bridging shall be specified and placed as required for lateral support of the bottom chords. The bridging requirments as well as any additional bracing or increase in members sizes for this loading shall be determined and provided by the joist manufacturer. Strut joint are noted on the plan as "SJ" and shall have bottom chord members same as top chord. Do not connect bottom chord to beam or columns until floor or roof load is in place on joist. Items imposing concentrated loads on steel joists shall be placed at joint panel points. Where items are not at joist panel point, the joist shall be reinforced to distibute the load. See Typical Details for section. Metal deck shall be designed and detailed in accordance with the "Design Manual for Floor Decks and Roof Decks" of the Steel Deck Institute (SDI), latest edition. All composite steel floor deck shall be in conformance with the "Specifications for Composite Steel Floor Deck" of the SDI, latest edition. Deck properties are based on products manufactured by New Millenium. Decks by other manufacturer's may be

supplied provided load carrying capacity based on manufacturer's standard load tables, deflection characteristics and UL fire ratings equal or exceed those of materials specified and if approved by the Architect and Structural 3. Install in accordance with SDI suggested Specifications unless noted otherwise on the drawings. Individual deck sheets shall extend over at least three spans, with laps to be placed over supports.
Deck supplier shall provide all additional framing, closure angles and plates, pour stops, screed angles, and roof sump pans as required at the edges of all openings and at all slab depressions, or changes of deck direction, including those which have not been detailed. 5. Roof and non-composite decks shall be attached to steel supports, including the edge support parallel to the deck span with powder actuted fasteners equal to Hilti X-HSN 24 for attachment to bar joist and Hilti X-ENP19 for attachment to other steel elements at 12 inches OC interior (36/4 pattern ) and 6 inches OC at edge of deck sheet. Fasten side laps with #10 self-tapping screws at 36 inches OC maximum spacing. Steel deck supplier shall submit shop drawings indicating the shear stud placement if shear studs are present. Prior to and during concrete placement, the floor deck shall be planked to prevent damage to the deck. Concentrated and impact loads shall be avoided. All beam shear study shall be 3/4"Ø x 3-1/2" long Nelson S3F or an approved equal. Minimum spacing of study shall be 4-1/2" longitudinally and 3" transversely. Steel roof and floor deck shall be supported around all opening, columns, roof penetrations, hips, and valleys. Roof and floor deck openings larger than 12" which are not shown on the drawings shall be brought to the attention No mechanical or electrical piping, fixtures, units or systems may be hung directly from the roof deck. The installer that will be using the tools to attach the powder-actuated frame fasteners shall be trained and certified

by fastener manufacturer's representative on the general use of powder-actuated technology and fastening guidelines for the attachment of steel deck. The installer that will be using the tools to attach the screw fasteners

shall be trained by fastener manufacturer's representative on the proper tools and fastening guidelines for the

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|                 | DRAWING LIST  |                     |                          |                                 |  |  |
|-----------------|---|---------------------|--------------------------|---------------------------------|--|--|
| Sheet<br>Number | Sheet Name  | Current<br>Revision | Current Revision<br>Date | Current Revision<br>Description |  |  |
|                 |   |                     | 10/00/00                 |                                 |  |  |
| C0.00           | CIVIL NOTES   | 1                   | 10/23/23                 | Revision 1                      |  |  |
| C1.00           |   |                     |                          |                                 |  |  |
| C1.01           |   |                     |                          |                                 |  |  |
| C1.02           | SITE UTILITY PLAN   |                     | 4.0.100.100              |                                 |  |  |
| C1.03           | PAVING PLAN   | 1                   | 10/23/23                 | Revision 1                      |  |  |
| C1.04           | JEFFERSON PARISH STANDARD DETAILS                                     |                     | 4.0.100.100              |                                 |  |  |
| S0.0            |   | 1                   | 10/23/23                 | Revision 1                      |  |  |
| S1.0            | OVERALL FOUNDATION PLAN   | 2                   | 10/30/23                 | Revision 2                      |  |  |
| S1.0.1          | ENLARGED PARTIAL FOUNDATION PLANS I                                   | 2                   | 10/30/23                 | Revision 2                      |  |  |
| S1.0.2          | ENLARGED PARTIAL FOUNDATION PLANS II                                  | 2                   | 10/30/23                 | Revision 2                      |  |  |
| S1.1            | TYPICAL CONCRETE FOUNDATION/BASE PLATE<br>DETAILS                     |                     |                          |                                 |  |  |
| S1.2            | FOUNDATION DETAILS I  | 1                   | 10/30/23                 | Revision 2                      |  |  |
| S1.3            | FOUNDATION DETAILS II   |                     |                          |                                 |  |  |
| S2.0            | TRELLIS FRAMING PLAN  | 1                   | 10/30/23                 | Revision 2                      |  |  |
| S3.0            | OVERALL SECOND FLOOR AND LOW ROOF FRAMING<br>PLAN                     | 2                   | 10/30/23                 | Revision 2                      |  |  |
| S3.0.1          | ENLARGED SECOND FLOOR AND LOW ROOF FRAMING PLAN I                     | 2                   | 10/30/23                 | Revision 2                      |  |  |
| \$3.0.2         | ENLARGED SECOND FLOOR AND LOW ROOF FRAMING PLAN II                    | 2                   | 10/30/23                 | Revision 2                      |  |  |
| S3.1            | STEEL FLOOR FRAMING DETAILS   | 2                   | 10/30/23                 | Revision 2                      |  |  |
| S4.0            | HIGH ROOF FRAMING PLAN  | 1                   | 10/23/23                 | Revision 1                      |  |  |
| S4.1            | STEEL ROOF FRAMING DETAILS  | 2                   | 10/30/23                 | Revision 2                      |  |  |
| S4.2            | STEEL X BRACING ELEVATIONS  |                     |                          |                                 |  |  |
| S4.3            | EXISTING PRACTICE FACILITY STEEL X BRACING<br>ELEVATION MODIFICATIONS | 2                   | 10/30/23                 | Revision 2                      |  |  |
| S5.0            | TYPICAL STEEL FRAMING DETAILS   |                     |                          |                                 |  |  |
| S6.0            | TYPICAL COLD- FORMED FRAMING DETAILS                                  |                     |                          |                                 |  |  |



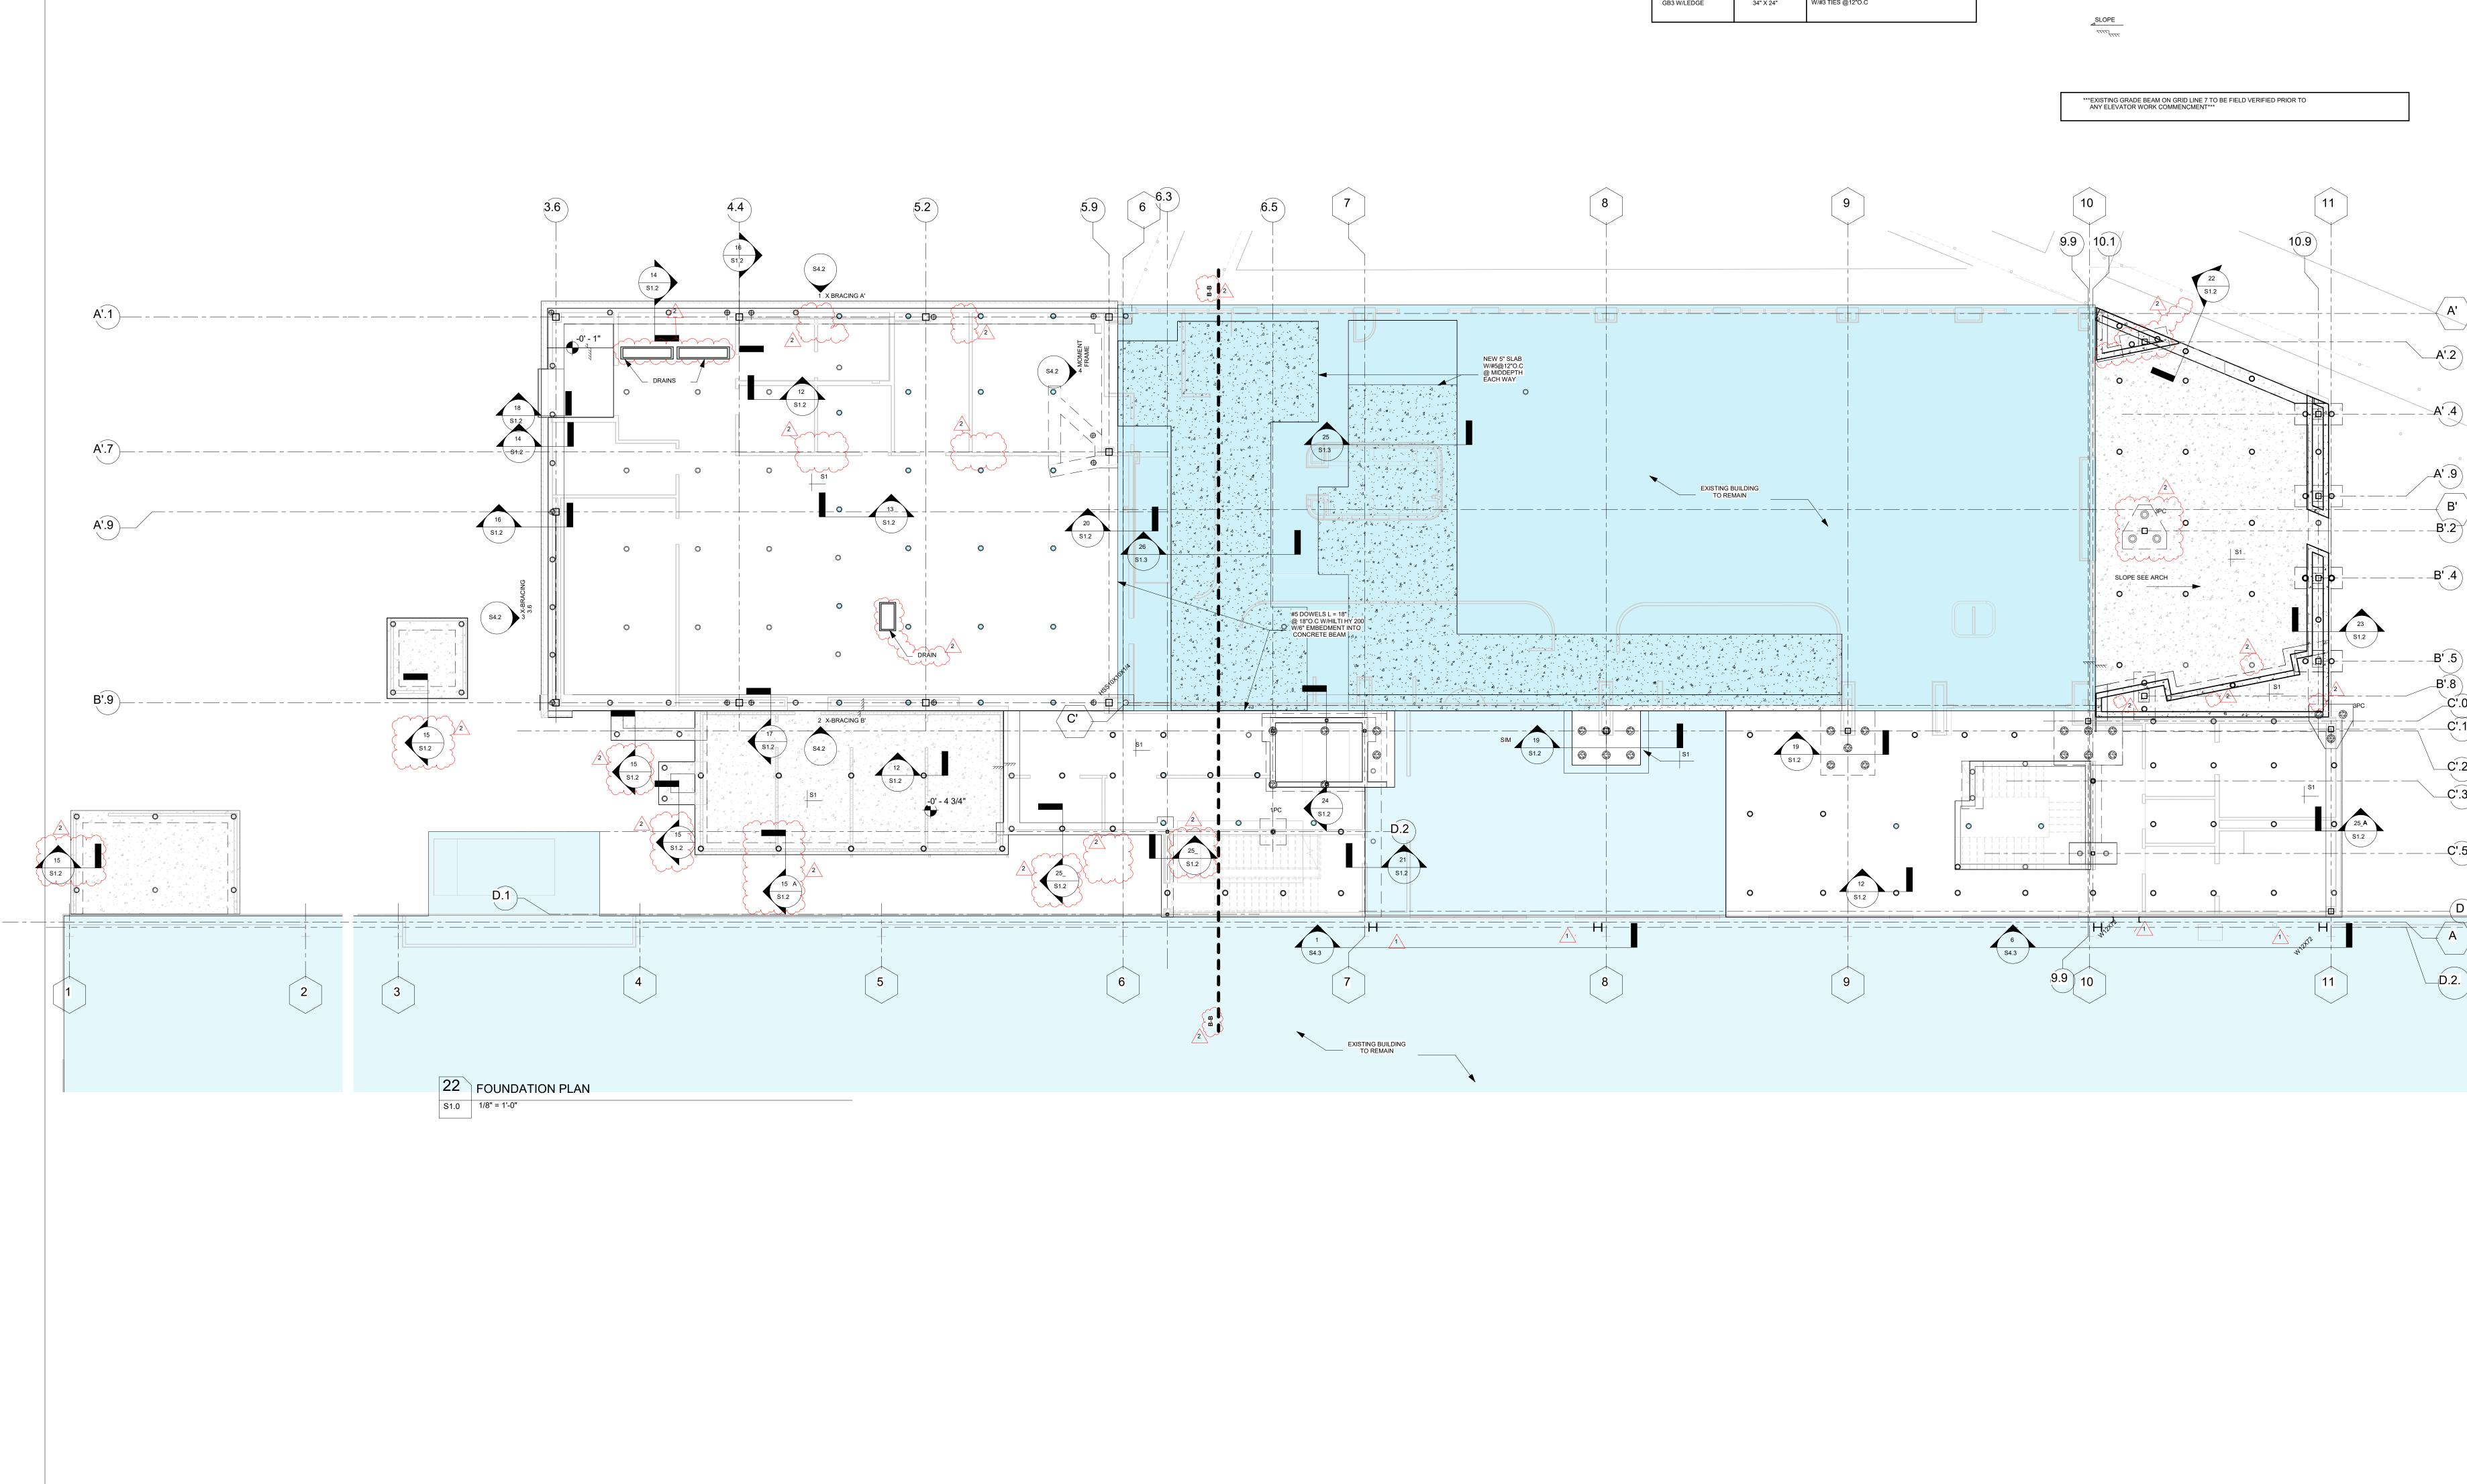
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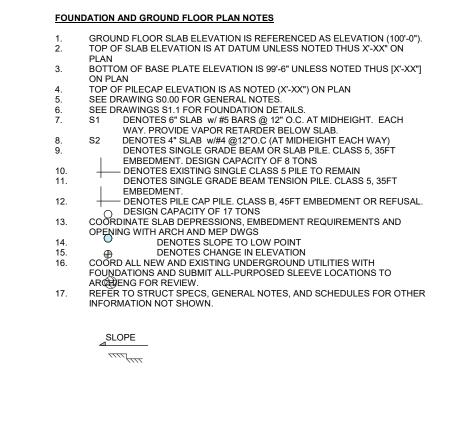
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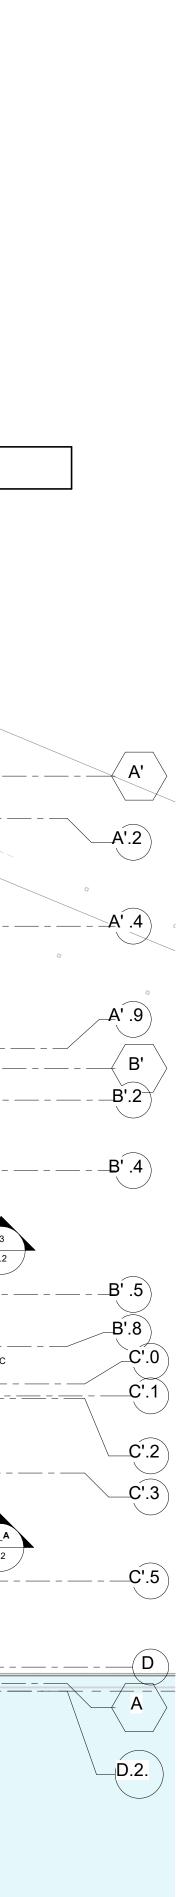
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10/09/23



| CONCRETE (  | ONCRETE GRADE BEAM SCHEDULE |  |  |  |
|-------------|-----------------------------|--|--|--|
| MARK        | WIDTH X DEPTH               | REINFORCEMENT                            |  |  |
| GB1         | 24" X 24"                   | (4) #6 TOP & BOTTOM<br>W/#3 TIES @12"O.C |  |  |
| GB2         | 18" X 24"                   | (4) #6 TOP & BOTTOM<br>W/#3 TIES @12"O.C |  |  |
| GB3         | 30" X 24"                   | (4) #6 TOP & BOTTOM<br>W/#3 TIES @12"O.C |  |  |
| GB3 W/LEDGE | 34" X 24"                   | (4) #6 TOP & BOTTOM<br>W/#3 TIES @12"O.C |  |  |





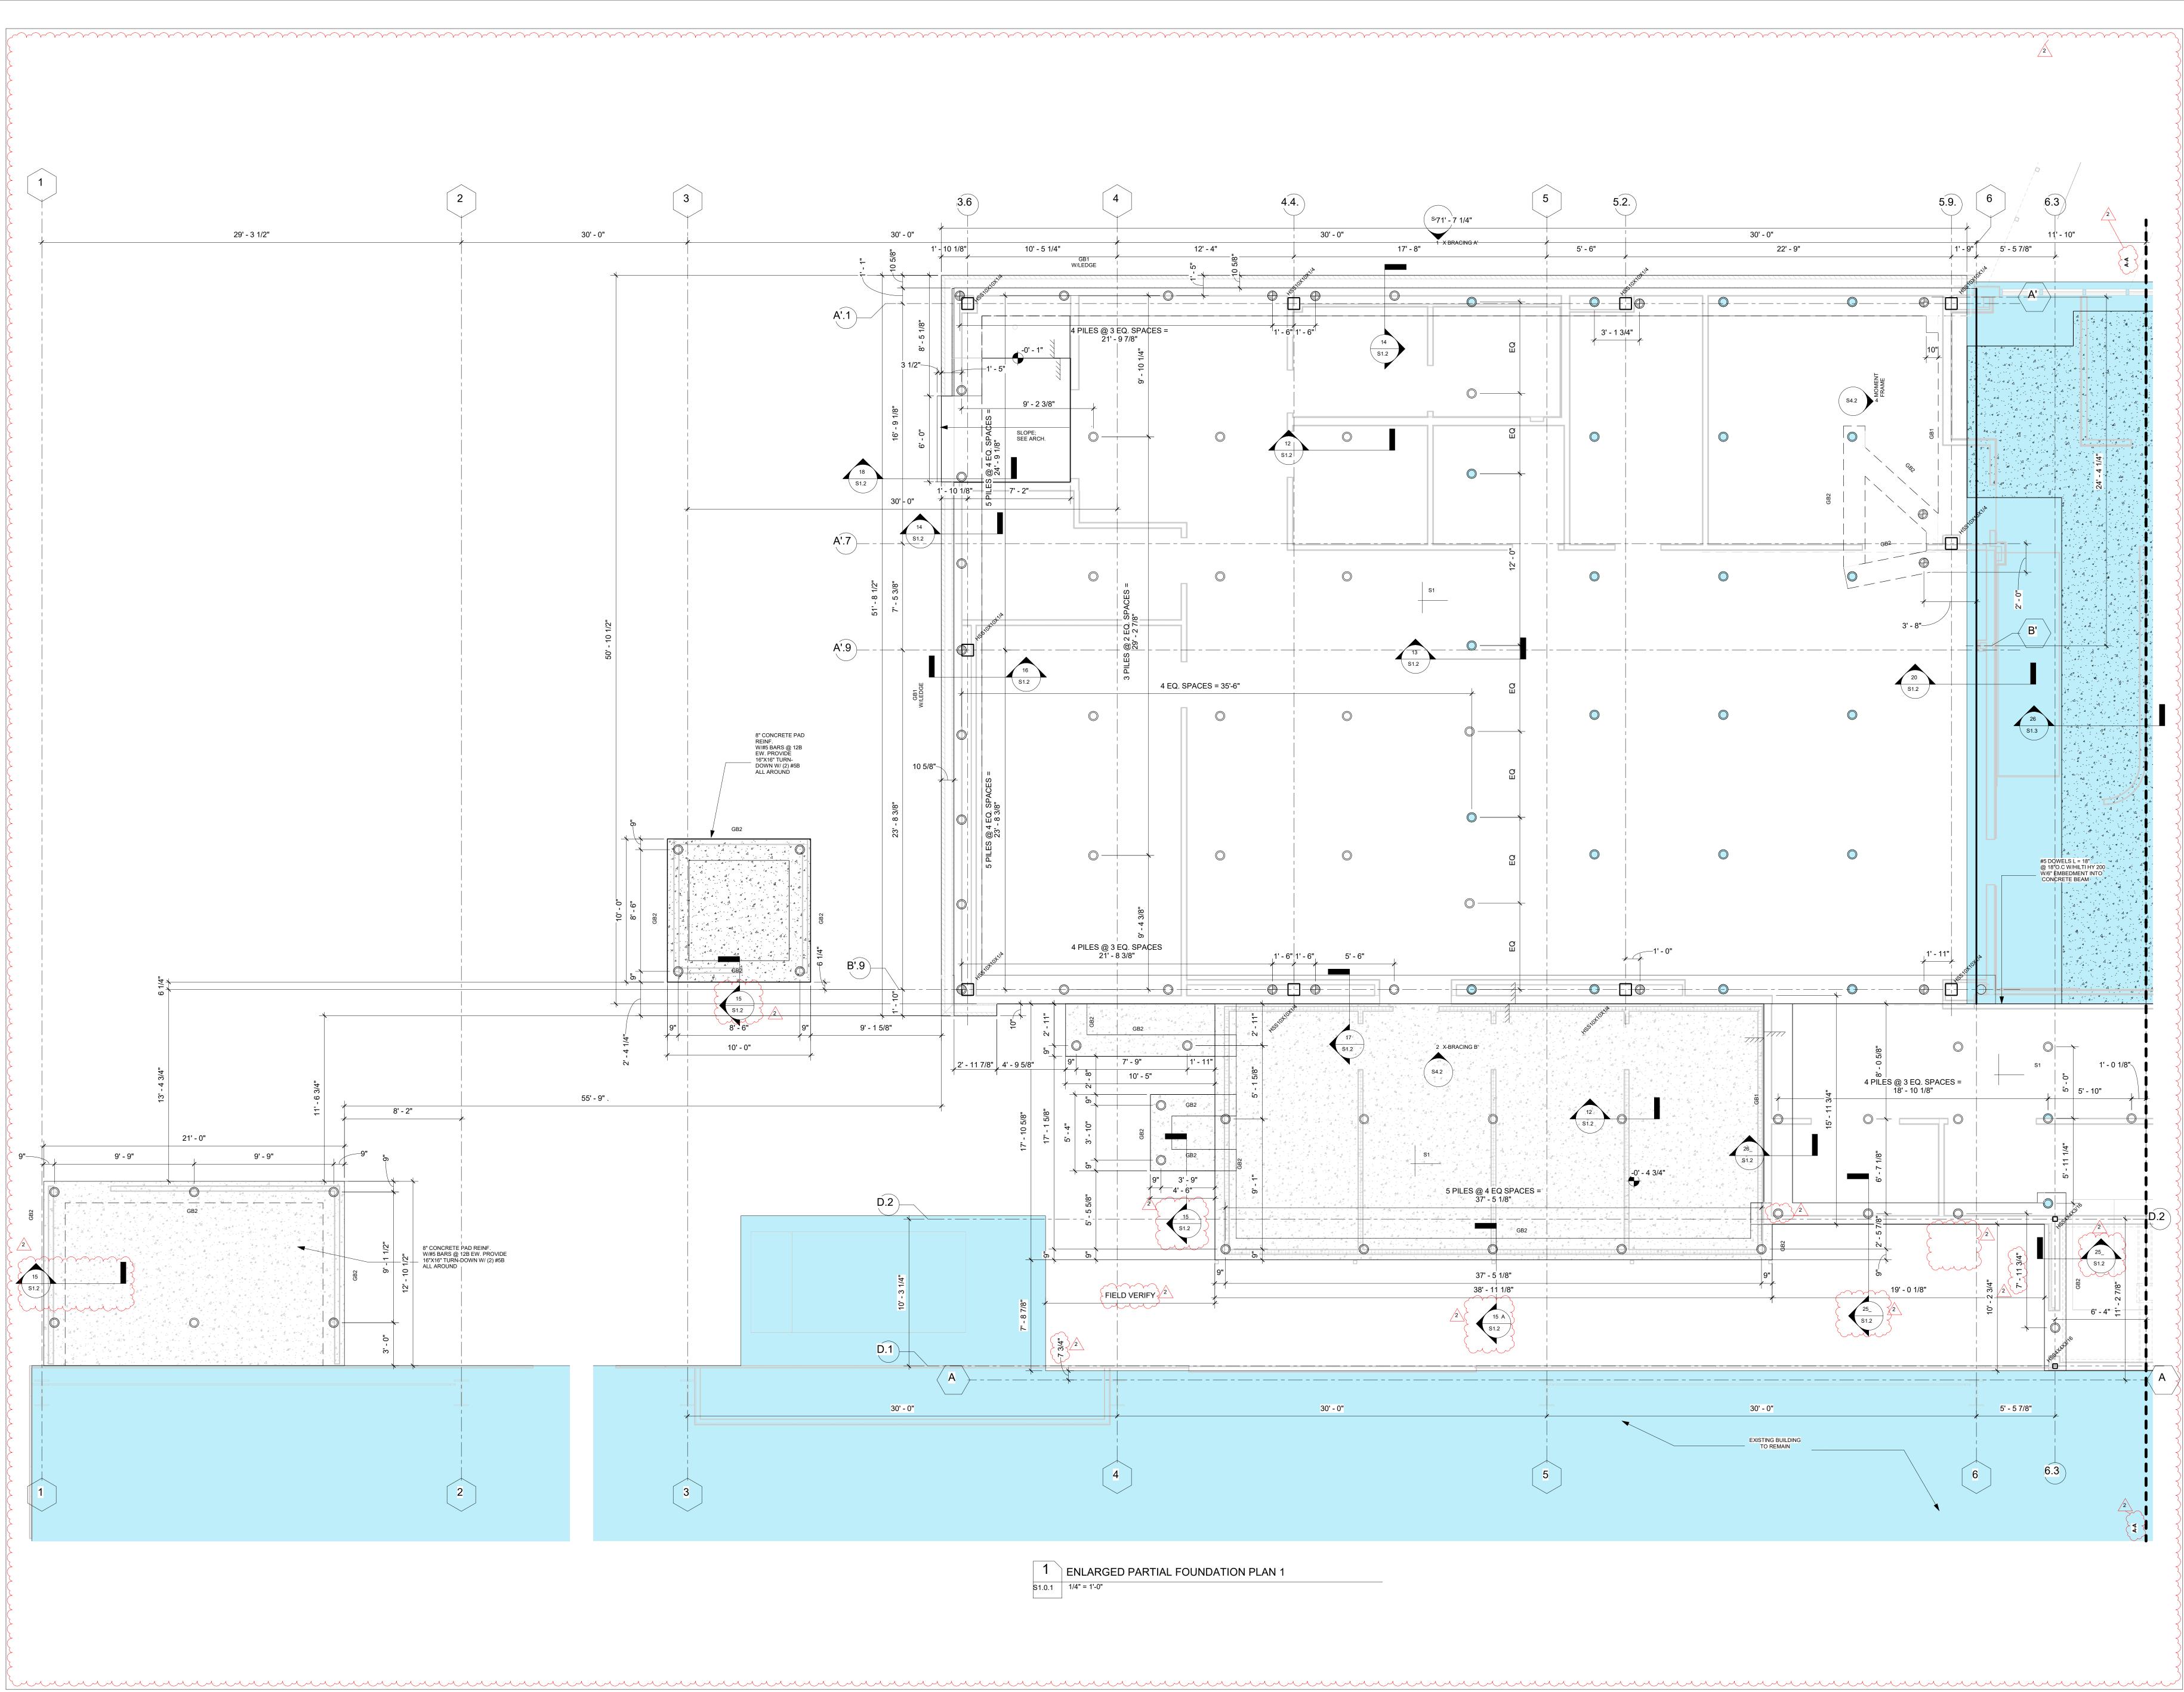


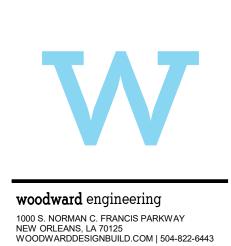
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## NEW ORLEANS SAINTS AND PELICANS CAFETERIA AND VIEWING AREA 5800 Airline Drive, Metairie, Louisiana

WDG PROJECT NO |EN230 CONSTRUCTION DOCUMENTS

REVISIONS no. date 10/23/23 10/30/23 descripton OVERALL FOUNDATION PLAN





Nicholas Mannix, PE

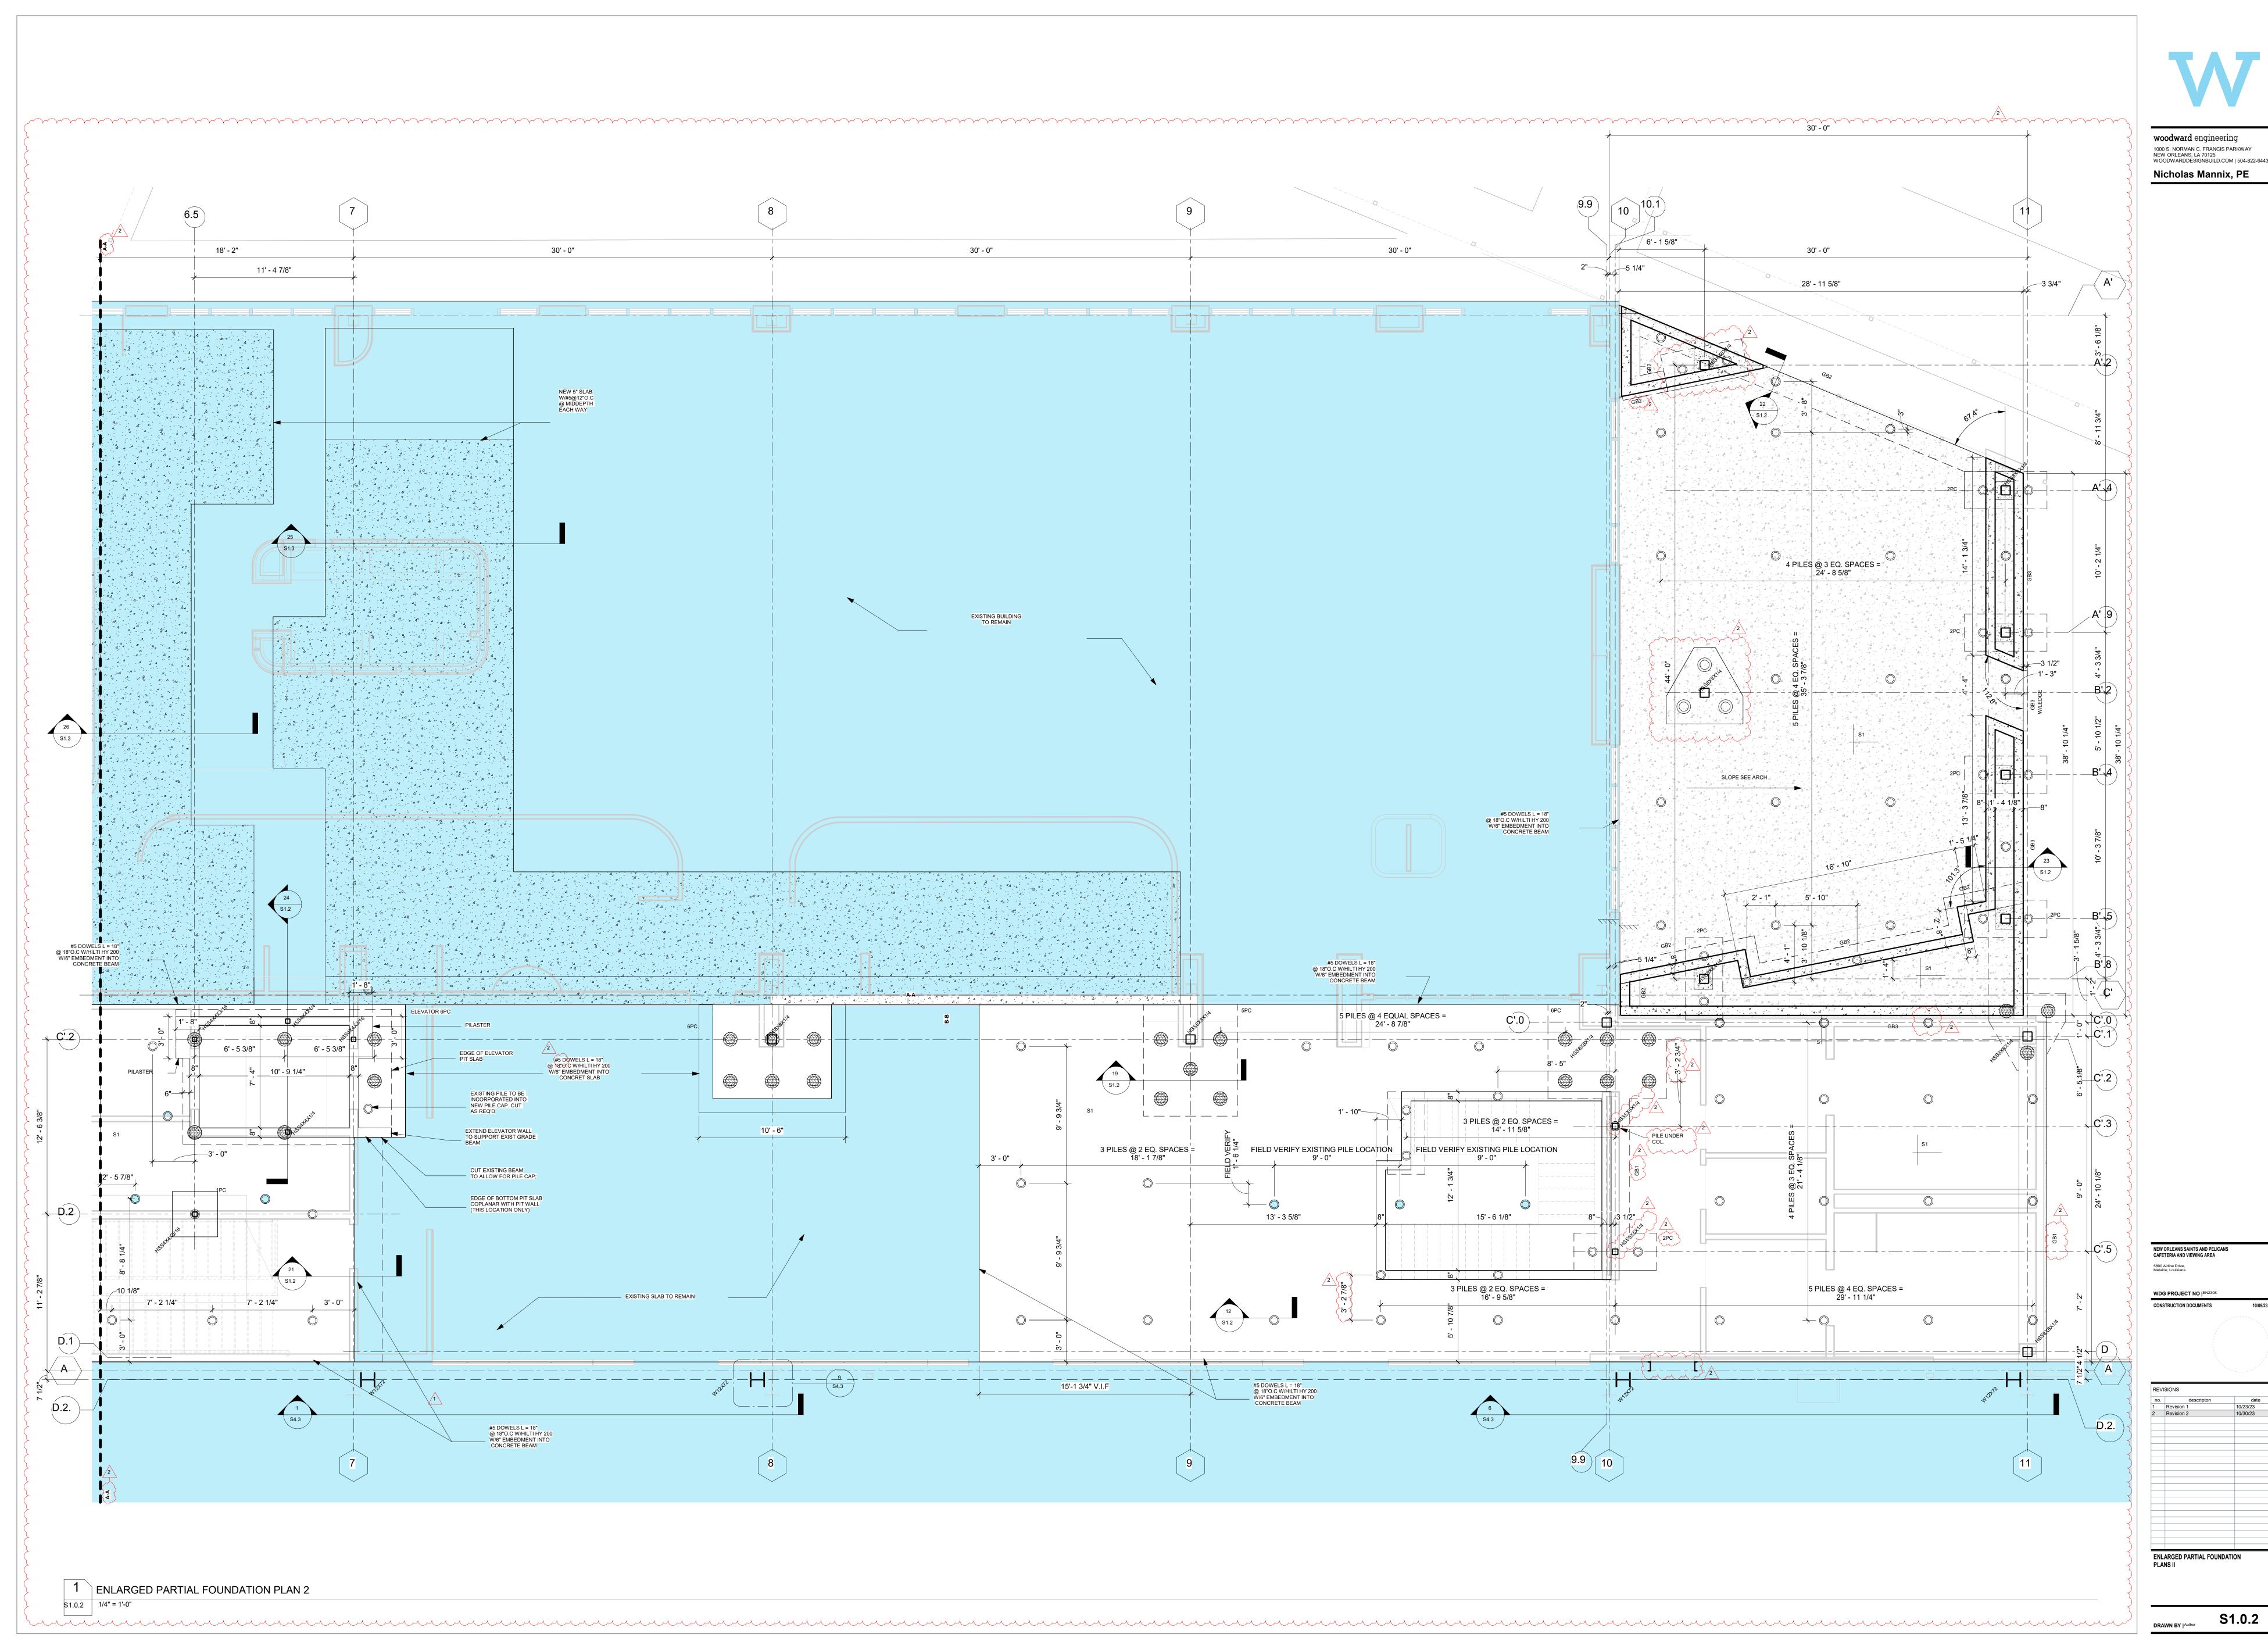
NEW ORLEANS SAINTS AND PELICANS CAFETERIA AND VIEWING AREA 5800 Airline Drive, Metairie, Louisiana

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REVISIONS

ENLARGED PARTIAL FOUNDATION PLANS I

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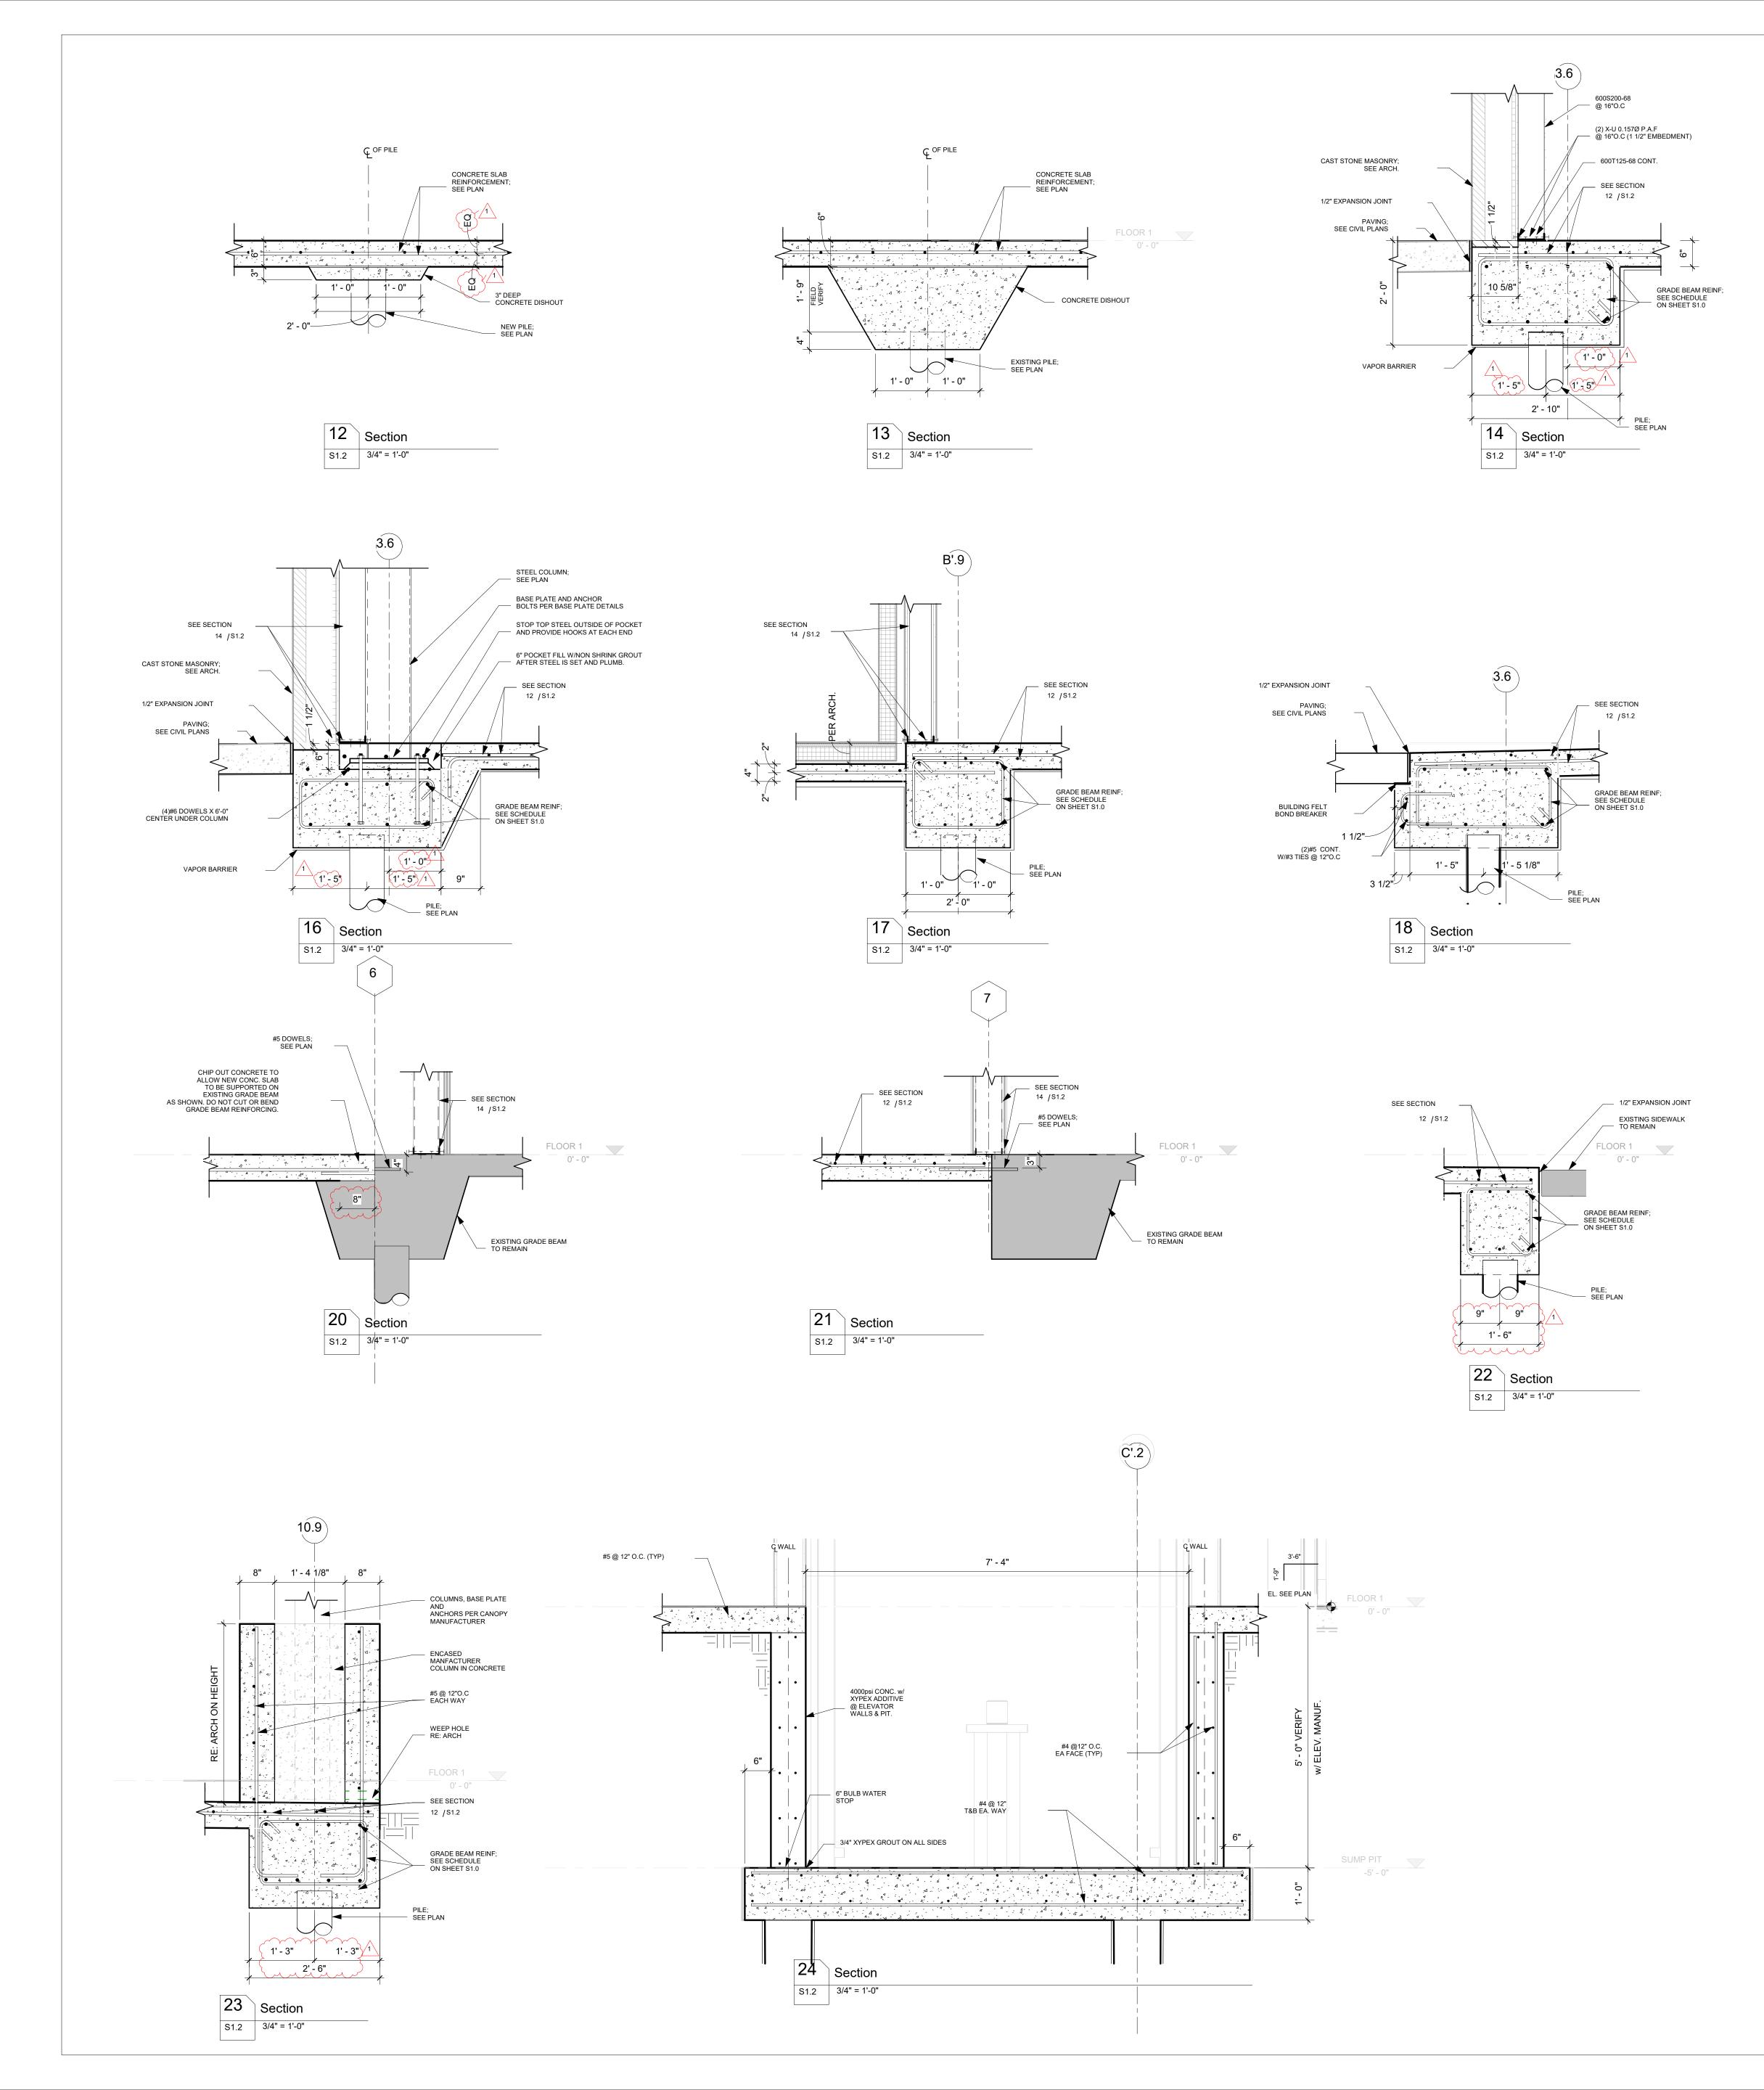
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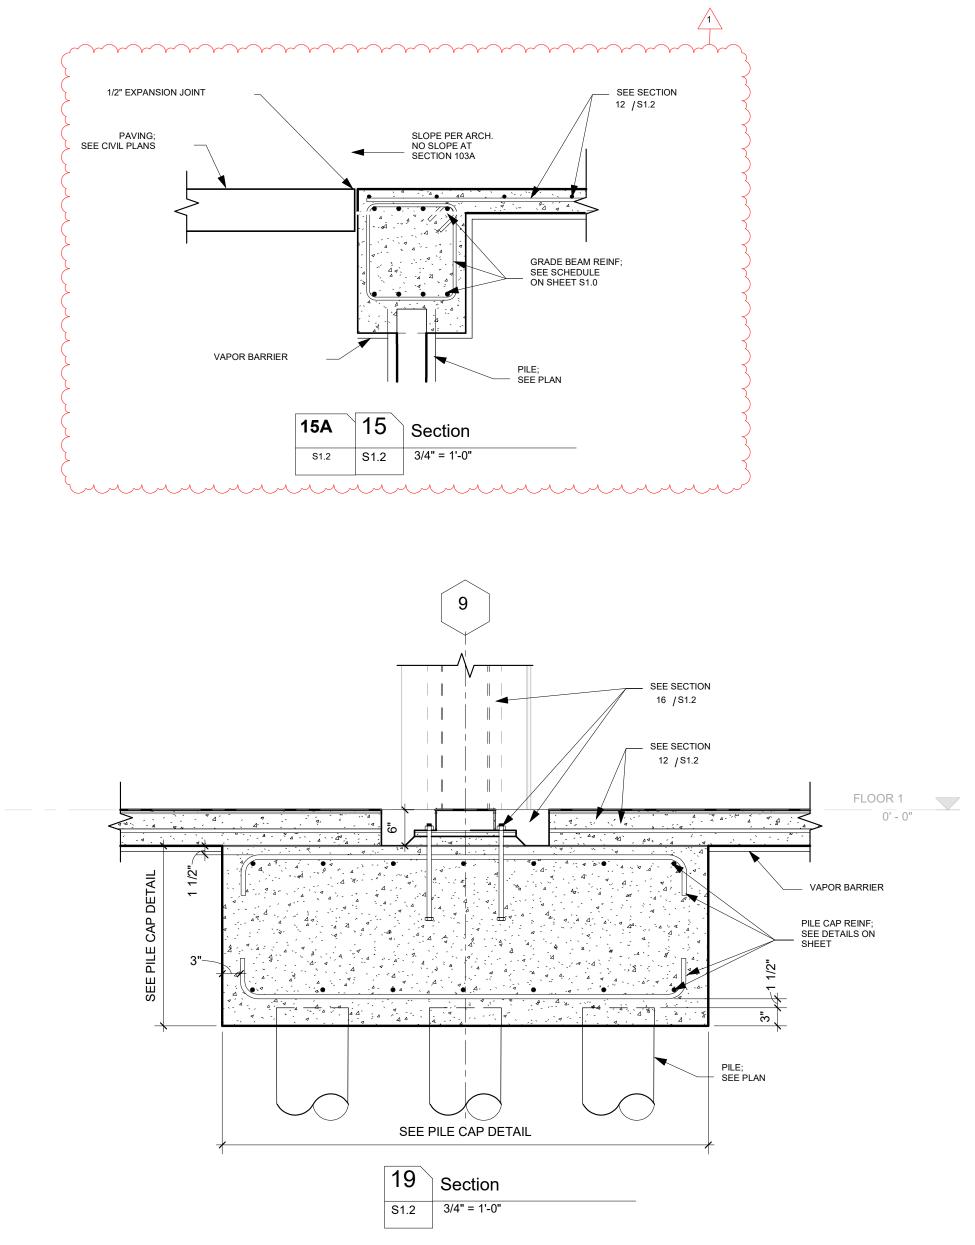
NEW ORLEANS SAINTS AND PELICANS CAFETERIA AND VIEWING AREA 5800 Airline Drive, Metairie, Louisiana

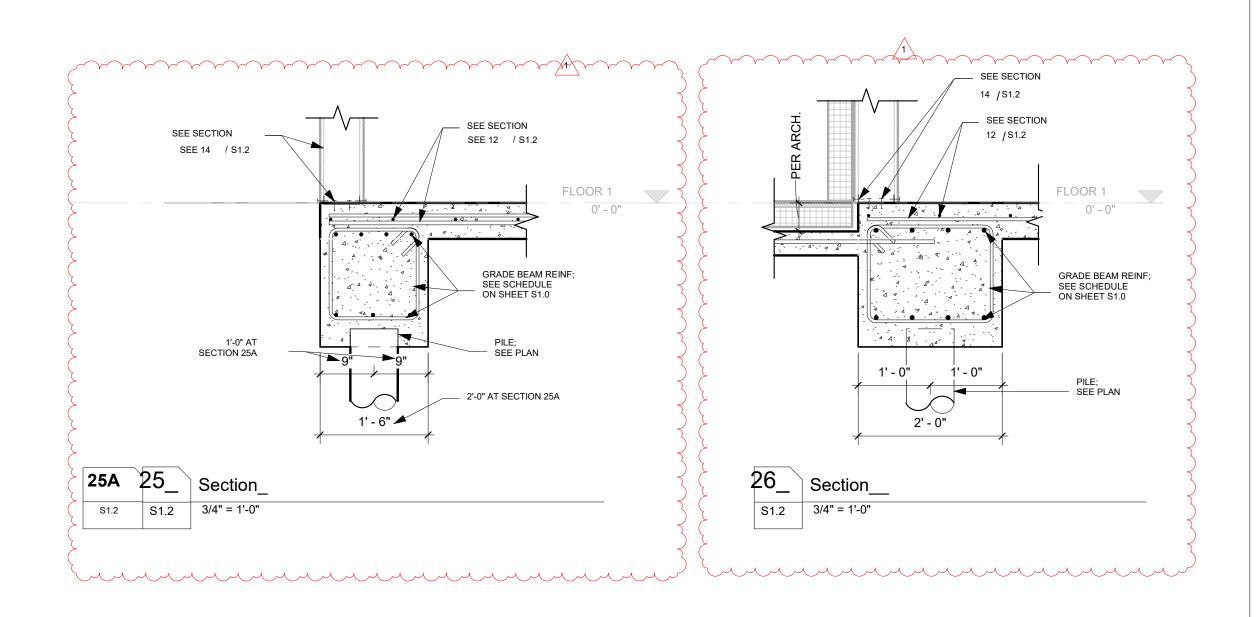
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Revision 2

WDG PROJECT NO JEN23









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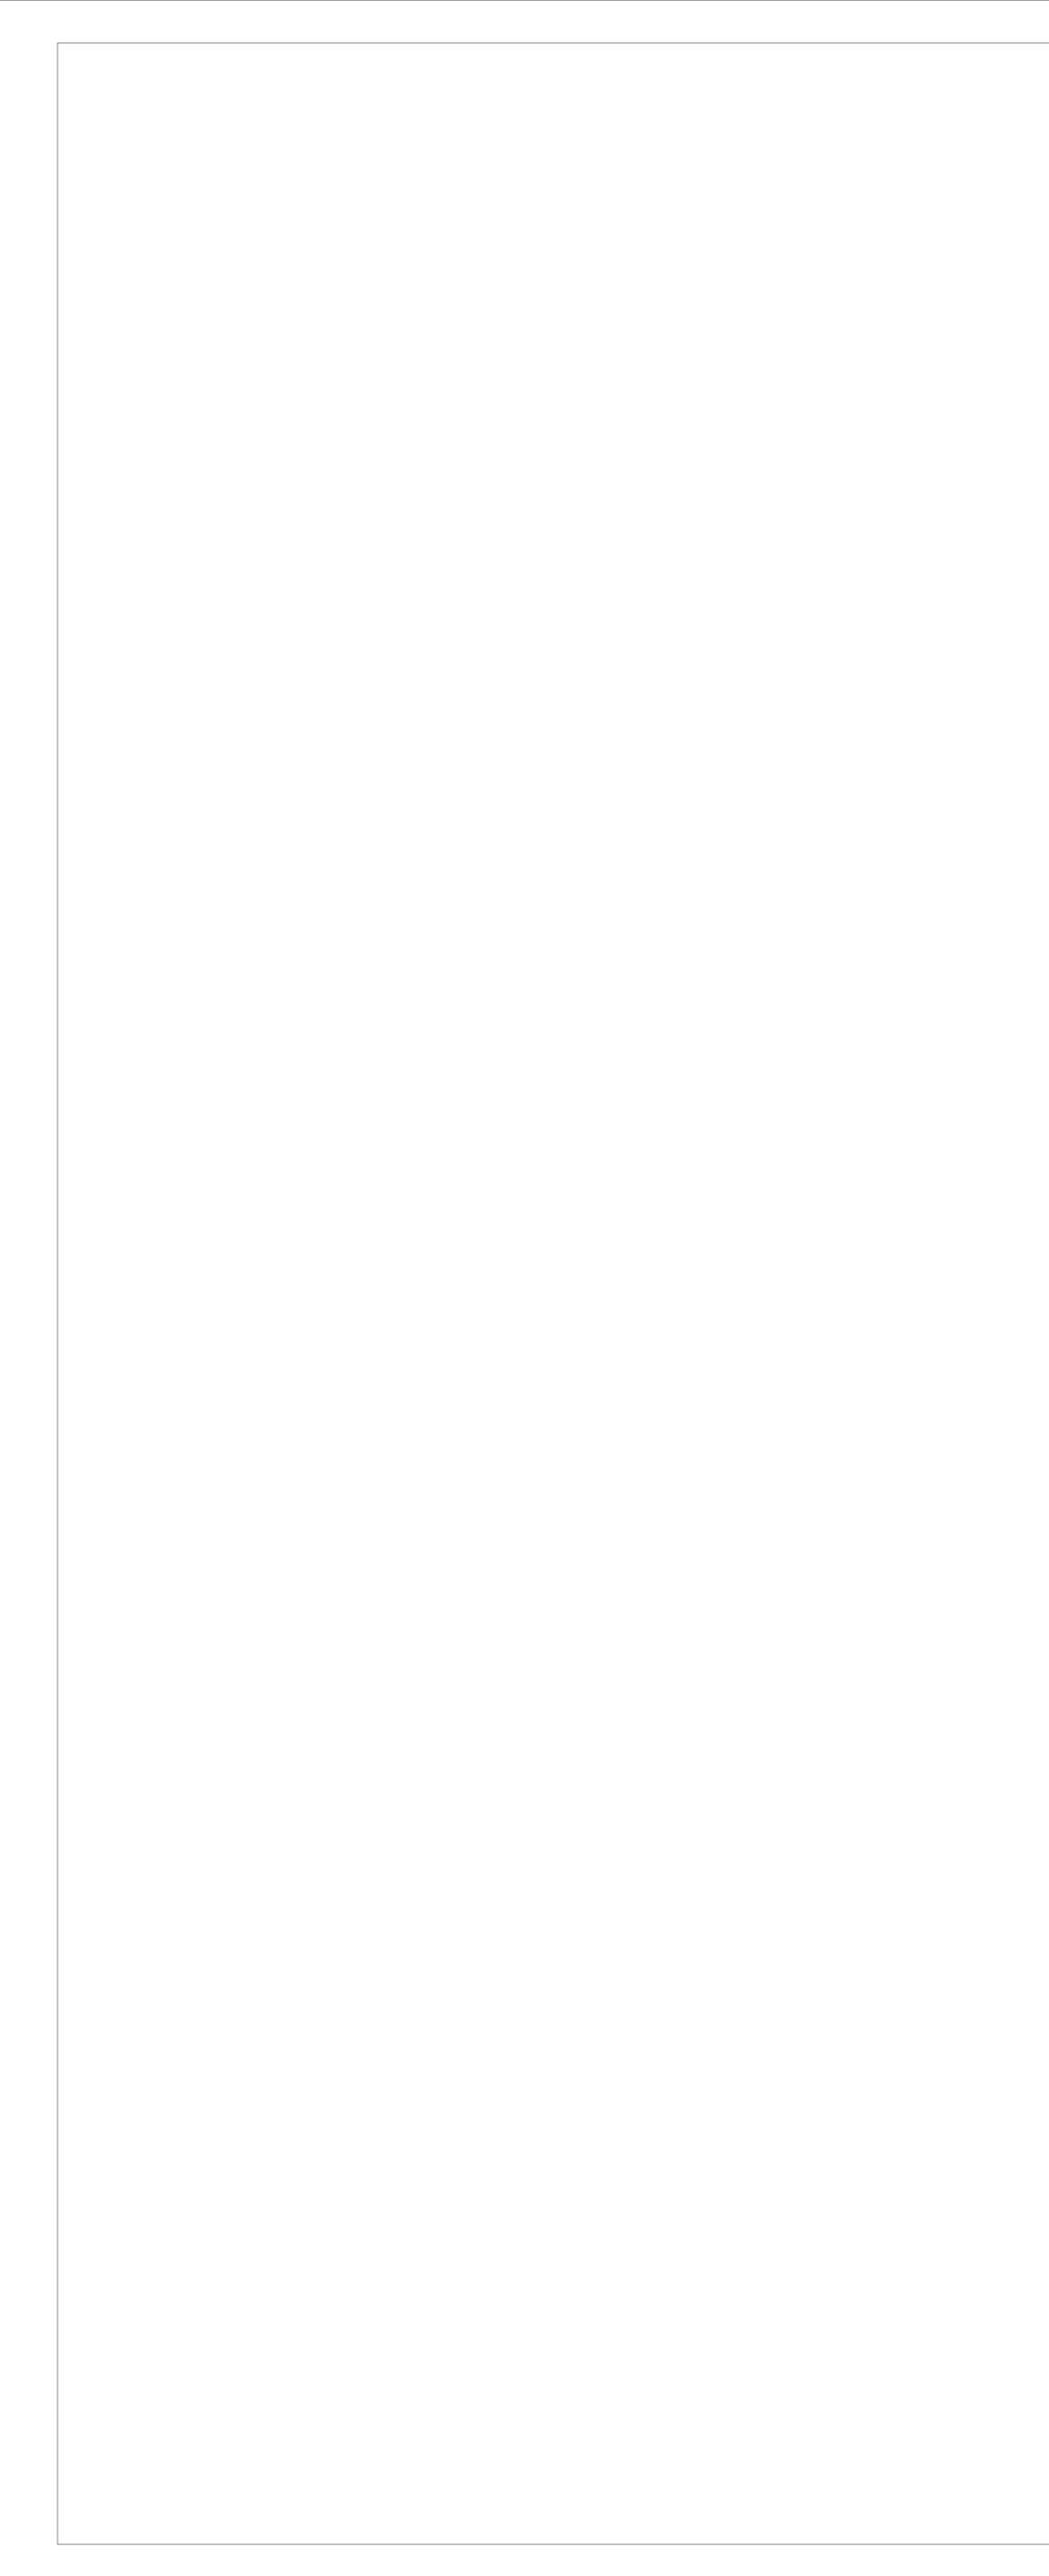
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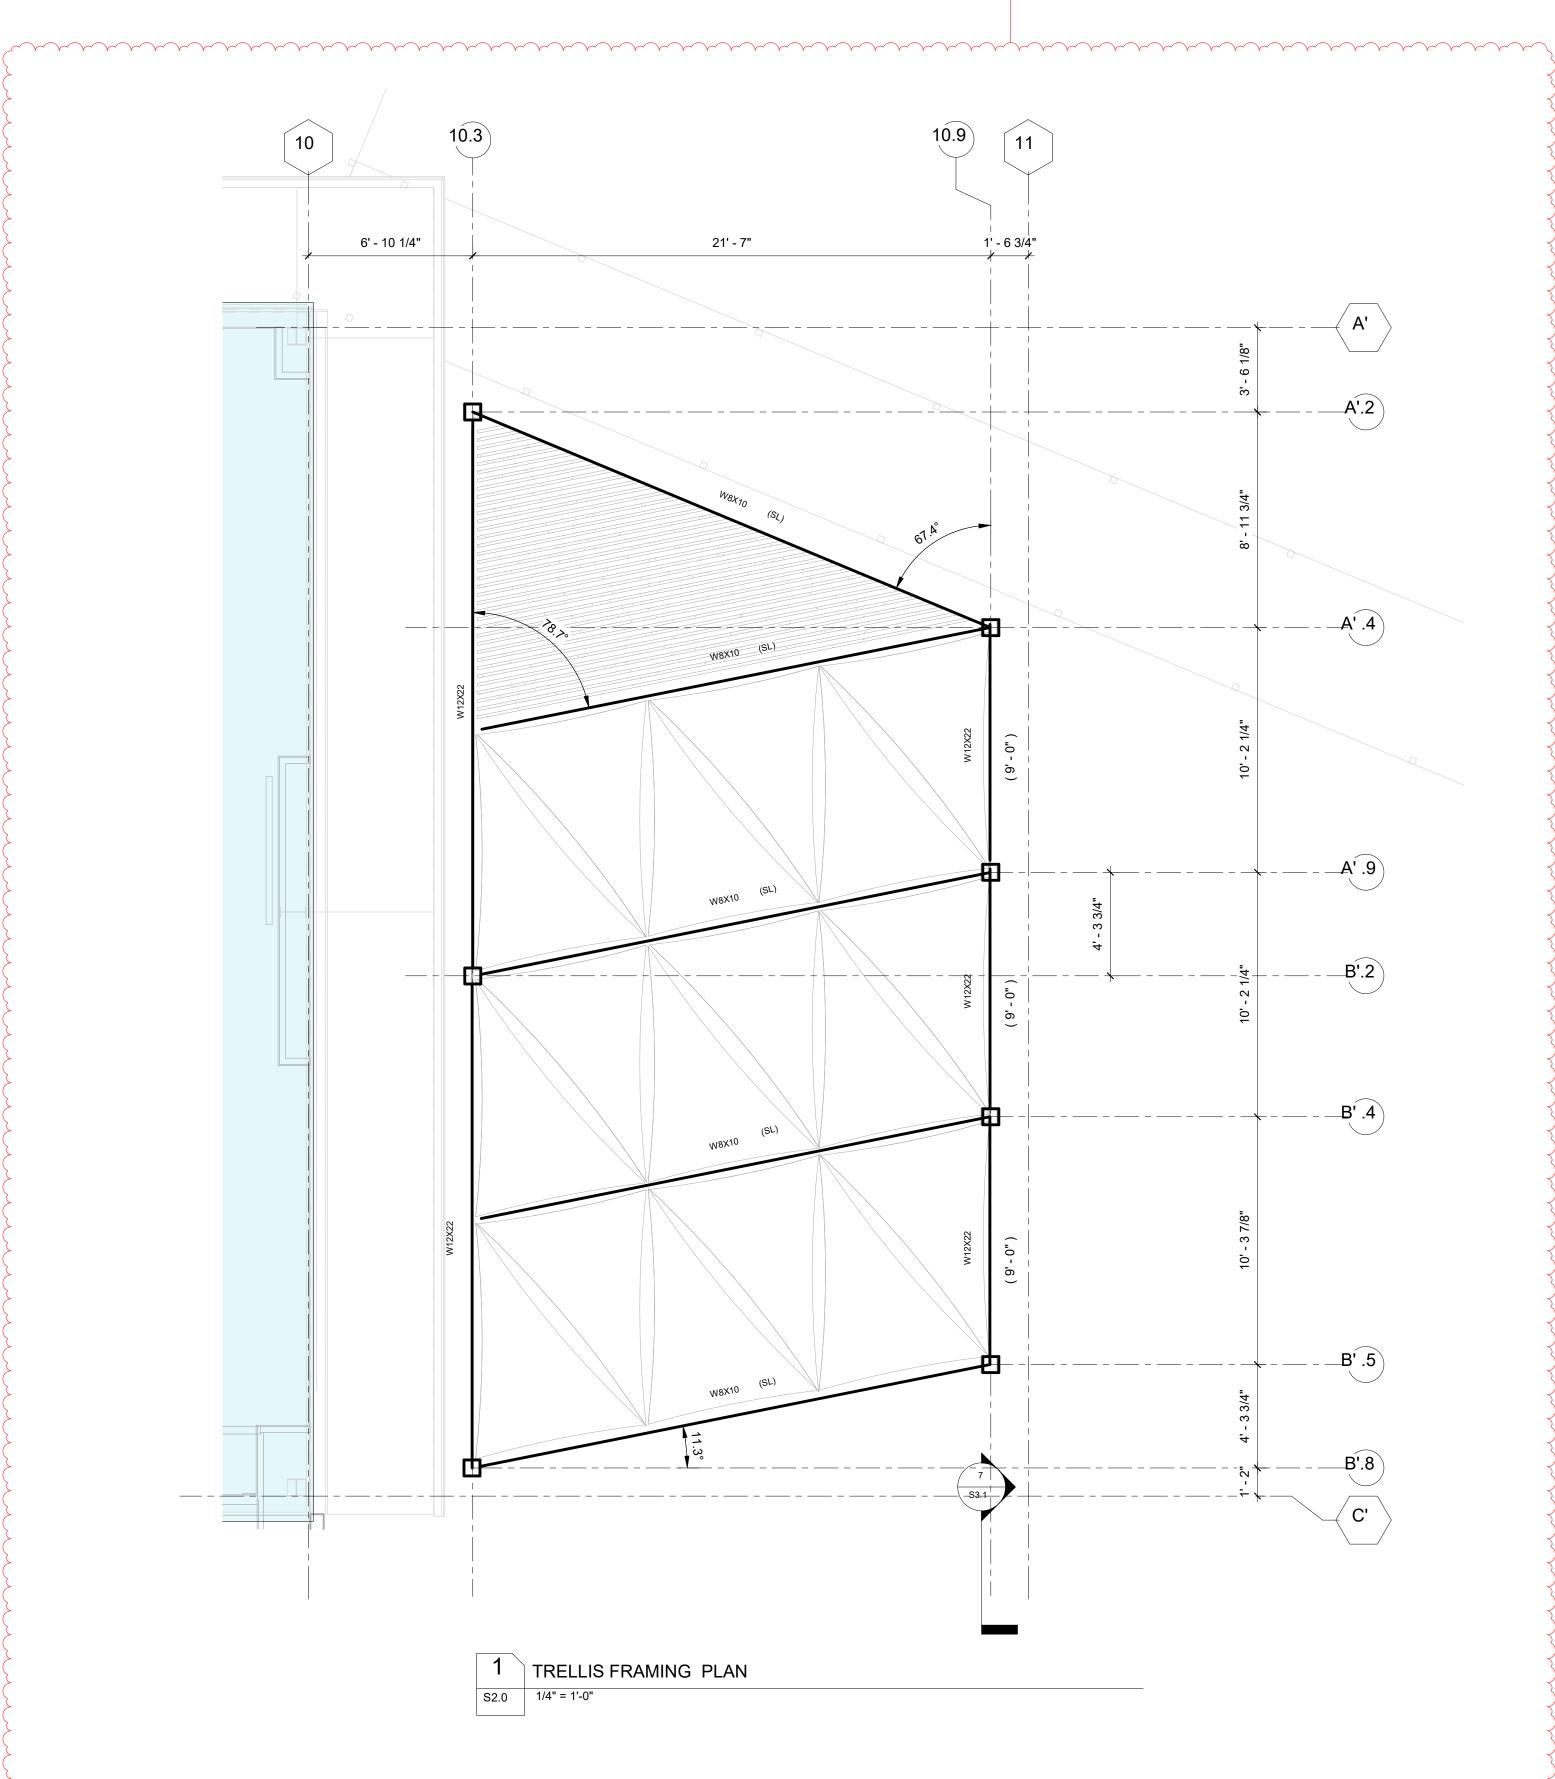
NEW ORLEANS SAINTS AND PELICANS CAFETERIA AND VIEWING AREA

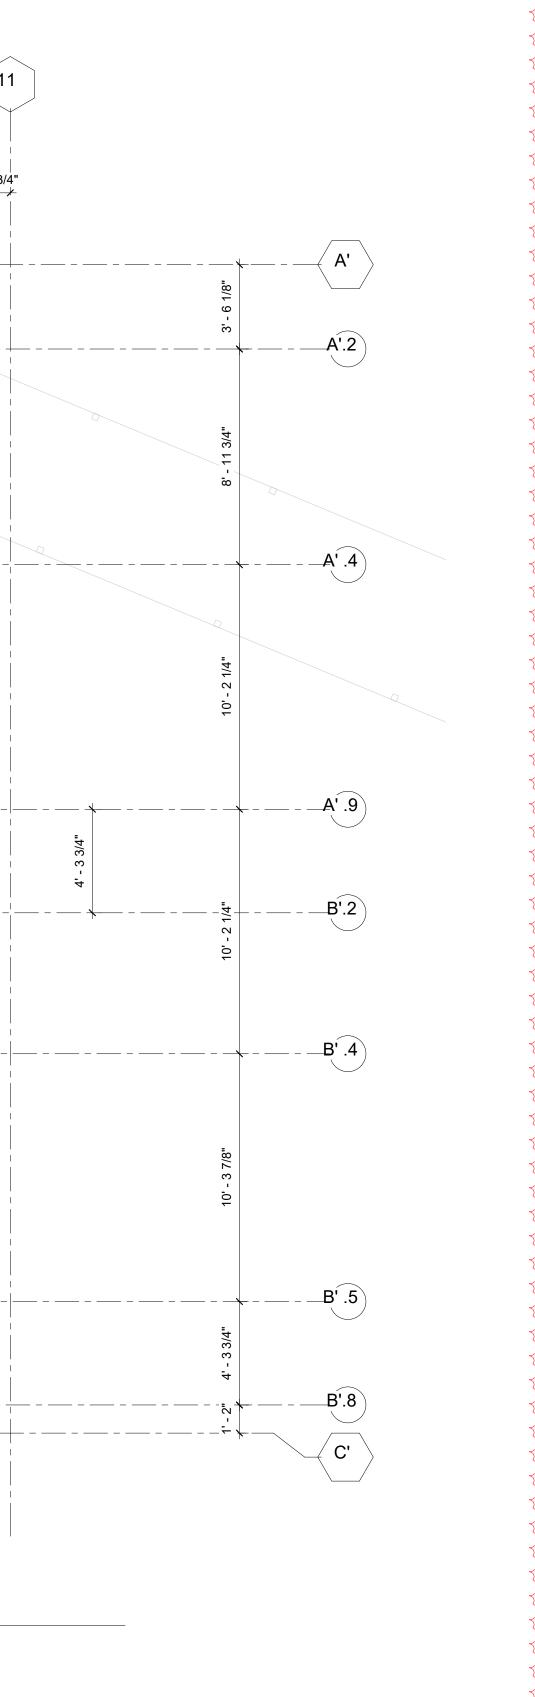
WDG PROJECT NO |EN2308

CONSTRUCTION DOCUMENTS

5800 Airline Drive, Metairie, Louisiana







TOP OF STEEL ELEVATION IS 10'-0" UNLESS NOTES THUS (X'-XX") ON PLAN FROM DATUM. SEE DRAWING S0.00 FOR GENERAL NOTES. SEE DRAWINGS S5.0 FOR TYPICAL DETAILS.

FRAMING PLAN NOTES:



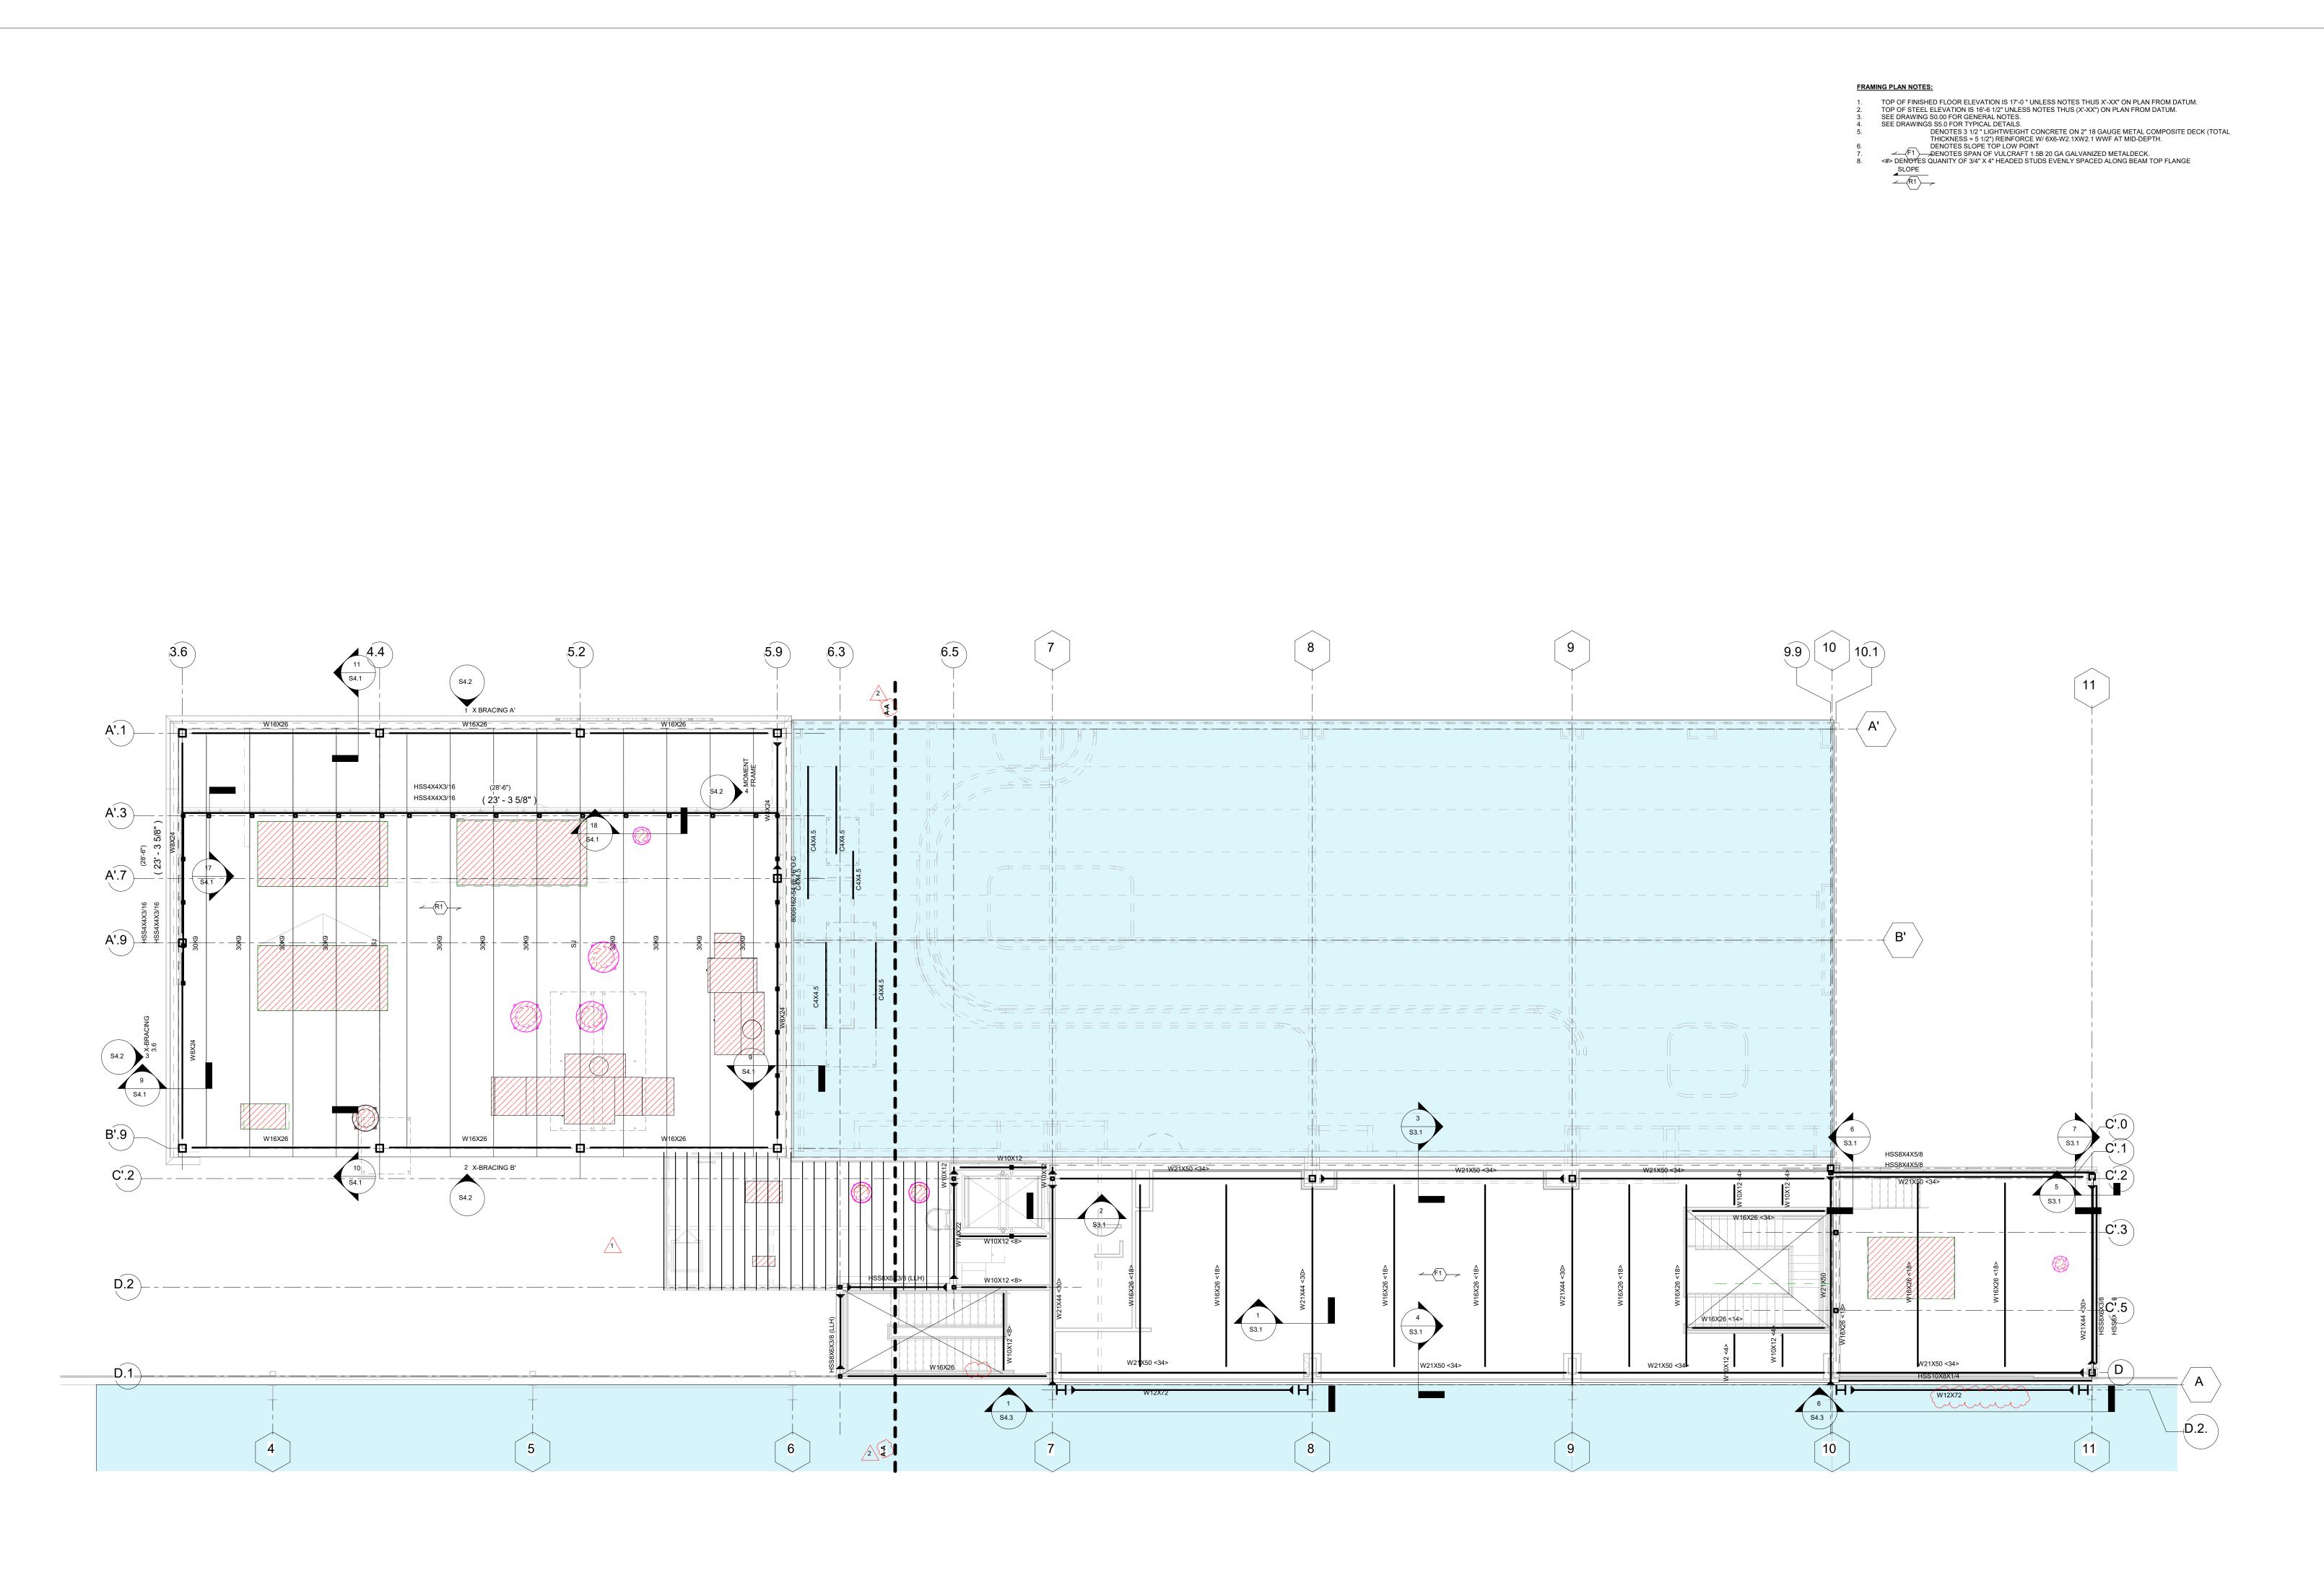
Nicholas Mannix, PE

NEW ORLEANS SAINTS AND PELICANS CAFETERIA AND VIEWING AREA 5800 Airline Drive, Metairie, Louisiana

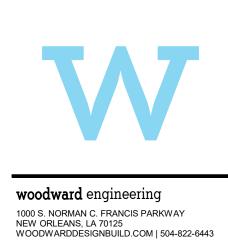
## WDG PROJECT NO |EN2308

CONSTRUCTION DOCUMENTS

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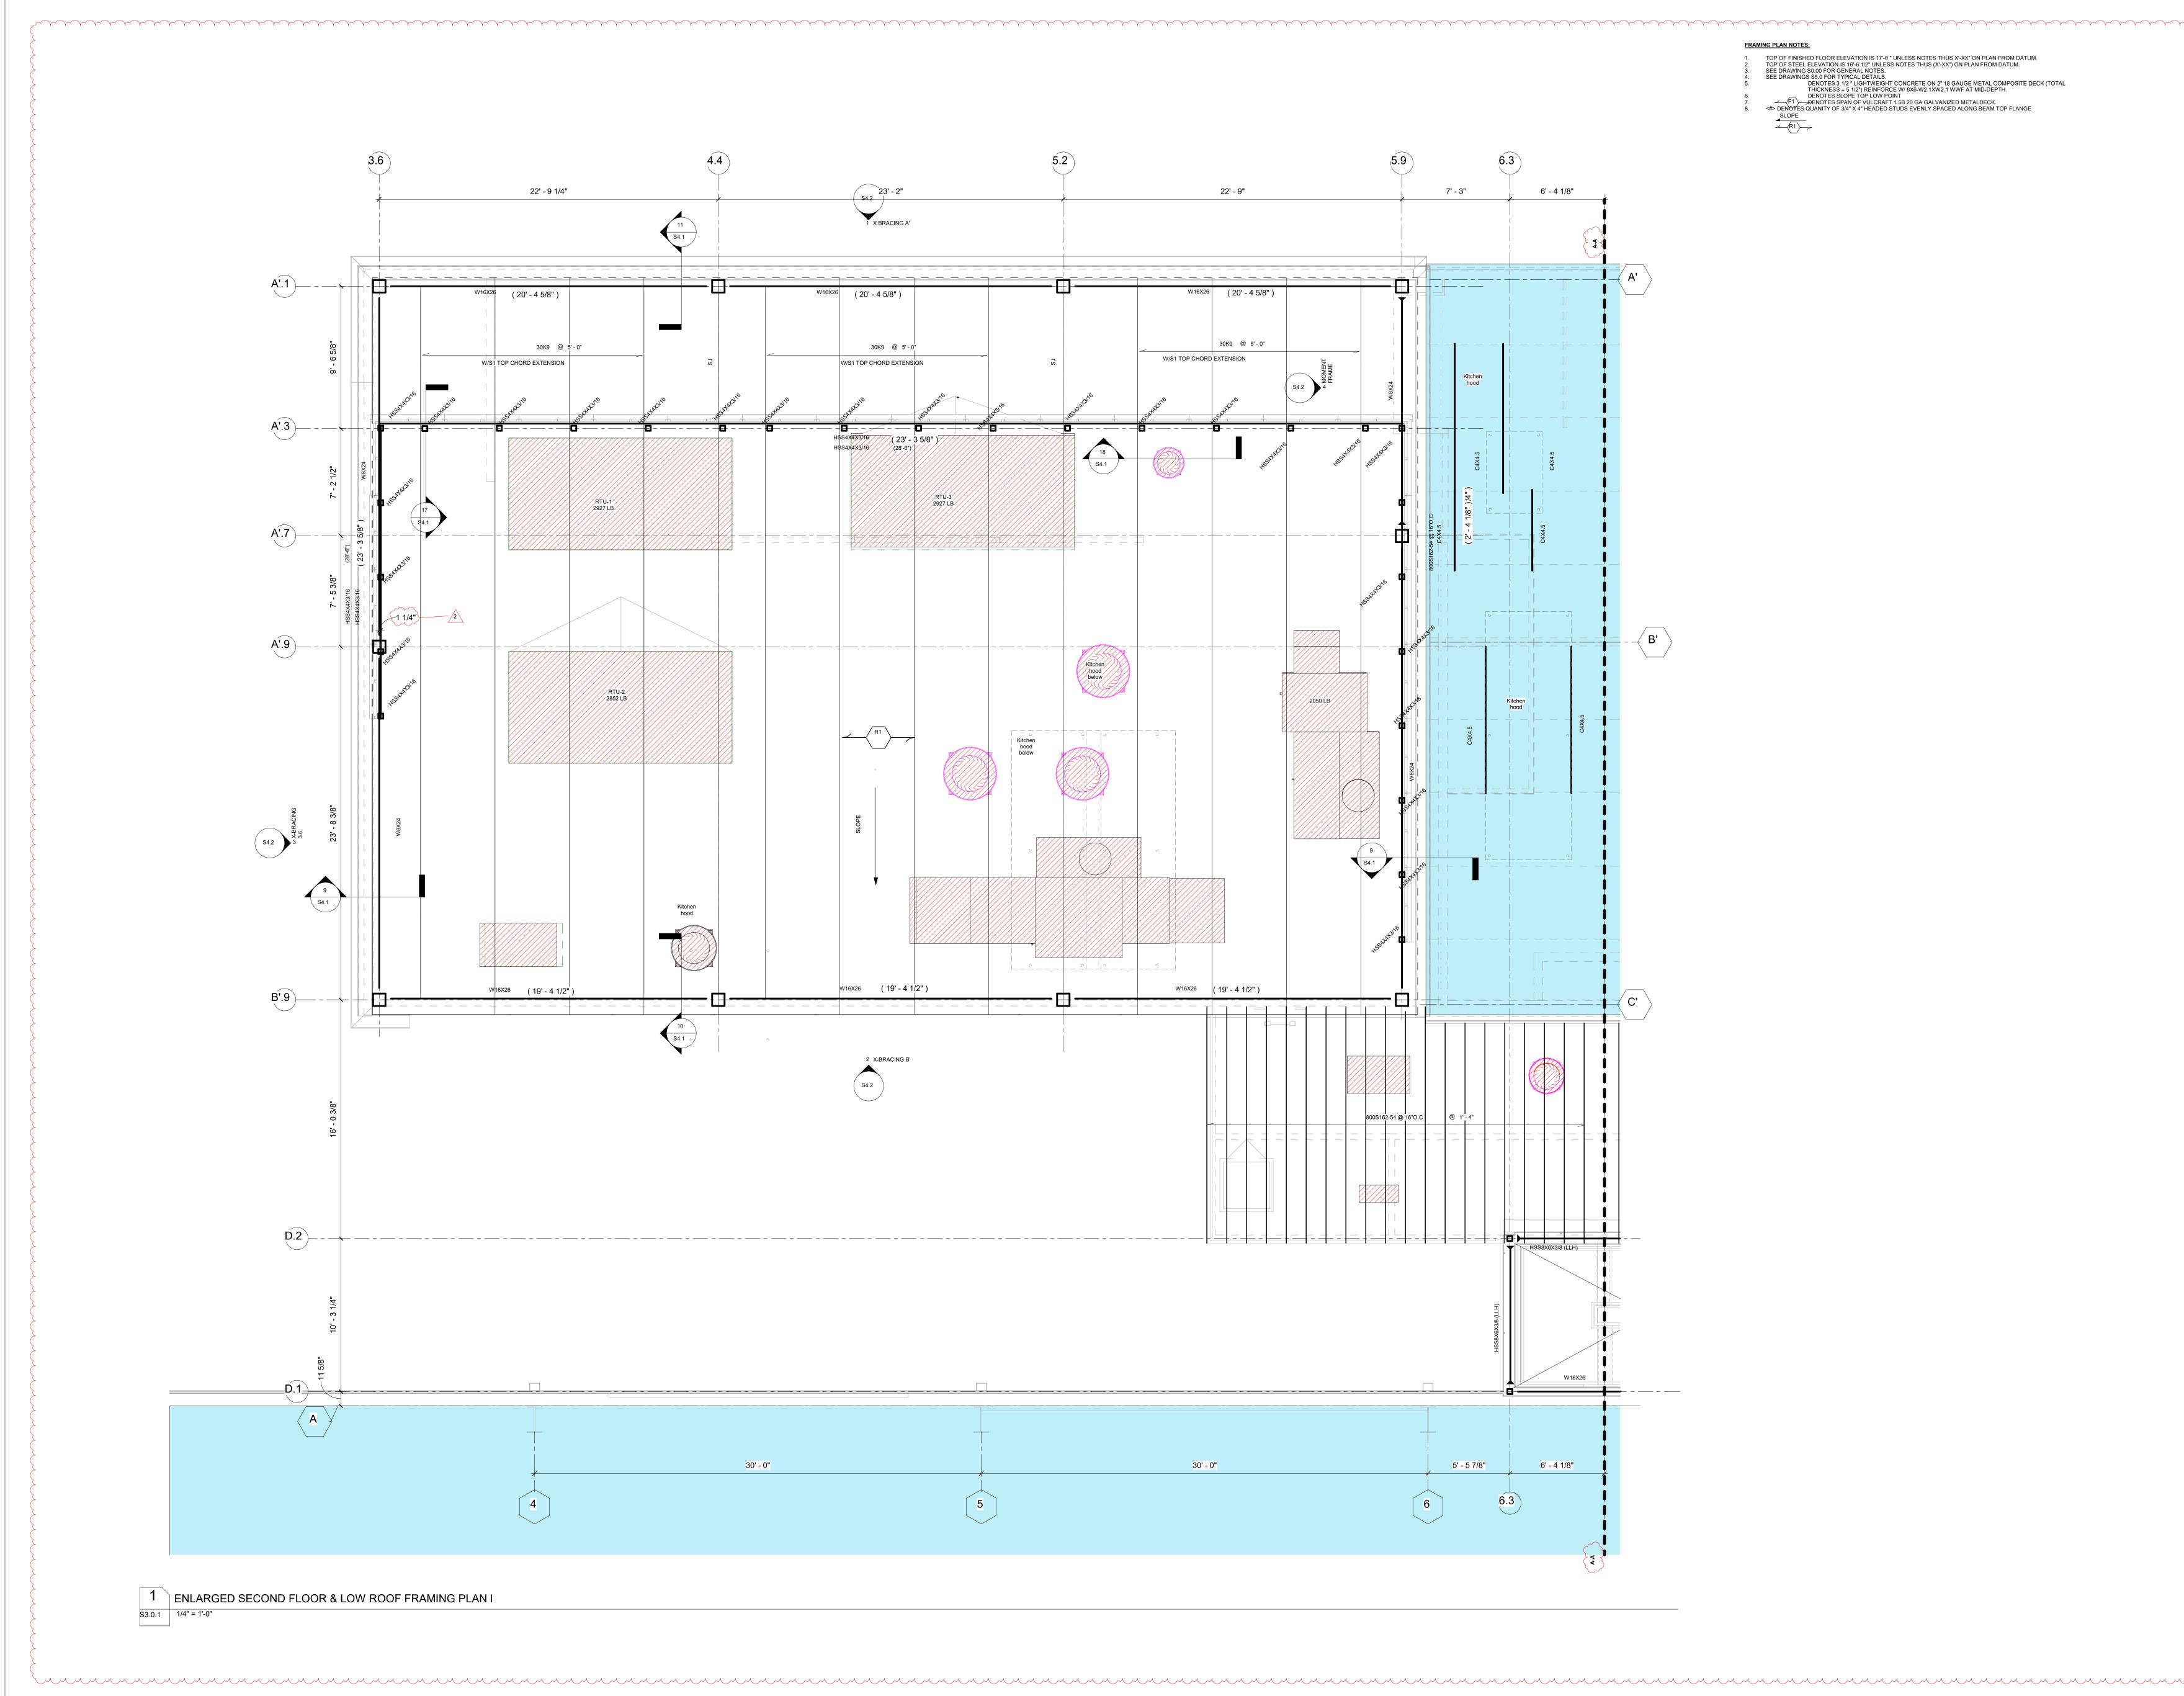
Nicholas Mannix, PE

NEW ORLEANS SAINTS AND PELICANS CAFETERIA AND VIEWING AREA 5800 Airline Drive, Metairie, Louisiana

## WDG PROJECT NO |EN2308 CONSTRUCTION DOCUMENTS

REVISIONS date 10/23/23 10/30/23 descripton OVERALL SECOND FLOOR AND LOW ROOF FRAMING PLAN

DRAWN BY |<sup>Author</sup>



FRAMING PLAN NOTES: TOP OF FINISHED FLOOR ELEVATION IS 17'-0 " UNLESS NOTES THUS X'-XX" ON PLAN FROM DATUM.
 TOP OF STEEL ELEVATION IS 16'-6 1/2" UNLESS NOTES THUS (X'-XX") ON PLAN FROM DATUM.
 SEE DRAWINGS \$5.0 FOR GENERAL NOTES.
 SEE DRAWINGS \$5.0 FOR TYPICAL DETAILS.
 DENOTES 3 1/2 " LIGHTWEIGHT CONCRETE ON 2" 18 GAUGE METAL COMPOSITE DECK (TOTAL THICKNESS = 5 1/2") REINFORCE W/ 6X6-W2.1XW2.1 WWF AT MID-DEPTH.
 DENOTES SLOPE TOP LOW POINT
 F1 DENOTES SPAN OF VULCRAFT 1.5B 20 GA GALVANIZED METALDECK.
 #> DENOTES QUANITY OF 3/4" X 4" HEADED STUDS EVENLY SPACED ALONG BEAM TOP FLANGE
 SLOPE
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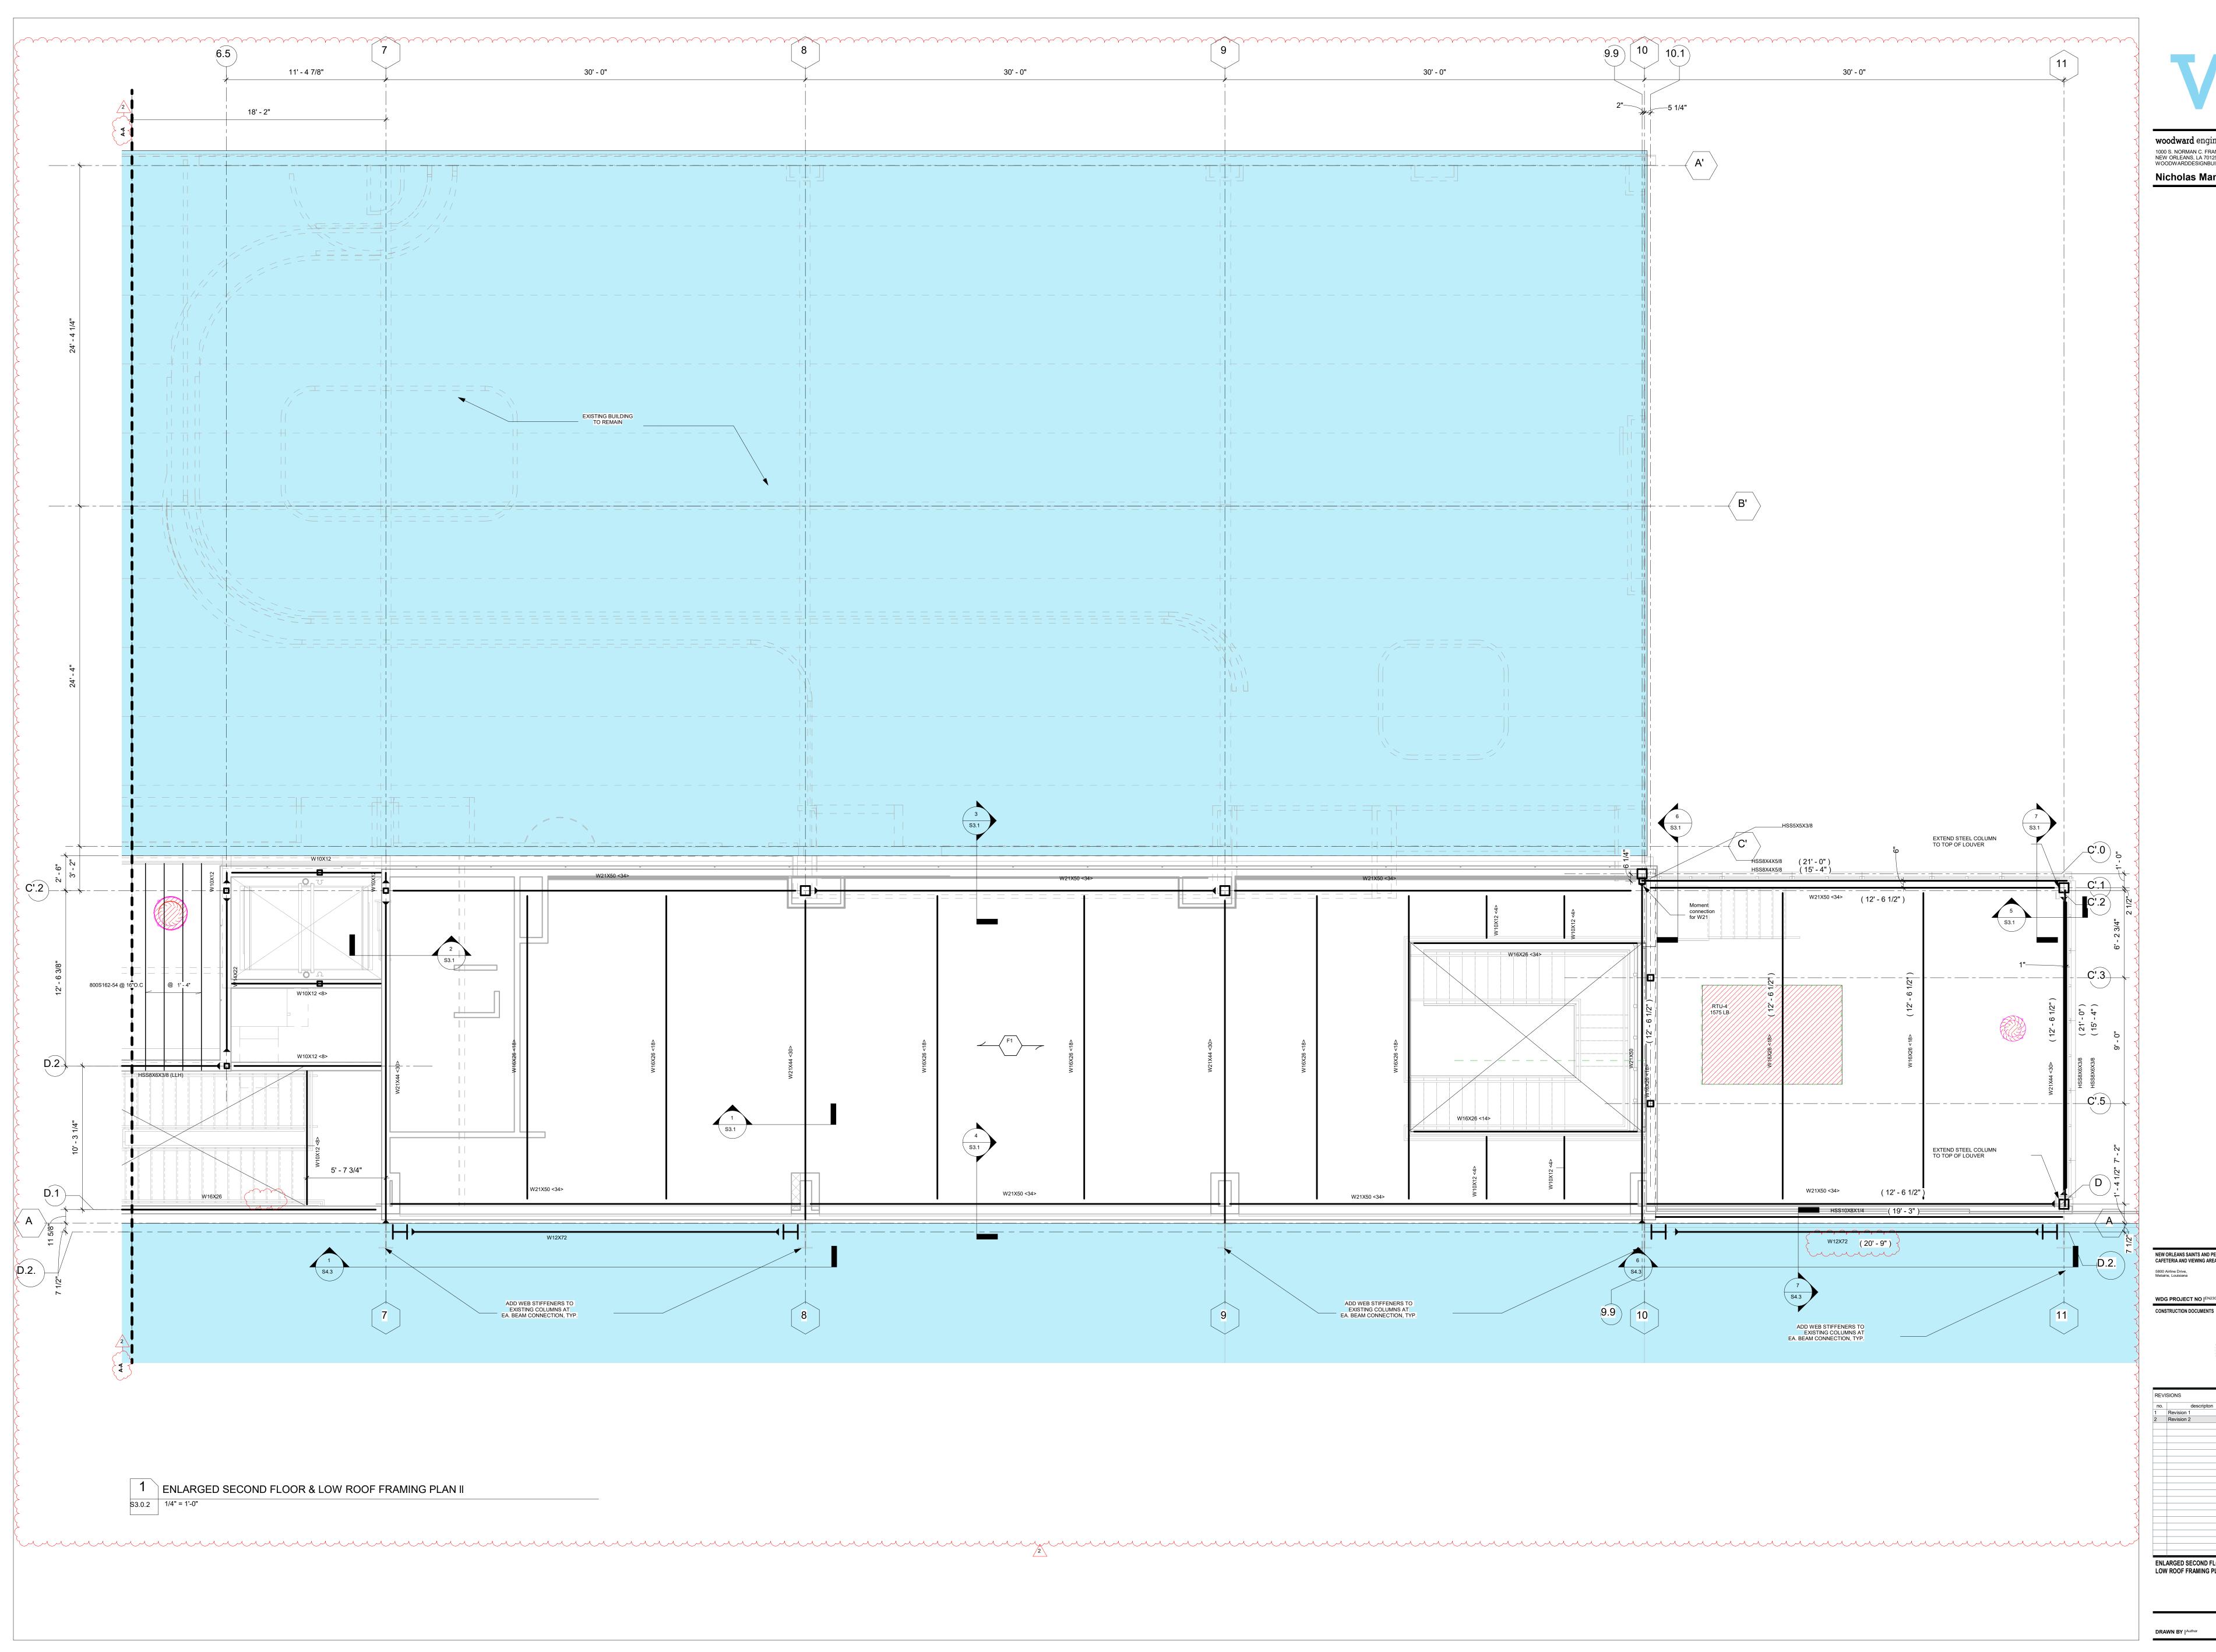
woodward engineering 1000 S. NORMAN C. FRANCIS PARKWAY NEW ORLEANS, LA 70125 WOODWARDDESIGNBUILD.COM | 504-822-6443 Nicholas Mannix, PE

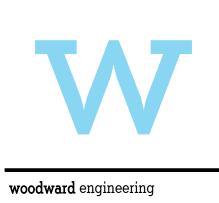
NEW ORLEANS SAINTS AND PELICANS CAFETERIA AND VIEWING AREA 5800 Airline Drive, Metairie, Louisiana

WDG PROJECT NO |EN230 CONSTRUCTION DOCUMENTS

REVISIONS ENLARGED SECOND FLOOR AND LOW ROOF FRAMING PLAN I

DRAWN BY JAuthor S3.0.1





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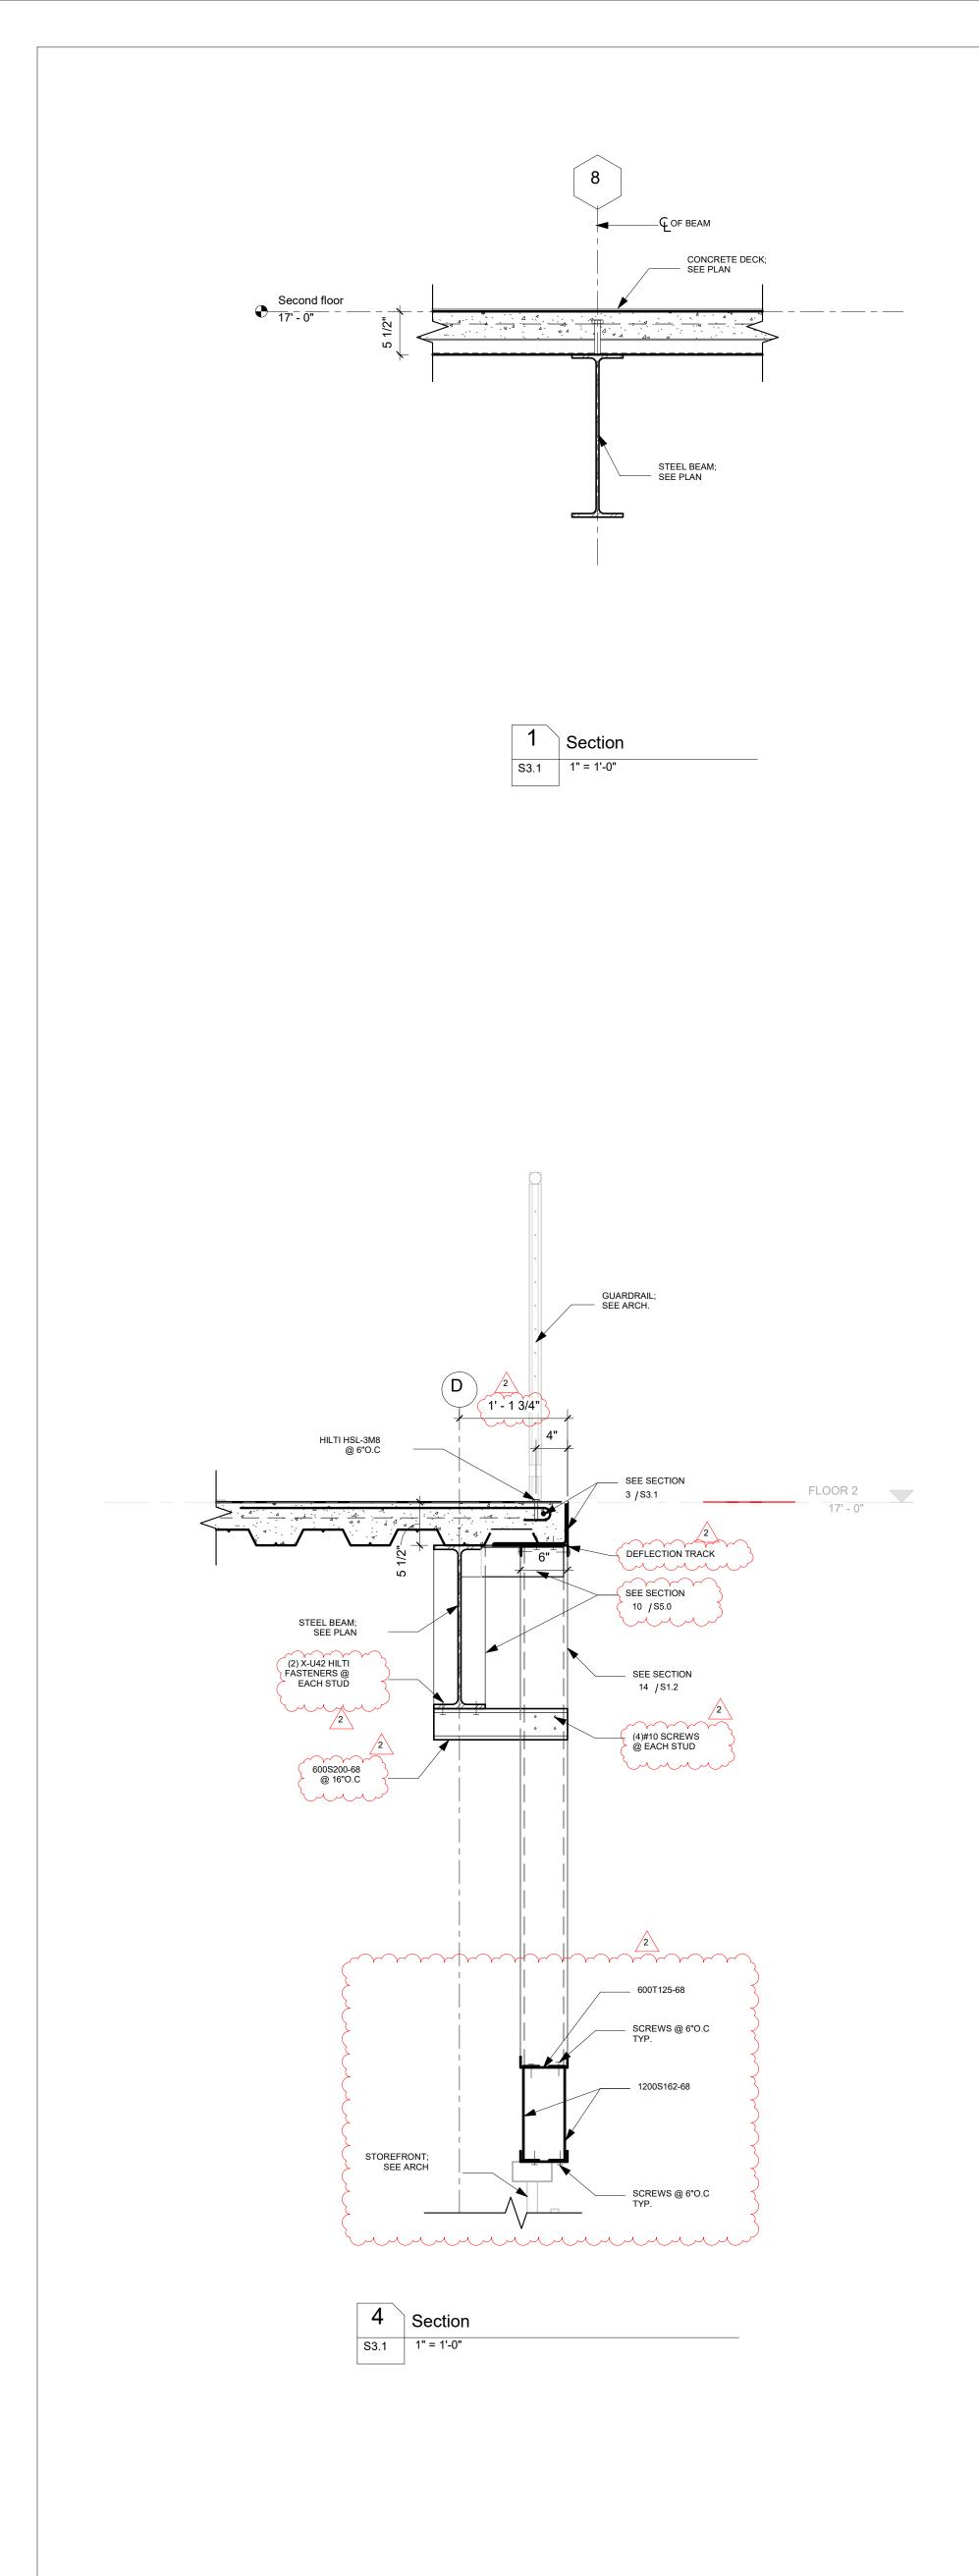
NEW ORLEANS SAINTS AND PELICANS CAFETERIA AND VIEWING AREA 5800 Airline Drive, Metairie, Louisiana

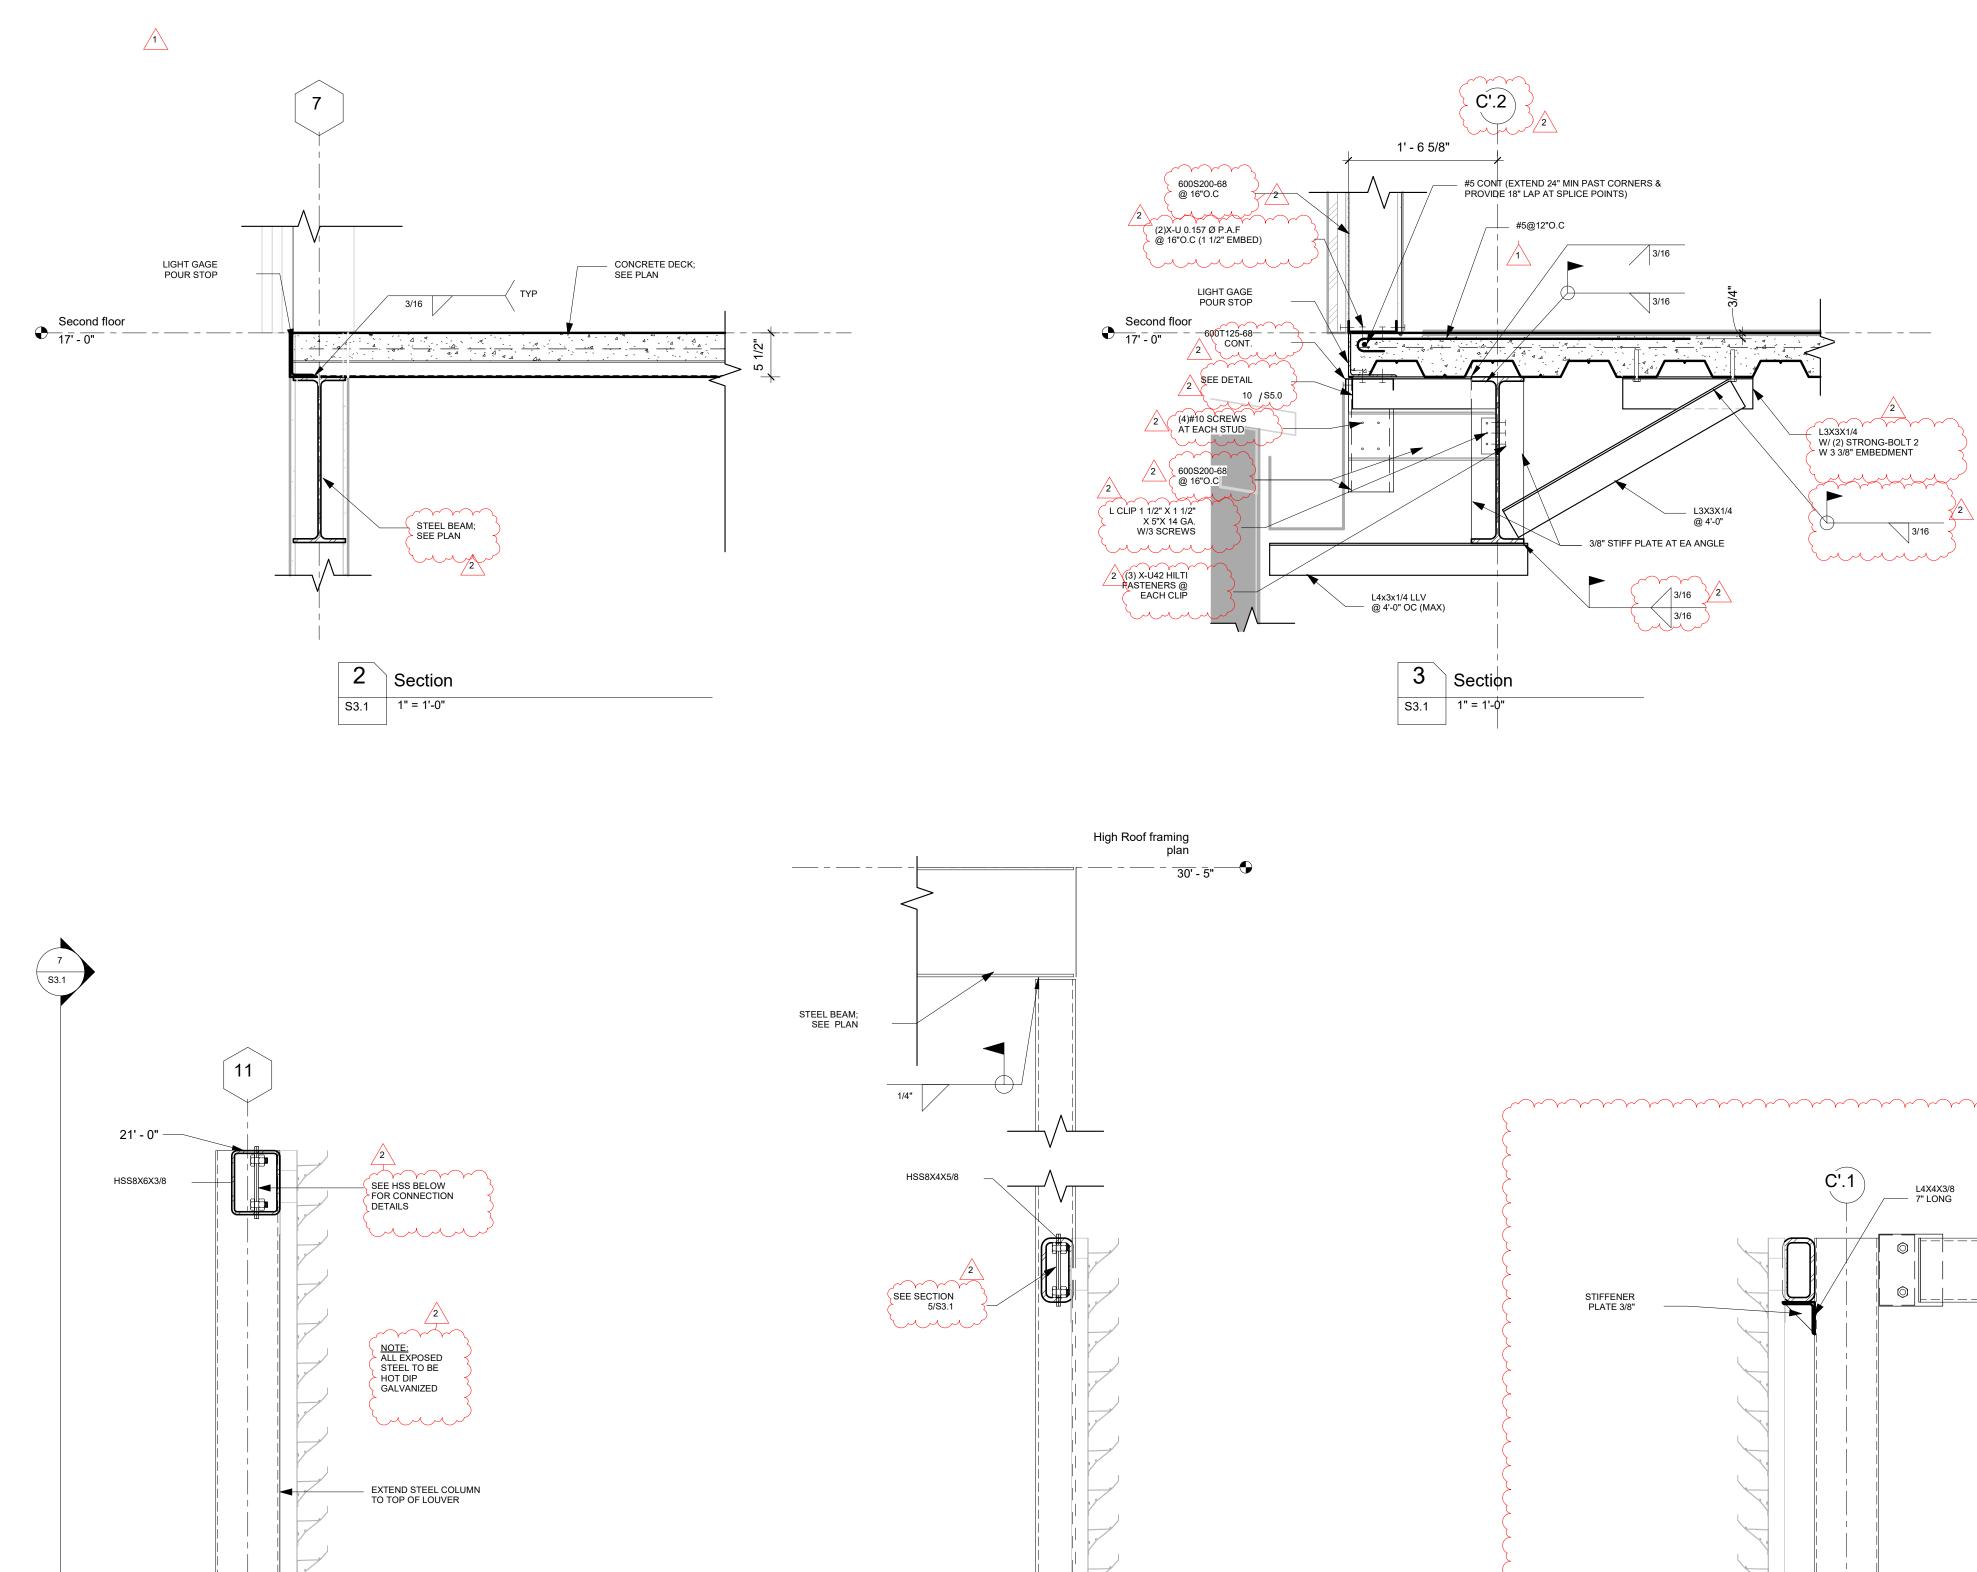
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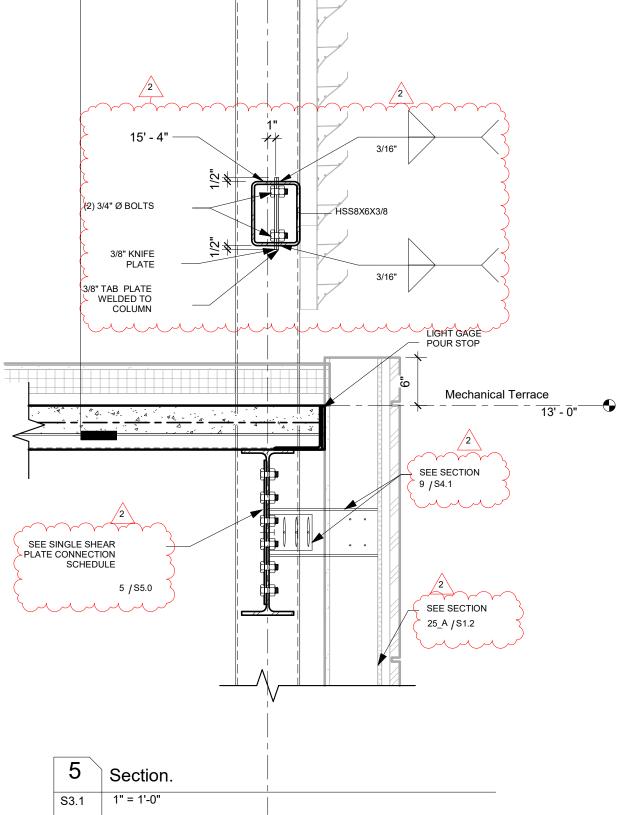
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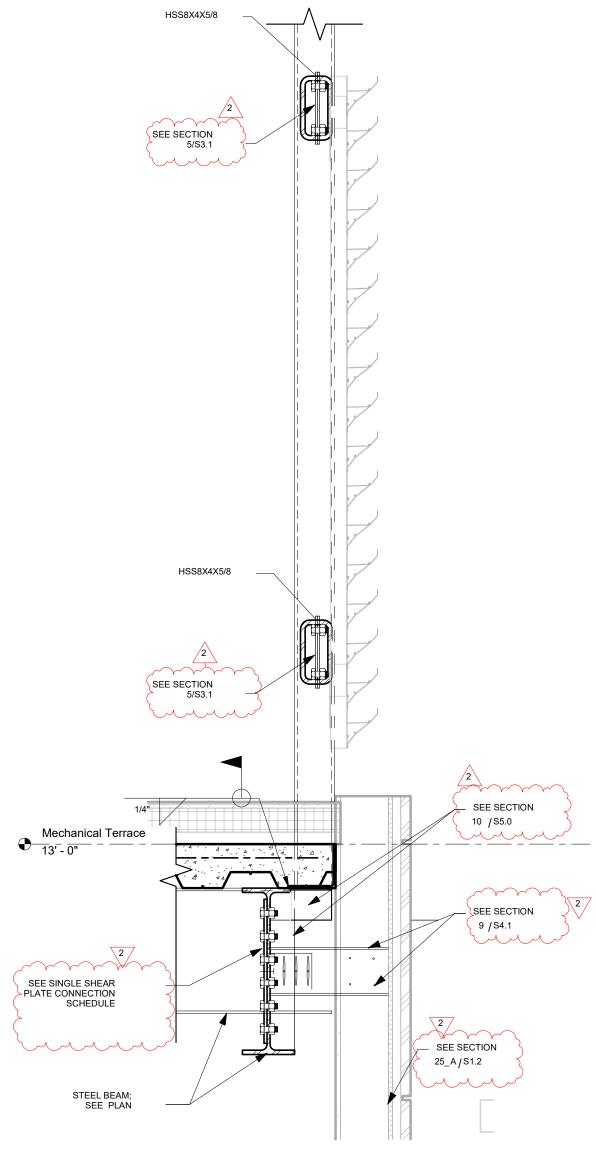
ENLARGED SECOND FLOOR AND LOW ROOF FRAMING PLAN II

DRAWN BY |<sup>Author</sup> S3.0.2

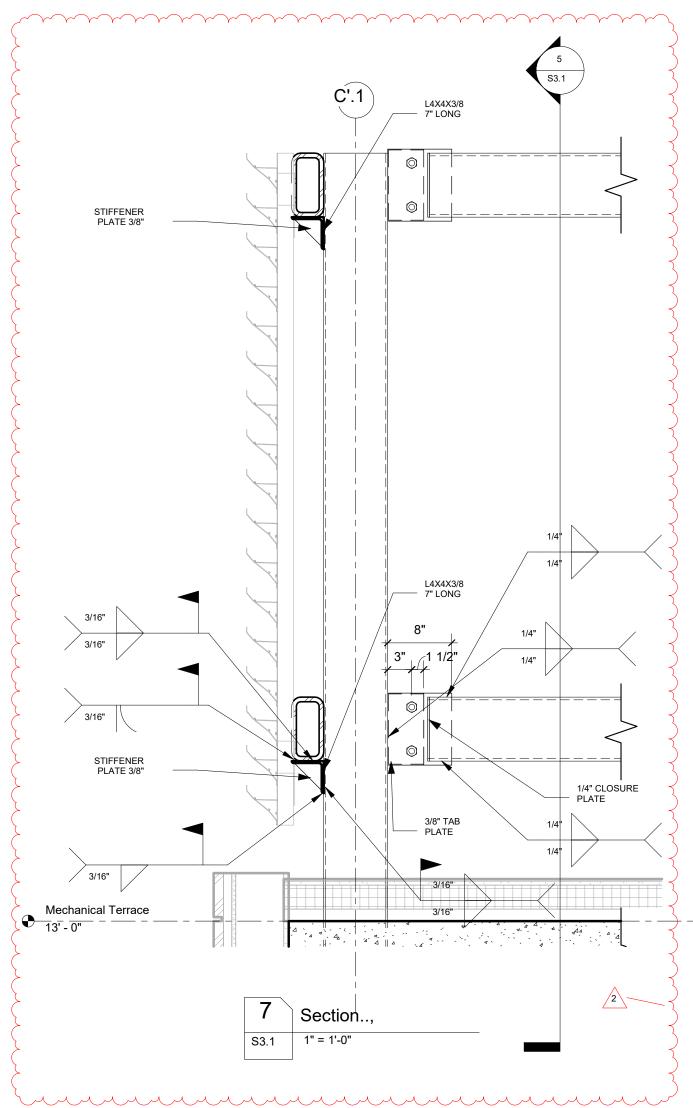


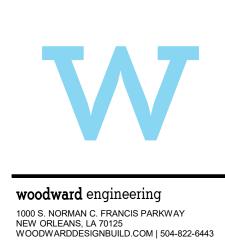






6 Section.. S3.1 1" = 1'-0"





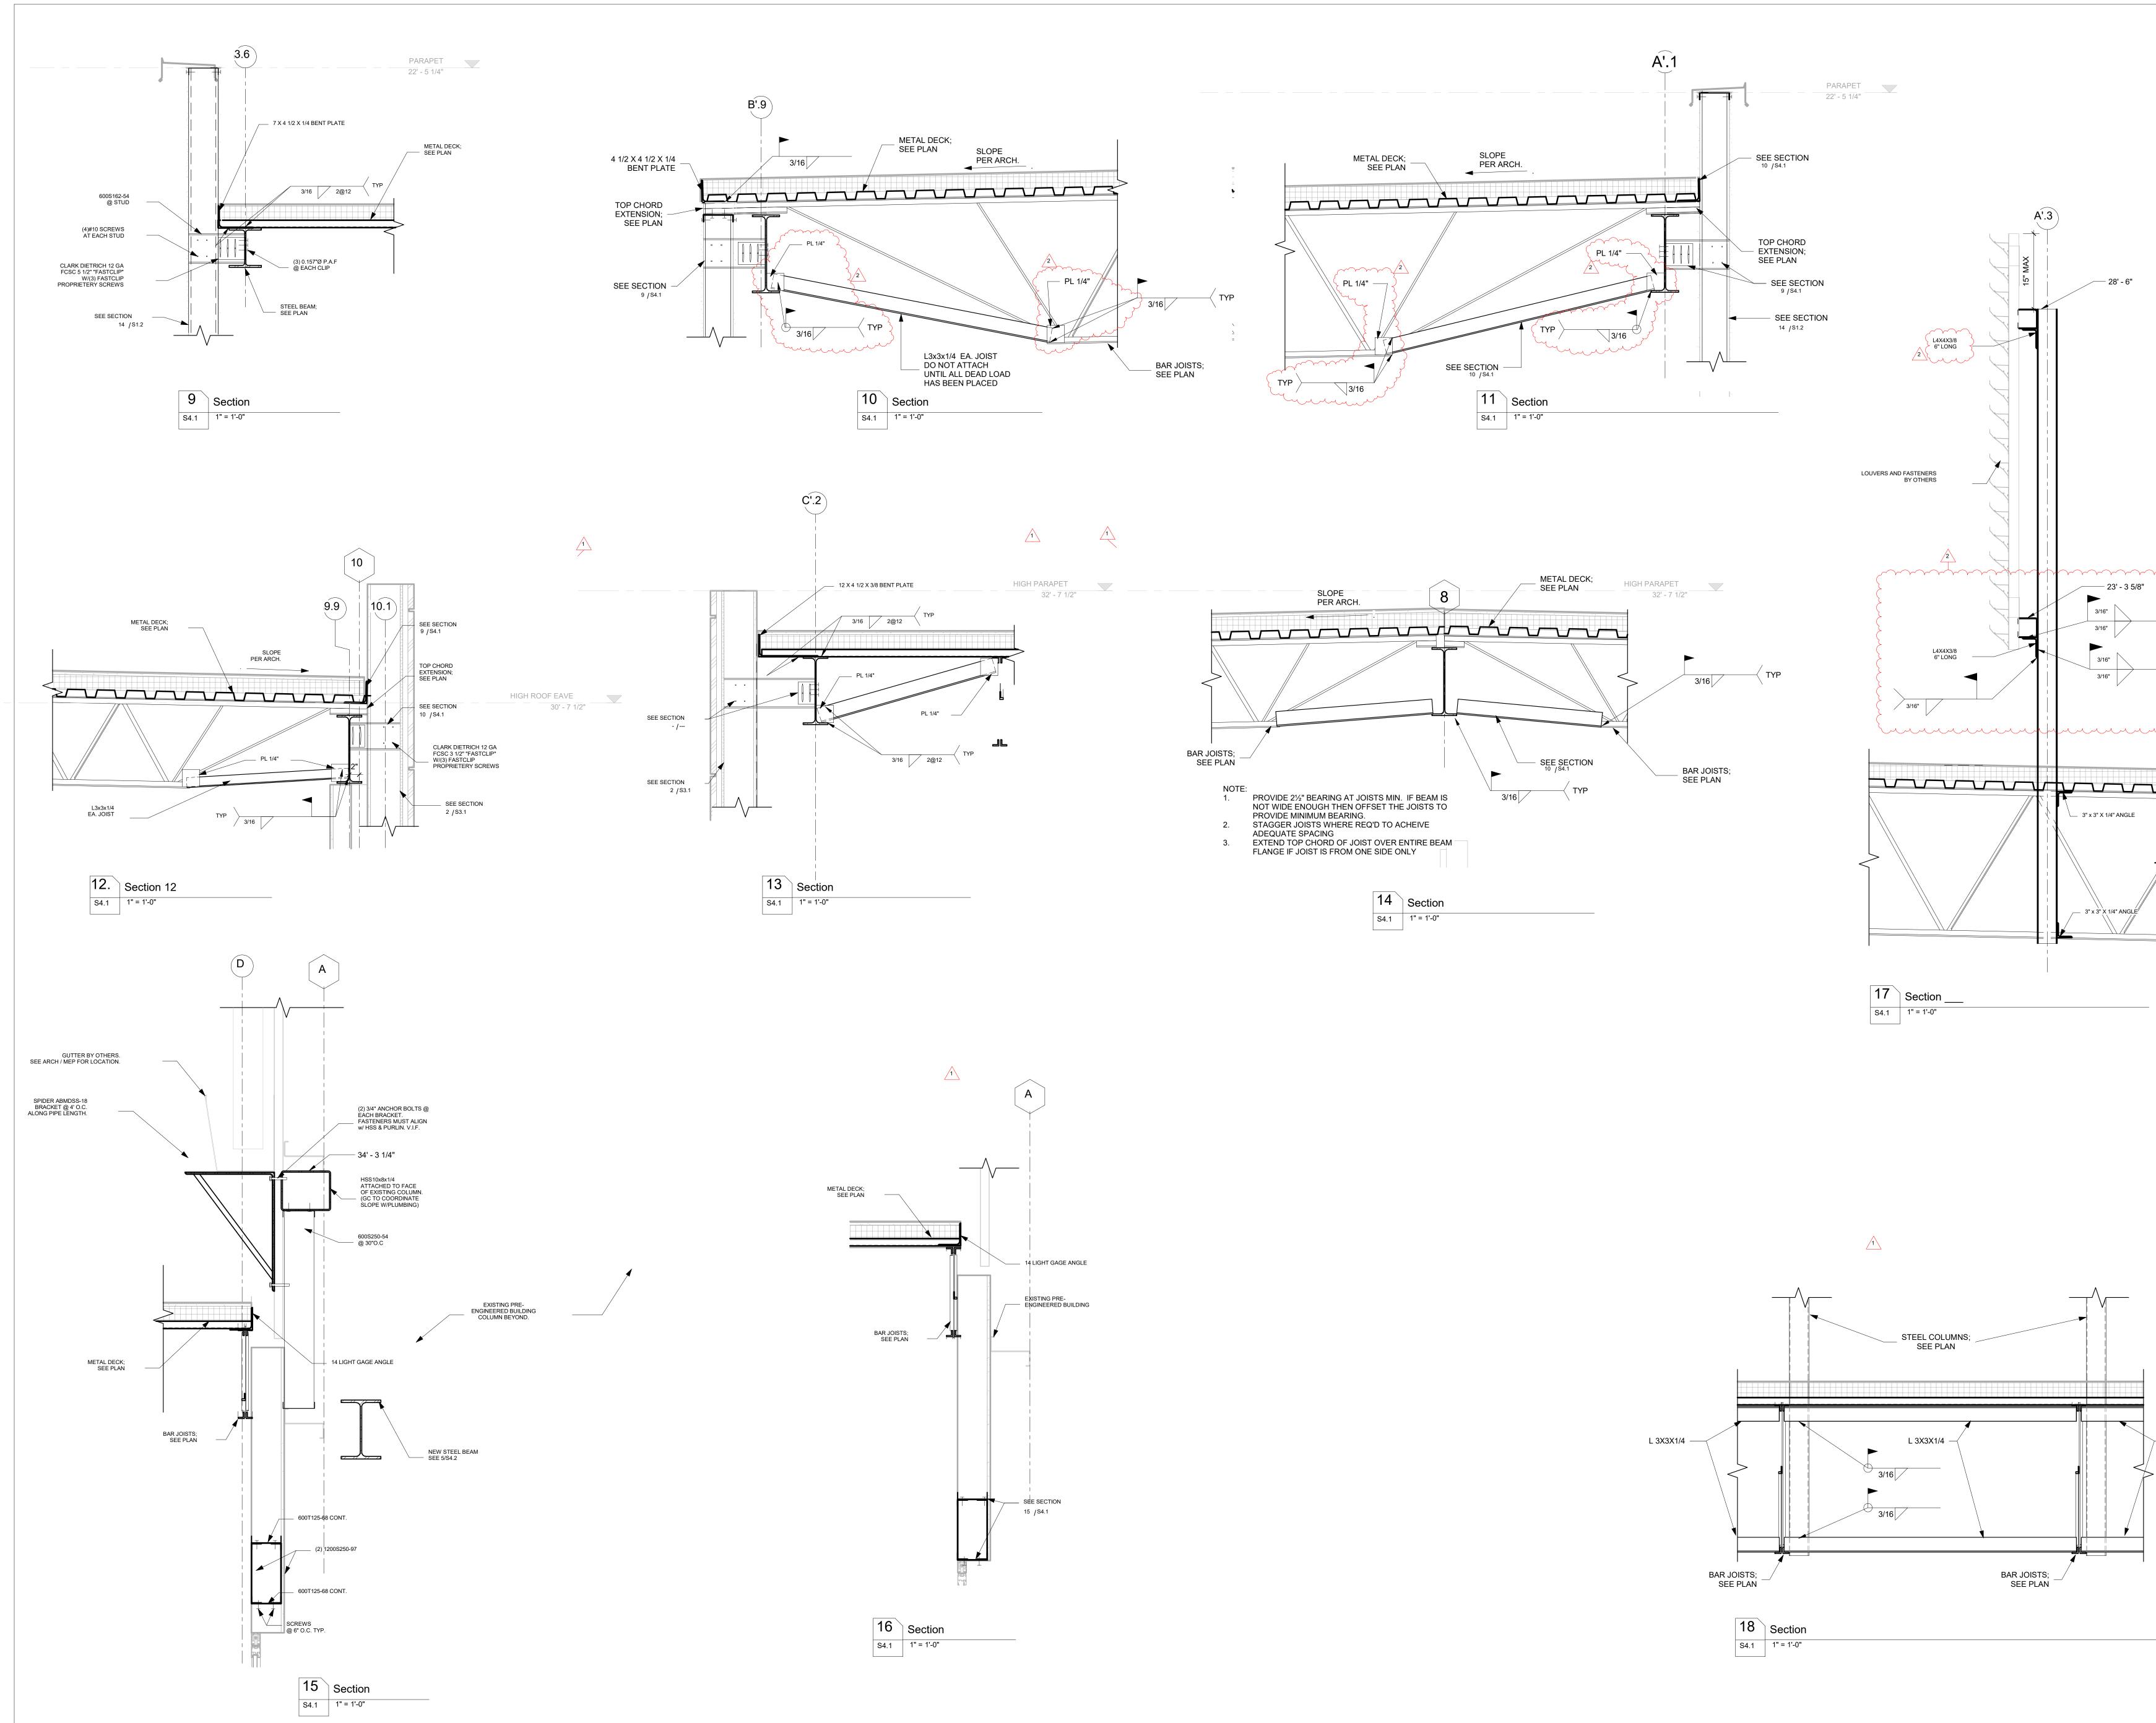
Nicholas Mannix, PE

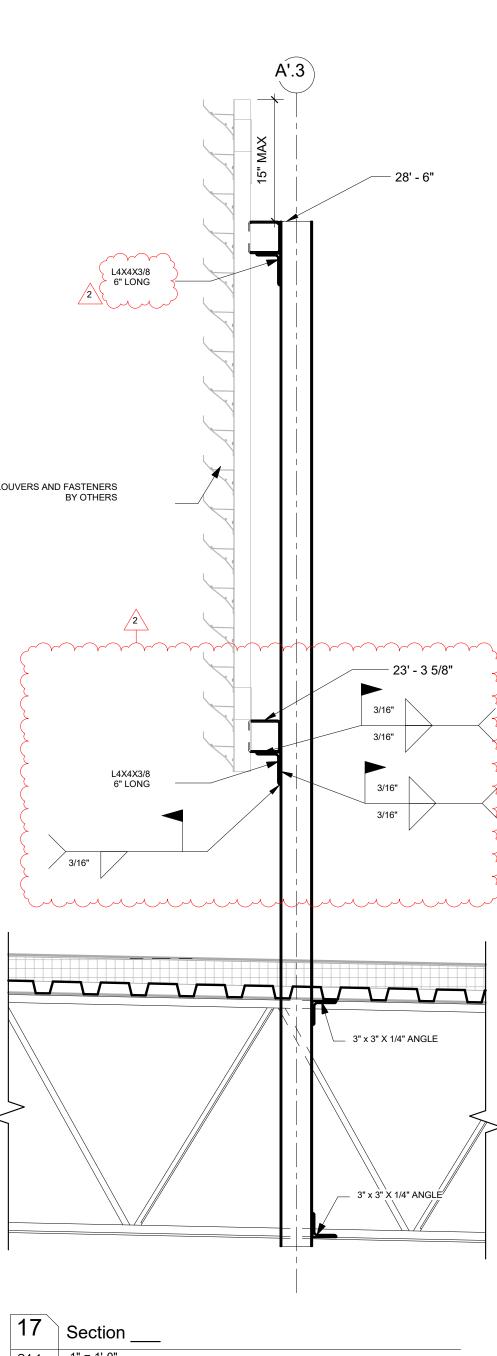
NEW ORLEANS SAINTS AND PELICANS CAFETERIA AND VIEWING AREA 5800 Airline Drive, Metairie, Louisiana

WDG PROJECT NO |EN2308

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DRAWN BY JAuthor S3.1







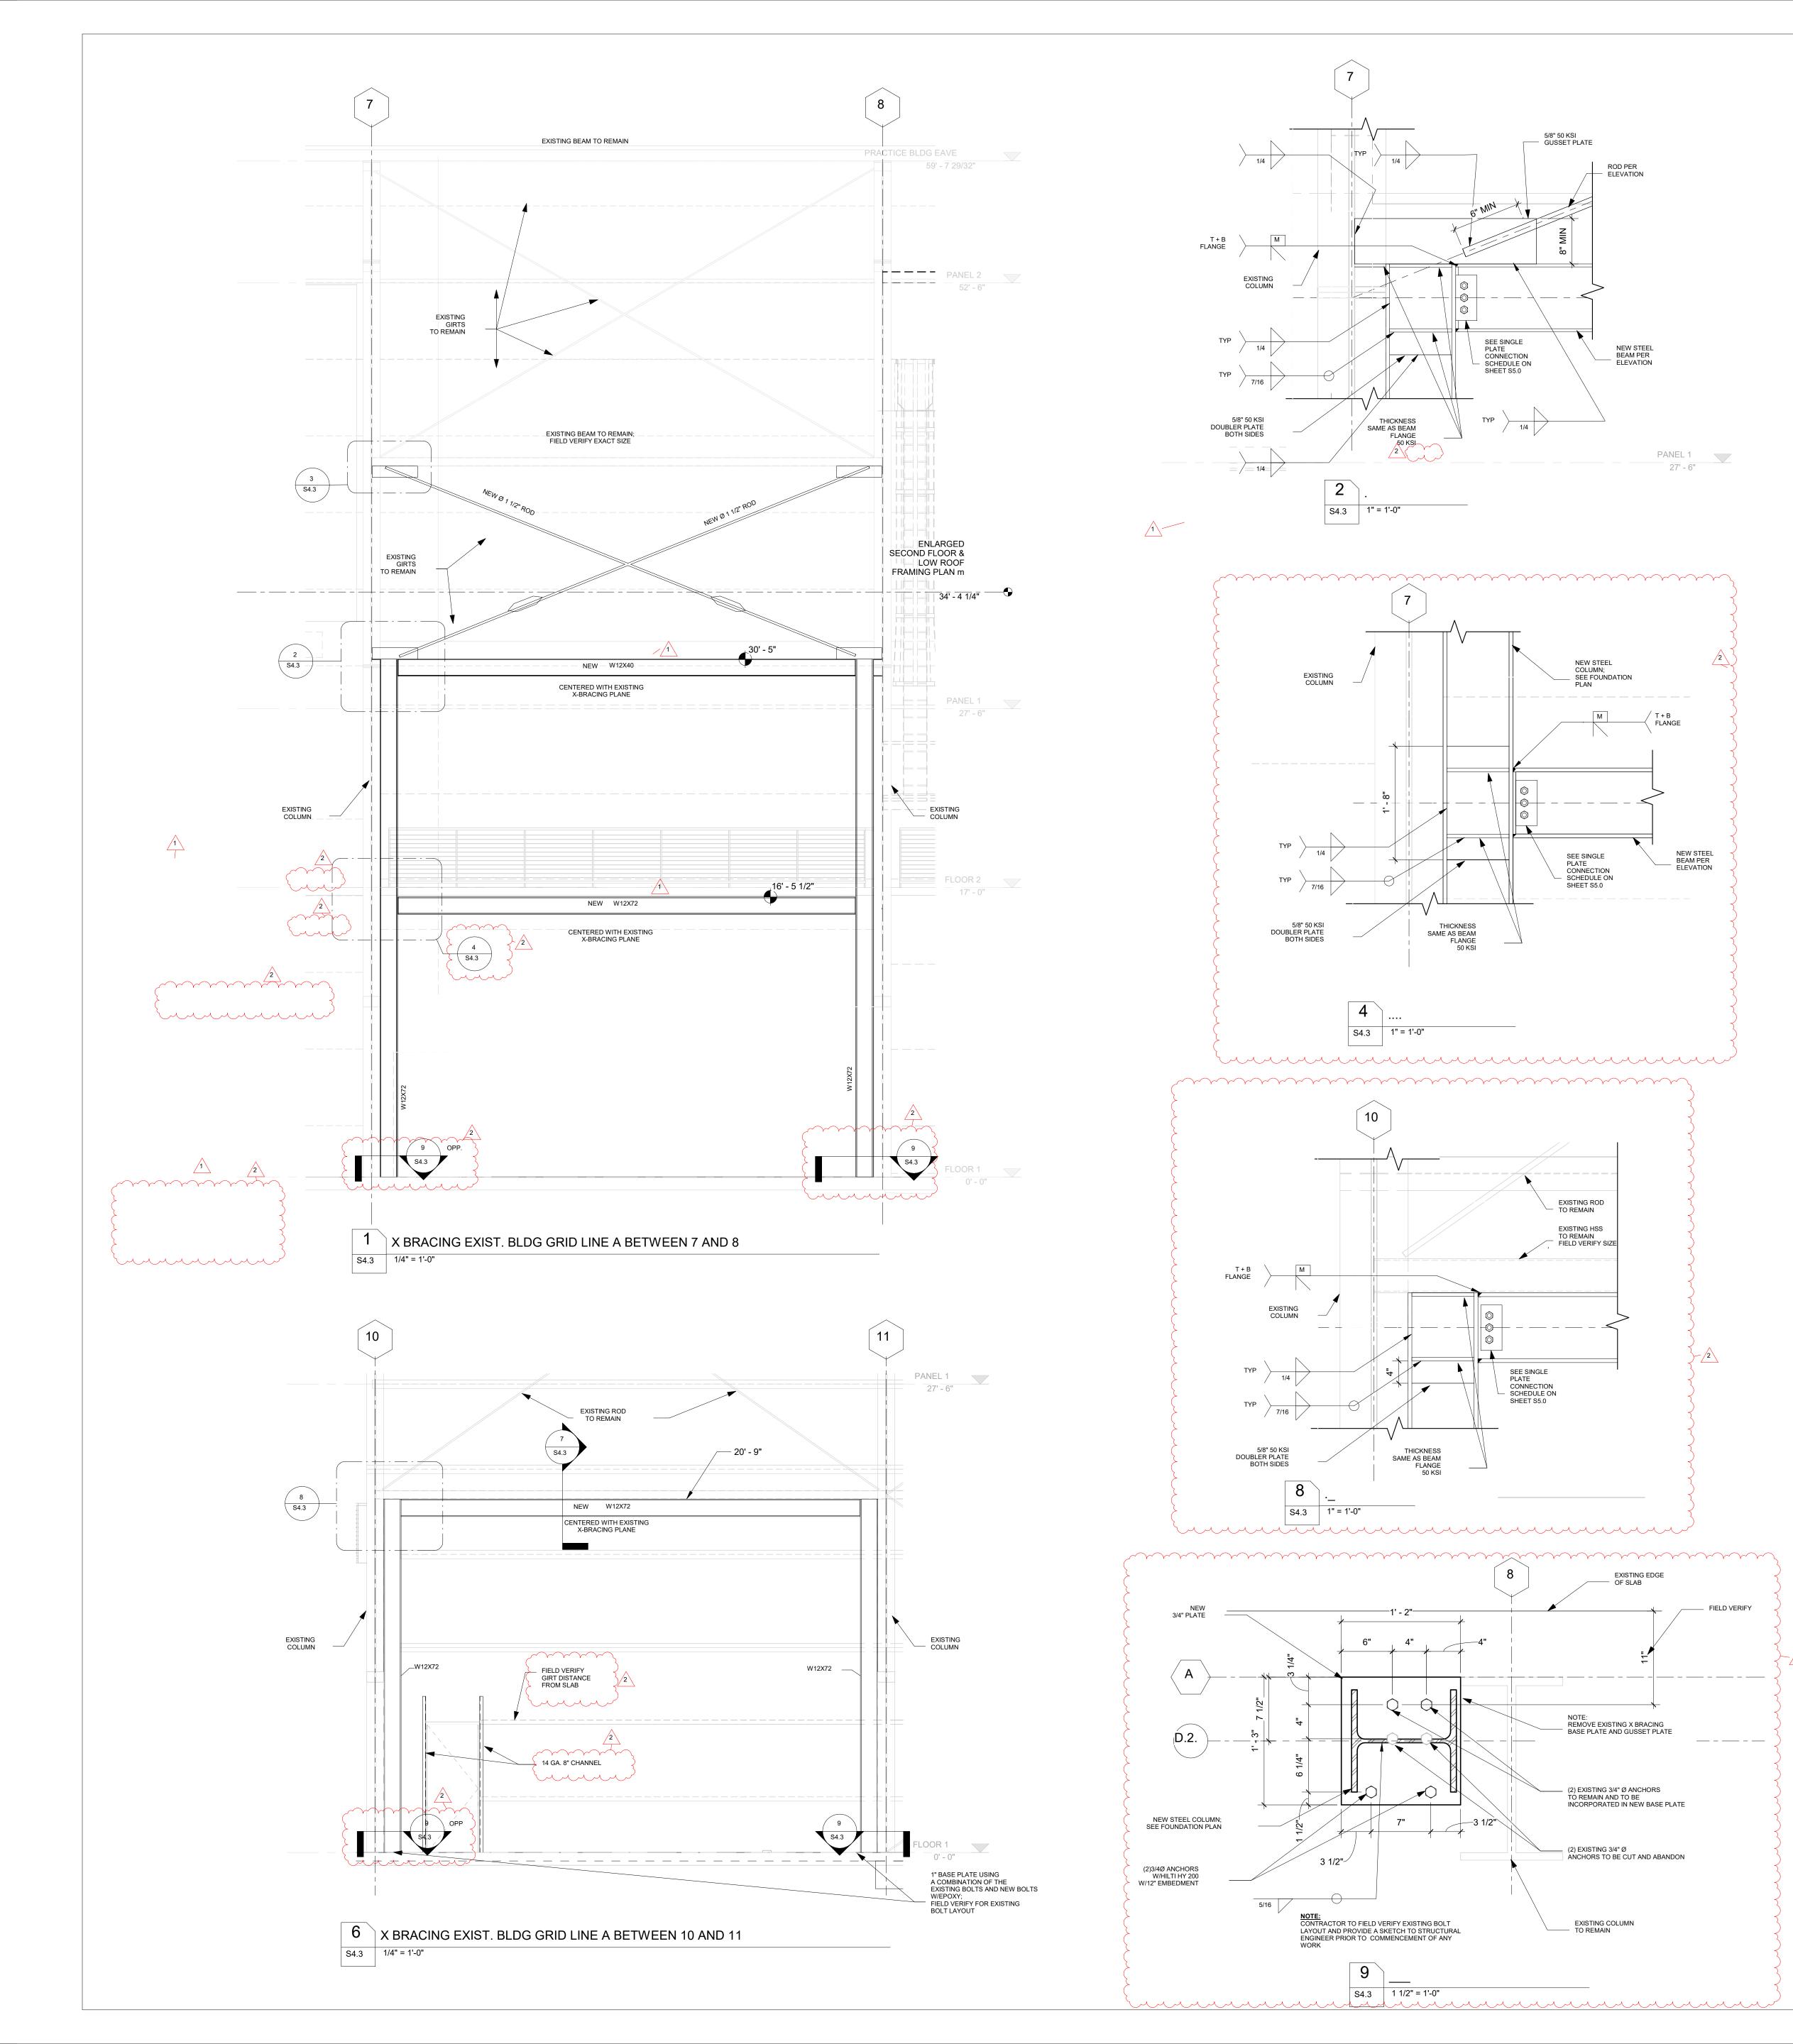
woodward engineering 1000 S. NORMAN C. FRANCIS PARKWAY NEW ORLEANS, LA 70125 WOODWARDDESIGNBUILD.COM | 504-822-6443 Nicholas Mannix, PE

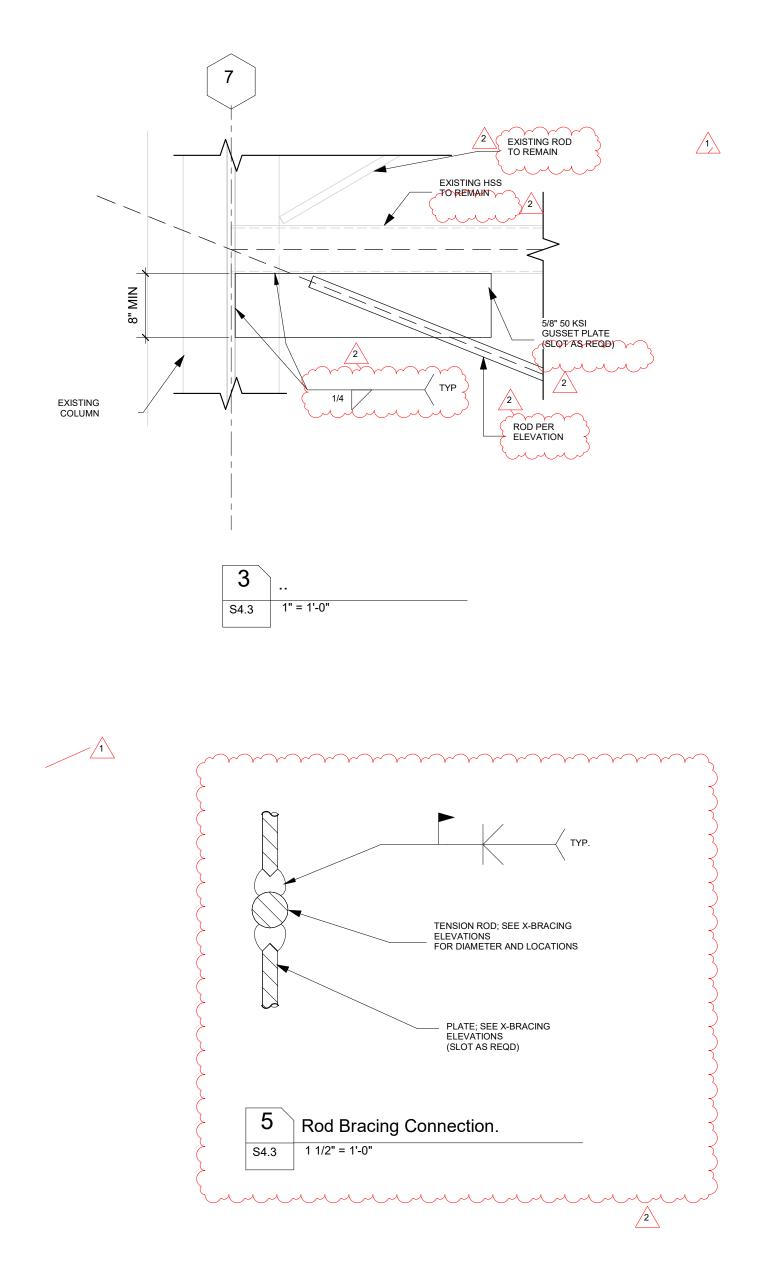
## NEW ORLEANS SAINTS AND PELICANS CAFETERIA AND VIEWING AREA 5800 Airline Drive, Metairie, Louisiana

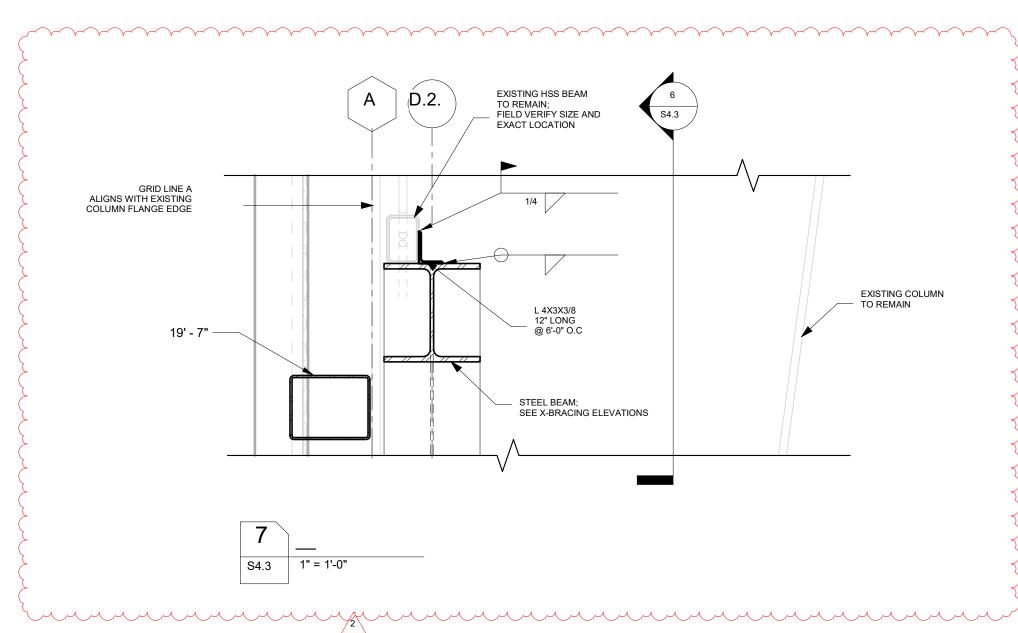
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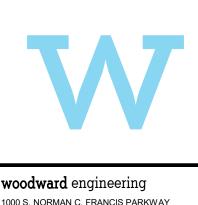
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