


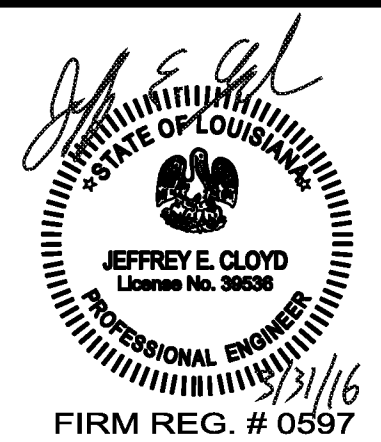

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WATERSTONE AT BATON ROUGE
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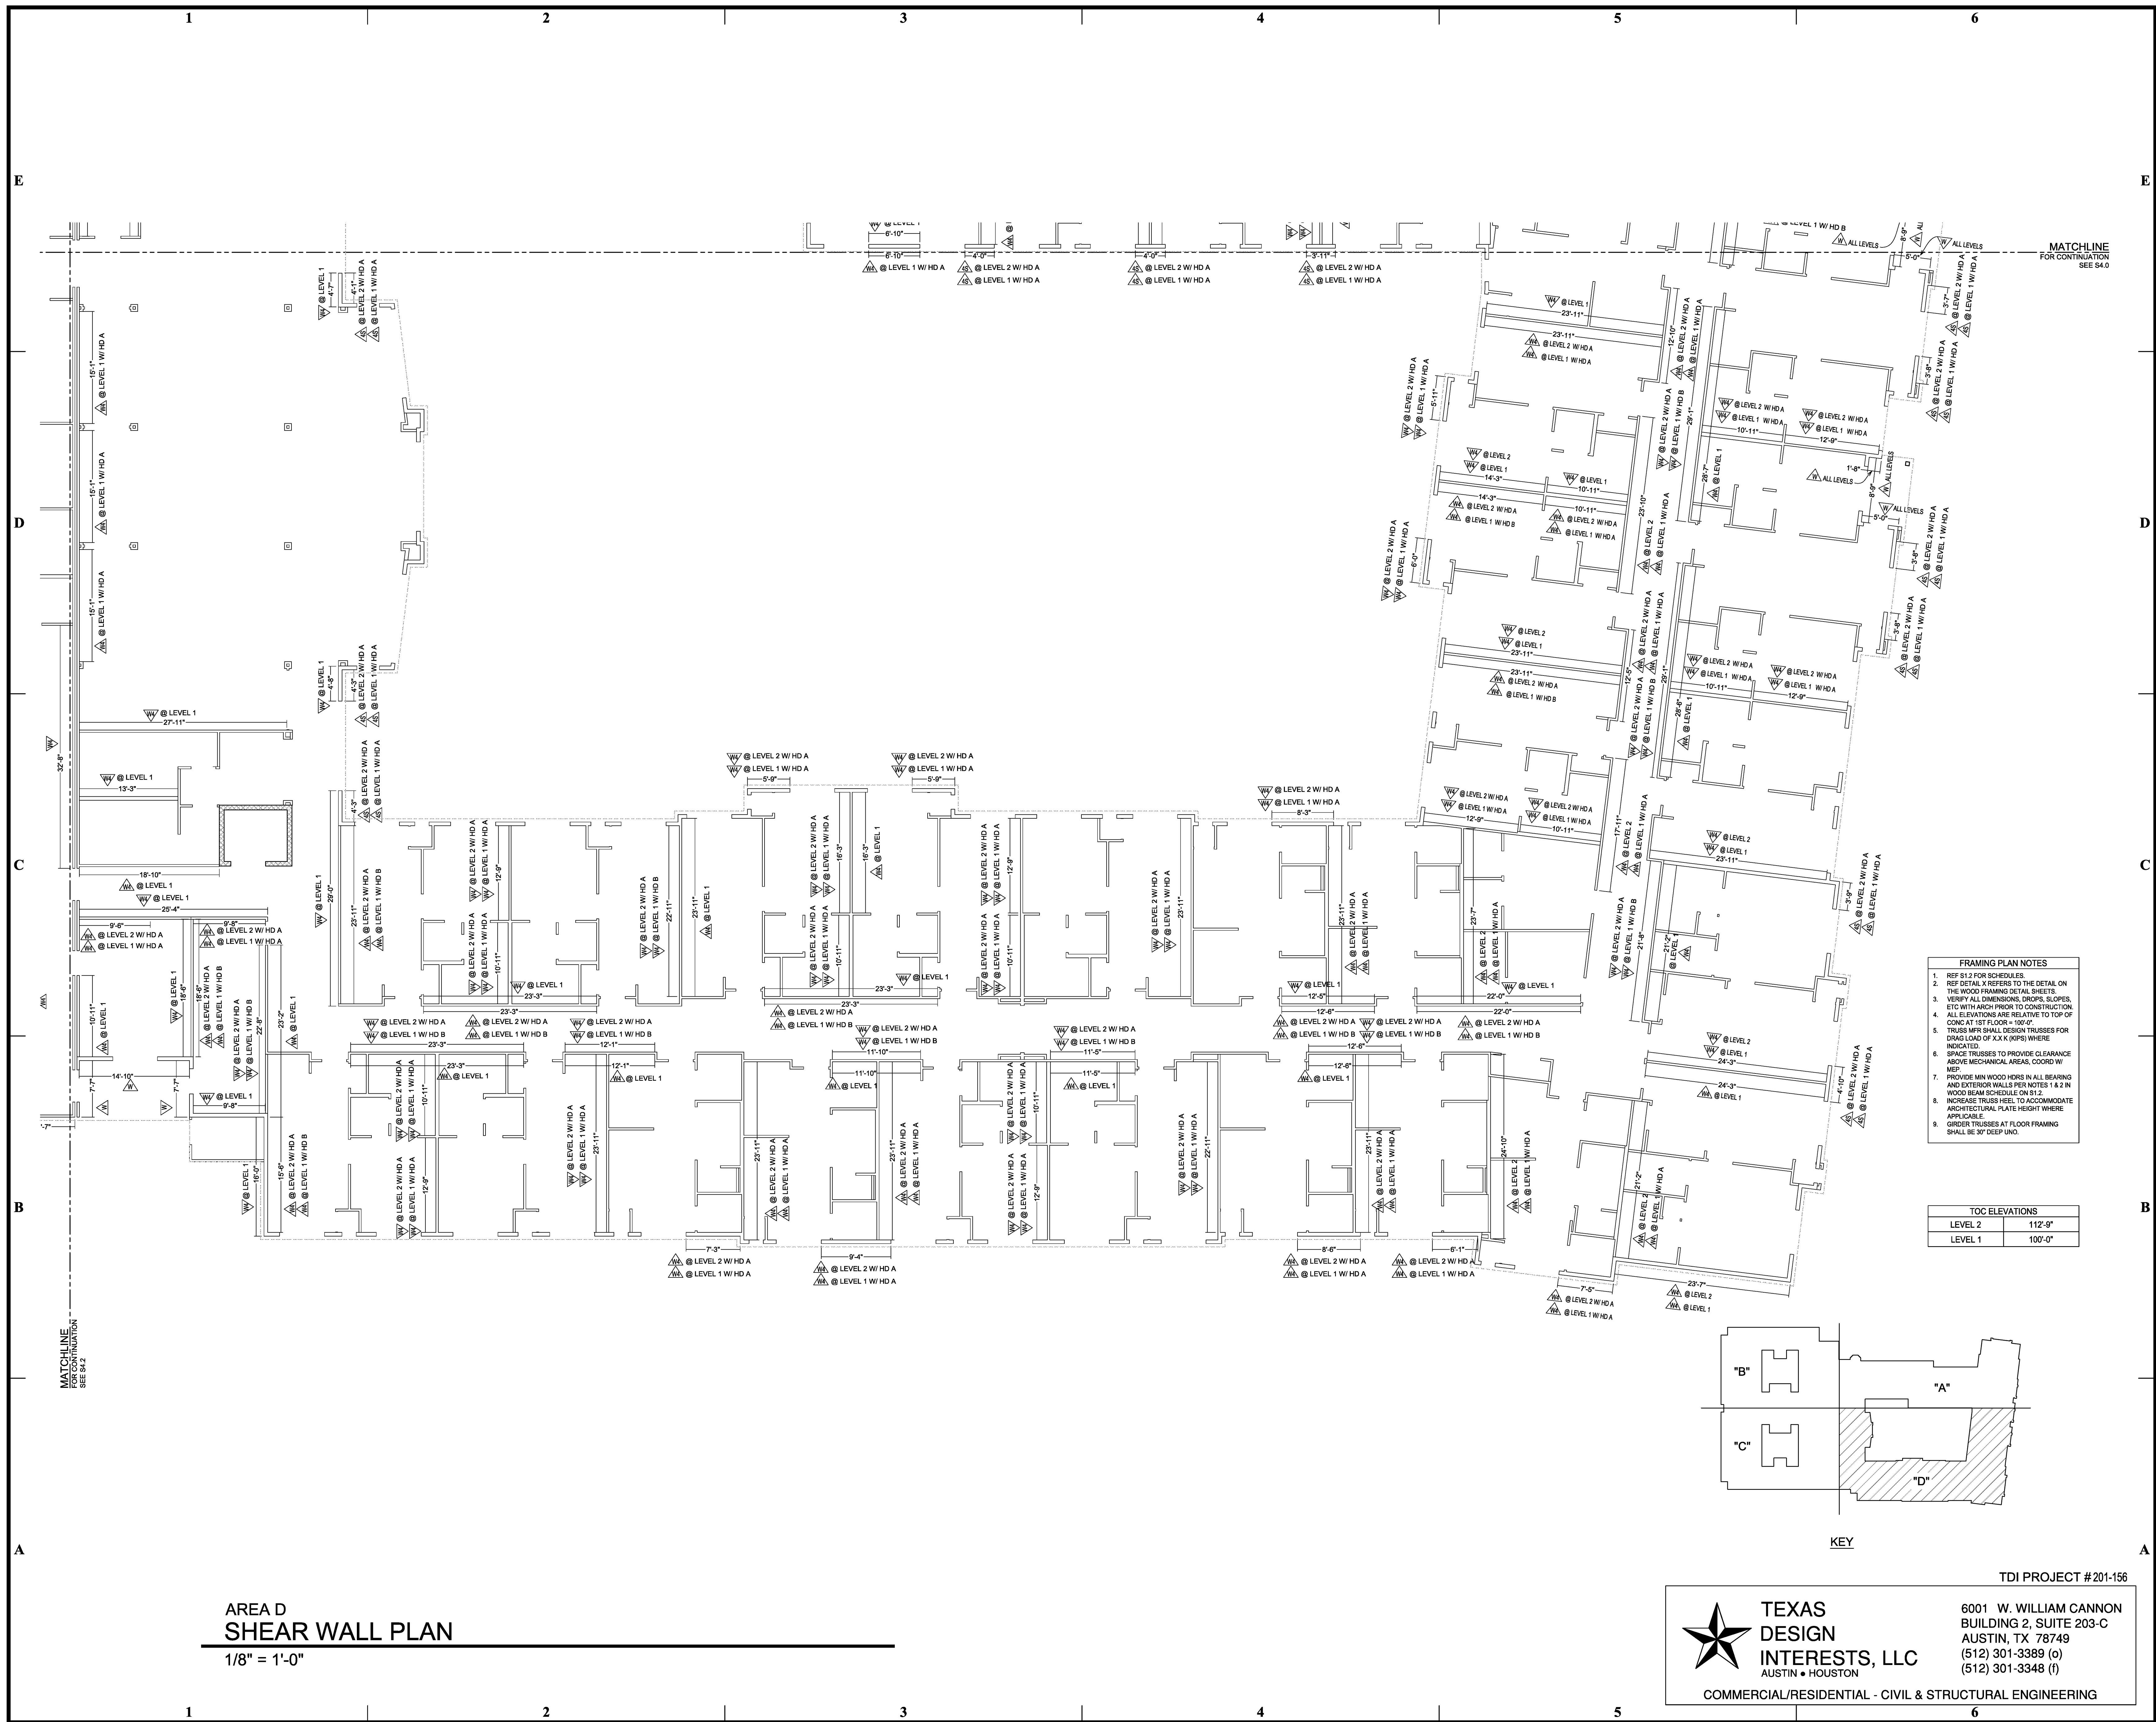
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REVISIONS:

DATE:
 3/31/2016
 PROJECT NUMBER:
 14017
 SHEET TITLE:
SHEARWALL PLAN

SHEET:

S4.3



- FRAMING PLAN NOTES**
- REF S1.2 FOR SCHEDULES.
 - REF DETAIL X REFERS TO THE DETAIL ON THE WOOD FRAMING DETAIL SHEETS.
 - VERIFY ALL DIMENSIONS, DROPS, SLOPES, ETC WITH ARCH PRIOR TO CONSTRUCTION. ALL ELEVATIONS ARE RELATIVE TO TOP OF CONC AT 1ST FLOOR = 100'-0".
 - TRUSS W/RS SHALL DESIGN TRUSSES FOR DEAD LOAD OF 2 X 4 RIPS WHERE INDICATED.
 - SPACE TRUSSES TO PROVIDE CLEARANCE ABOVE MECHANICAL AREAS. COORD W/ MEP.
 - PROVIDE MIN WOOD HRS IN ALL BEARING AND EXTERIOR WALLS PER NOTES 1 & 2 IN WOOD BEAM SCHEDULE ON S1.2.
 - INCREASE TRUSS HELL TO ACCOMMODATE ARCHITECTURAL PLATE HEIGHT WHERE APPLICABLE.
 - GIRDER TRUSSES AT FLOOR FRAMING SHALL BE 9" DEEP IUD.

TOC ELEVATIONS	
LEVEL 2	112'-9"
LEVEL 1	100'-0"

AREA D
SHEAR WALL PLAN
 1/8" = 1'-0"

TDI PROJECT #201-156

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