

- FRAMING PLAN NOTES**
1. REF S1.2 FOR SCHEDULES.
 2. REF DETAIL X REFERS TO THE DETAIL ON THE WOOD FRAMING DETAIL SHEETS.
 3. VERIFY ALL DIMENSIONS, PROPS, SLOPES, ETC WITH ARCH PRIOR TO CONSTRUCTION.
 4. ALL ELEVATIONS ARE RELATIVE TO TOP OF CONC AT 1ST FLOOR = 100'-0".
 5. TRUSS MFR SHALL DESIGN TRUSSES FOR DRAG LOAD OF X.X K (KIPS) WHERE INDICATED.
 6. SPACE TRUSSES TO PROVIDE CLEARANCE ABOVE MECHANICAL AREAS, COORD W/ ME.
 7. PROVIDE MIN WOOD HERS IN ALL BEARING AND EXTERIOR WALLS PER NOTES 1 & 2 IN WOOD BEAM SCHEDULE ON S1.2.
 8. INCREASE TRUSS HERT TO ACCOMMODATE ARCHITECTURAL PLATE HEIGHT WHERE APPLICABLE.
 9. GIRDER TRUSSES AT FLOOR FRAMING SHALL BE 30" DEEP LIND.

MATCHLINE
FOR CONTINUATION
SEE S3.4

TOC ELEVATIONS

LEVEL 2	112'-9"
LEVEL 1	100'-0"

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JEFFREY E. CLOUD
LICENSED PROFESSIONAL ARCHITECT
STATE OF LOUISIANA
EXPIRES 12/31/16
FIRM REG. # 0597

WATERSTONE AT BATON ROUGE
ASSISTED LIVING & MEMORY CARE

SIEGEN LANE
BATON ROUGE, LA 70810


ISSUE:
PERMIT SET

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REVISIONS:

DATE:
3/31/2016
PROJECT NUMBER:
14017
SHEET TITLE:
2ND FLR ROOF
FRM PLAN

SHEET:
S3.5

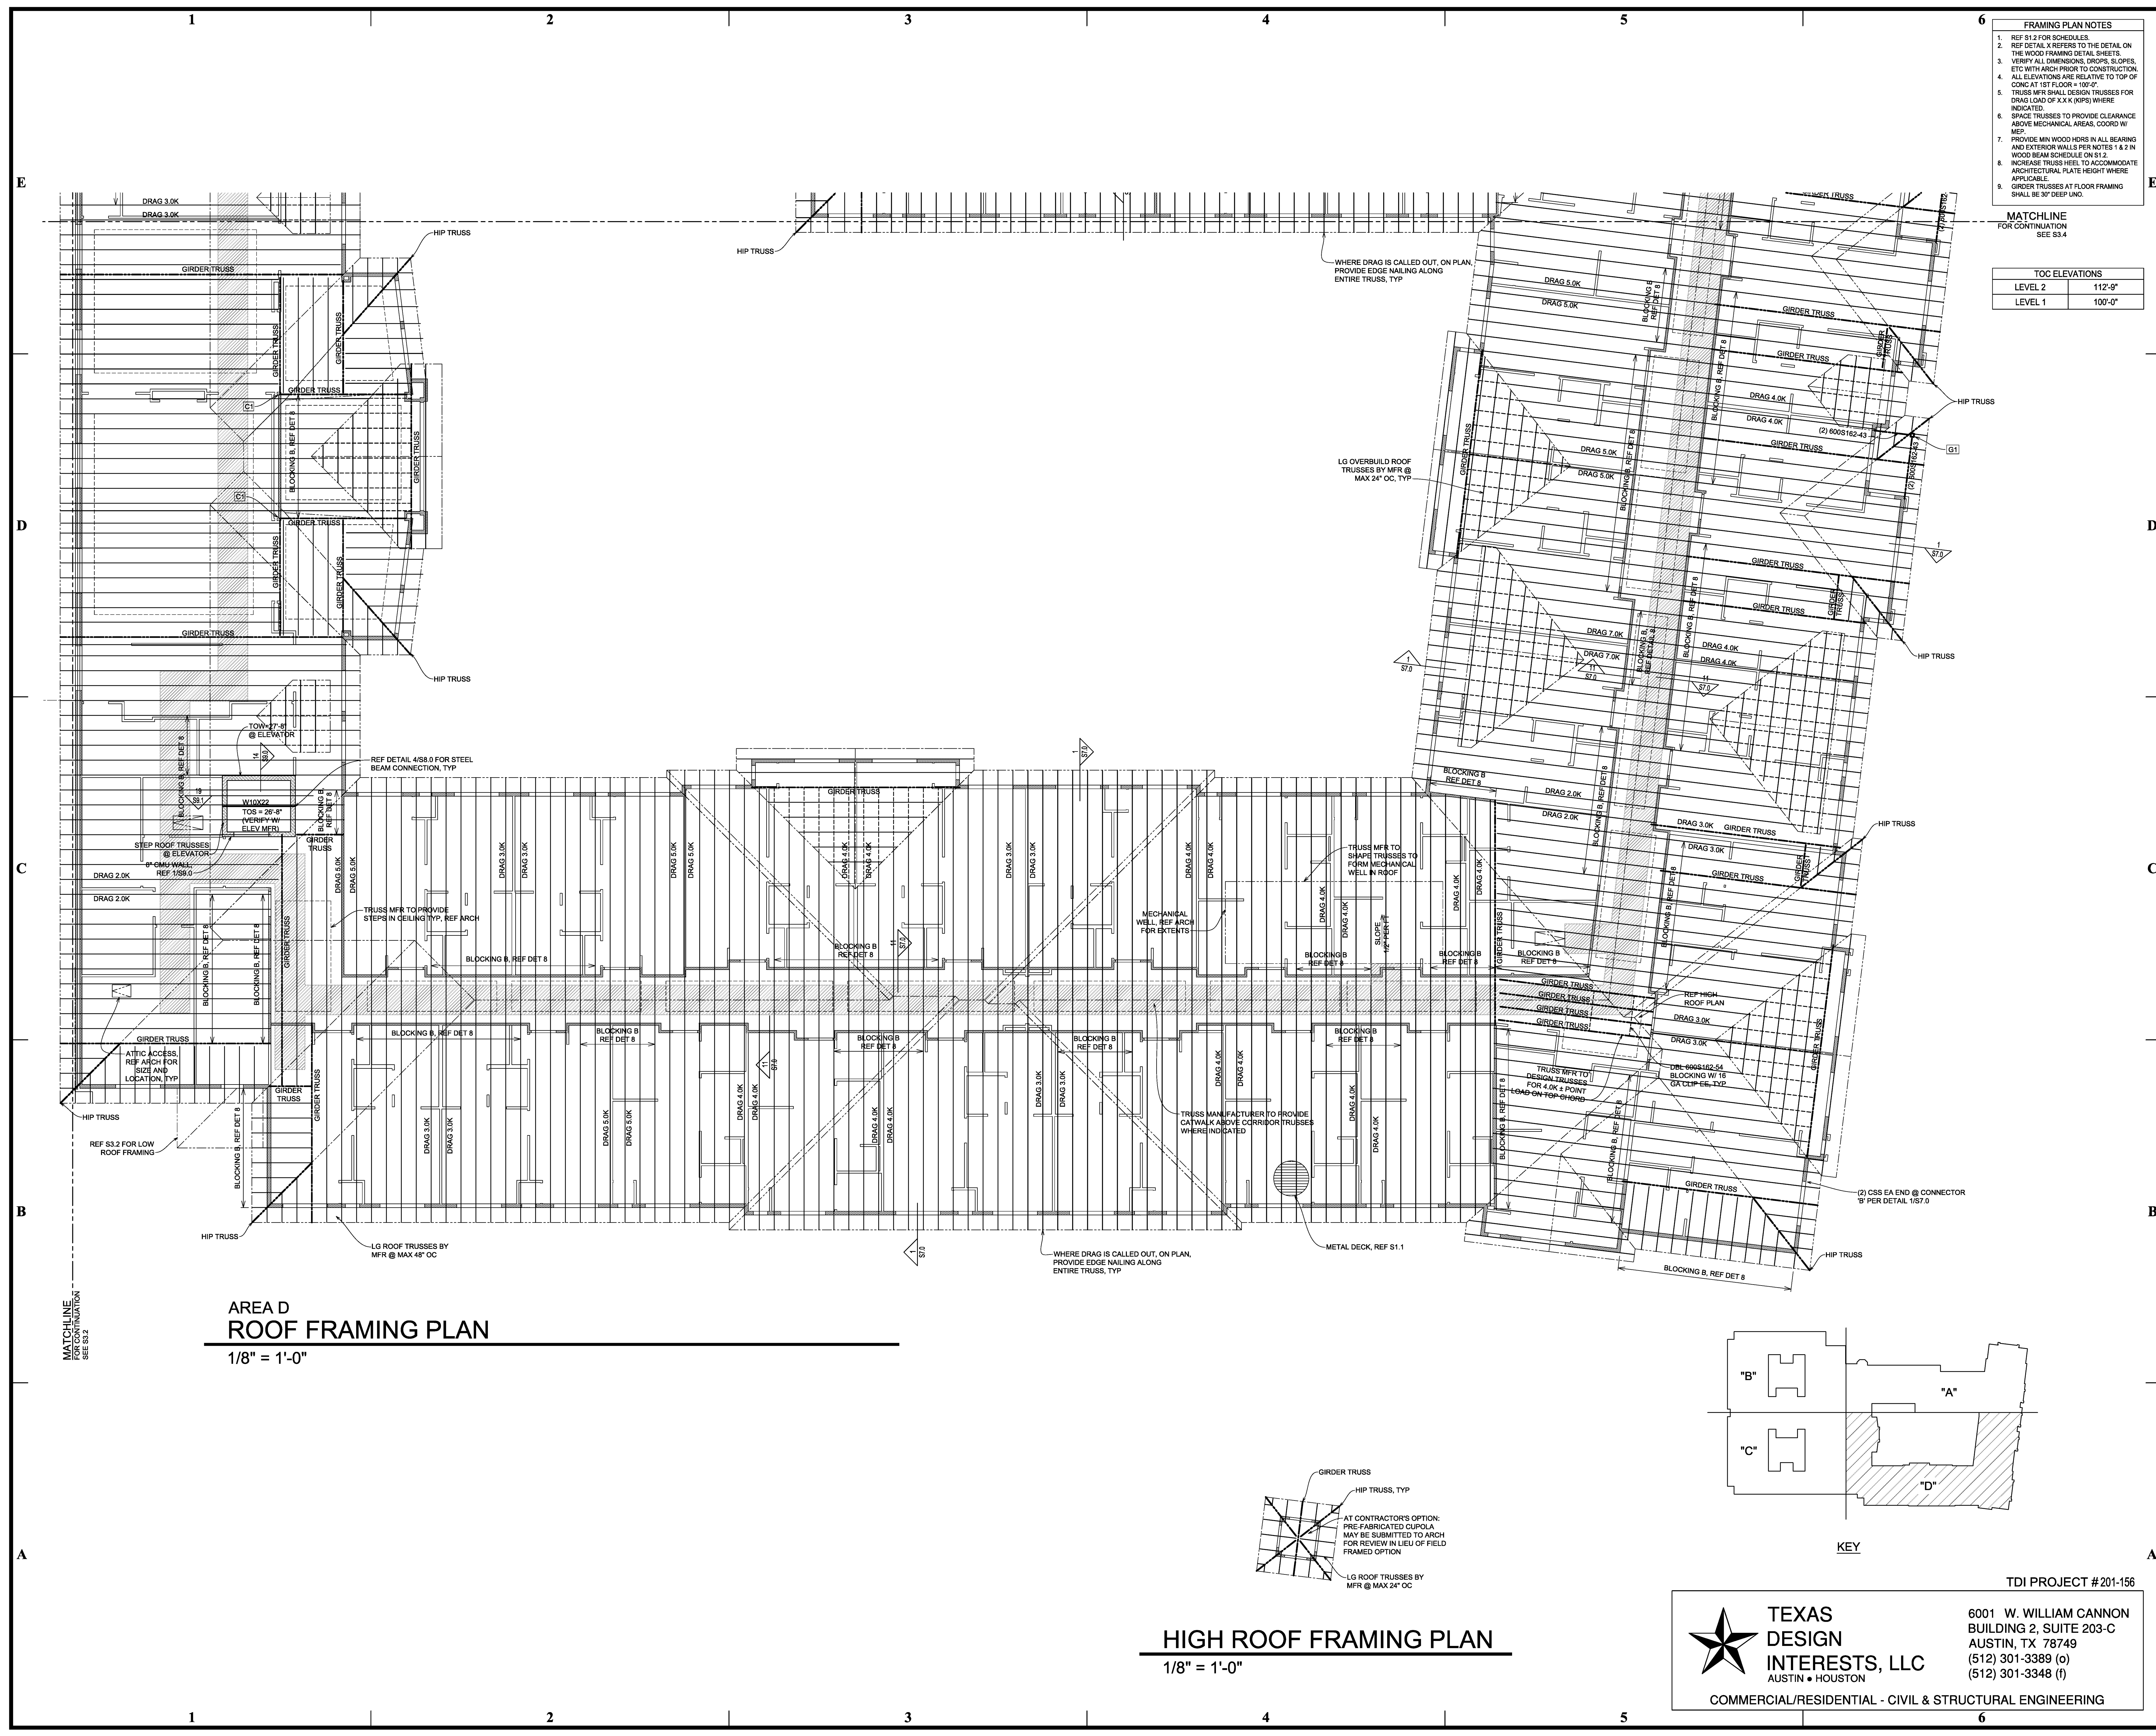

AREA D
ROOF FRAMING PLAN
1/8" = 1'-0"

HIGH ROOF FRAMING PLAN
1/8" = 1'-0"

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TDI PROJECT #201-156