


AREA C
ROOF FRAMING PLAN
 1/8" = 1'-0"

FRAMING PLAN NOTES


- REF S12 FOR SCHEDULES.
- REF DETAIL 4 REFERS TO THE DETAIL ON THE WOOD FRAMING DETAIL SHEETS.
- VERIFY ALL DIMENSIONS, DROPS, SLOPES, ETC WITH ARCH PRIOR TO CONSTRUCTION. ALL ELEVATIONS ARE RELATIVE TO TOP OF CONC AT 1ST FLOOR = 100'-0".
- TRUSS MFR SHALL DESIGN TRUSSES FOR DRAG LOAD OF 3.0 K KIPS WHERE INDICATED.
- SPRACE TRUSSES TO PROVIDE CLEARANCE ABOVE MECHANICAL AREAS, COORD W/ MEP.
- PROVIDE MIN WOOD HRS IN ALL BEARING AND EXTERIOR WALLS PER NOTES 1 & 2 IN WOOD BEAM SCHEDULE ON S12.
- INCREASE TRUSS HEEL TO ACCOMMODATE ARCHITECTURAL PLATE HEIGHT WHERE APPLICABLE.
- GIRDER TRUSSES AT FLOOR FRAMING SHALL BE 3" DEEP UNID.

TOC ELEVATIONS	
LEVEL 2	112'-9"
LEVEL 1	100'-0"

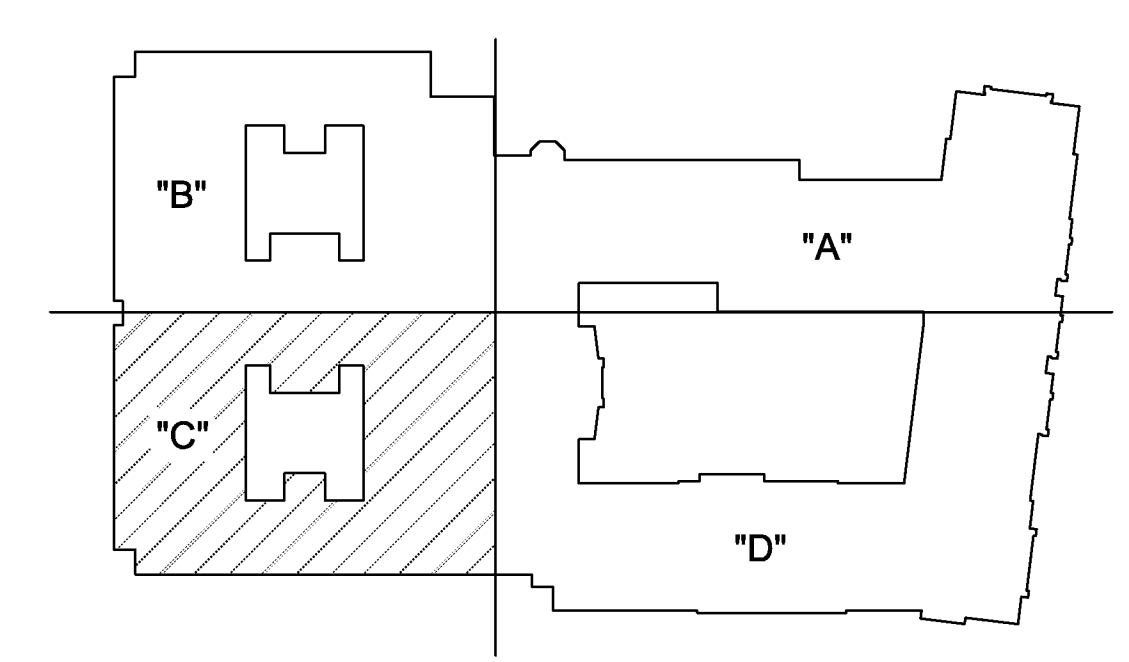


KEY

TDI PROJECT #201-156

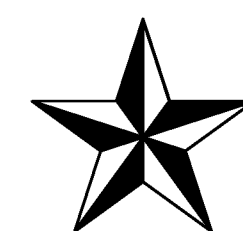


**TEXAS
 DESIGN
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WATERSTONE AT BATON ROUGE
ASSISTED LIVING & MEMORY CARE

SIEGEN LANE
 BATON ROUGE, LA 70810

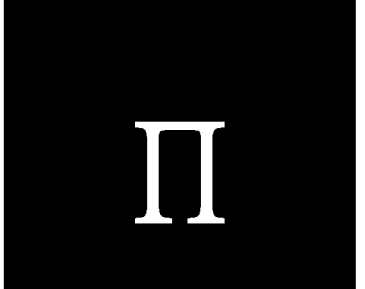ISSUE:
 PERMIT SET

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 REVISIONS:

DATE:
 3/31/2016
 PROJECT NUMBER:
 14017
 SHEET TITLE:
 1ST FLR ROOF
 FRM PLAN

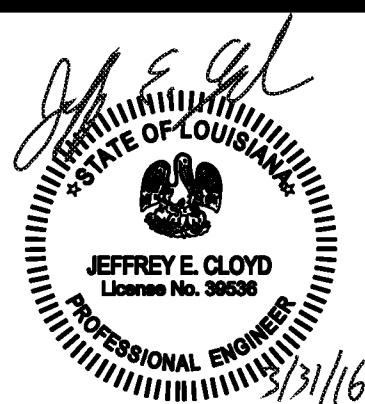SHEET:
S3.2